# TOWN OF YARROW POINT

KING COUNTY WASHINGTON

# TOWN WIDE STORMWATER AND UGC PROJECT



## **TOWN OFFICIALS**

KATY HARRIS

Mayor

STEPHAN LANGERHOLM

STEVE BUSH

**CHUCK PORTER** 

**Town Council** 

MICHAEL HYMAN

**KATHY SMITH** 

**Town Council** 

STACIA SCHROEDER, P.E

**TOWN ENGINEER** 

BONNIE RITTER

CLERK-TREASURER

BY: TOWN OF YARROW POINT

DATE: JANUARY 2024

APPROVAL EXPIRES: JANUARY 2025



JANUARY 2024 G&O JOB #23445





3710 168TH STREET NE, BLDG. B, SUITE 210 ARLINGTON, WASHINGTON 98223 (360) 454-5490 ADJ ALT ALTERNATE AMERICAN NATIONAL STANDARDS INSTITUTE ANSI ASPH ASPHALT ASTM AMERICAN SOCIETY OF TESTING AND MATERIALS

**BLOW OFF** ВО BOP **BEGINNING OF PROJECT** CONDUIT CATCH BASIN CB CUBIC FEET CF CFS CUBIC FEET PER SECOND

**AVENUE** 

BUILDING

CENTER

AVE

BLDG

CTR

CMP CORRUGATED METAL PIPE CO CLEANOUT CONC CONCRETE CONTINUED/CONTINUOUS CONT CPEP CORRUGATED POLYETHYLENE PIPE

CY CUBIC YARD CENTER LINE DUCTILE IRON DIAMETER DIA DIM DIMENSION DWGS DRAWING (S) EAST EACH EΑ **ELEVATION** ELECTRICAL ELEC EOP **END OF PROJECT** EX **EXISTING** FIG **FIGURE** FT FEET GΑ GAUGE GALV GALVANIZED

HIGH DENSITY POLYETHYLENE PIPE HDPE INSIDE DIAMETER ID INVERT ELEVATION IN INCH INV INVERT LENGTH POUND LB LINEAR FEET LF MAXIMUM MAX MFR MANUFACTURER

MH MANHOLE MINIMUM MIN MISC MISCELLANEOUS NORTH NO NUMBER NTS NOT TO SCALE OC ON CENTER OD OUTSIDE DIAMETER PERF PERFORATED POWER POLE PVC POLYVINYL CHLORIDE PAVEMENT **PVMT** QUANTITY QTY RADIUS

R/W RIGHT-OF-WAY REINF REINFORCE RR RAILROAD SOUTH SCH SCHEDULE SF SQUARE FEET SHT SHEET SQUARE SQ STA STATION STANDARD STD TOP OF CURB

TELEPHONE TEL TESC TEMPORARY EROSION AND SEDIMENT CONTROL TYP

TYPICAL UGC UNDERGROUND CONVERSION VERT VERTICAL WEST

WITH

SHEET#

1

3

6 - 13

14-17

18 - 25

26 - 27

28 - 35

36

37 - 40

PSE 1

PSE INTOLIGHT 1

COMCAST 1 - COMCAST 4

WITHOUT W/O WASHINGTON STATE DEPARTMENT OF TRANSPORTATION WSDOT

#### **EXISTING LEGEND**

SURFACE FEATURES	DESCRIPTION	SYMBOLS	DESCRIPTION	SYMBOLS	DESCRIPTION
	CENTER LINES	$\bowtie$	WATER VALVE	$\langle \rangle$	TRAFFIC SIGNAL POLE
	RIGHT-OF-WAY LINES		HYDRANT	→	STREET LIGHT
<u> </u>	LOT LINES	Q	FDC		LUMINAIRE(DOUBLE)
W	WATER LINE		POST INDICATOR VALVE	₩0	LUMINAIRE(SINGLE)
· · · ·	DITCH LINE				
	SANITARY SEWER LINE	4	WATER BLOW OFF	<b>ŏ</b> -ı	PEDESTRIAN LIGHT POLE
D	STORM DRAIN LINE	⊞	WATER METER	\$	AREA LIGHT
	GAS LINE		IRR. CONTROL VALVE		GAS METER
UP	UNDERGROUND POWER LINES	(S) (D)	MANHOLES (SS/SD)		GAS VALVE
	UNDERGROUND COMMUNICATION LINES		СВ	Д	SIGN
COM	(COMCAST/LUMEN)	$\triangle$	POWER TRANSFORMER		MAILBOX
——————————————————————————————————————	OVERHEAD UTILITY LINES	PC	POWER/COMM. VAULT	NP	NEWS PAPER BOX
OHW	HIGH WATER LINE	WU	WATER/UTILITY VAULT	(TC)	TRASH CAN
_ o o o o o	CHAIN LINK FENCE				ROCKERY
x x x x x	WIRE FENCE	P	POWER MANHOLE		SPOT ELEVATION
	WOOD FENCE		COMM. MANHOLE	×	
	EDGE OF ASPHALT	$\circ$	WATER MANHOLE		SIZE & TYPE (CONIFEROUS TREE)
	25 32 31 7(31 1)/(21		POWER METER		SIZE & TYPE (DECIDUOUS TREE)
			SURFACE JUNCTION BOX	×	MAGNETIC NAIL W/ WASHER
			SUBSURFACE JUNCTION BOX	•	REBAR AND CAP (SET)
		-0-	POWER/UTILITY POLE	<b>©</b>	REBAR AND CAP (FOUND)
		-\$-	POWER/UTILITY POLE W/DROP	×	TACK AND LEAD
		•-	ANCHOR POLE		HUB AND TACK
		$\leftarrow$	GUY ANCHOR	•	CASED MONUMENT
					SURFACE MONUMENT

#### PROPOSED LEGEND

SURFACE FEATURES	DESCRIPTION
	ASPHALT PAVEMENT
	ASPHALT W / WEDGE CURB
	GRAVEL SURFACING
· · ·	CENTERLINE OF CONSTRUCTION
	SAWCUT LINE (APPROXIMATE LOCATION)
——— Е ———	BURIED ELECTRICAL (PSE)
——— т ———	BURIED TELEPHONE (LUMEN)
TV	BURIED CABLE TELEVISION (COMCAST)
JT	JOINT TRENCH
D	STORM DRAIN (SIZE AS NOTED)

GAS/POWER/TELEPHONE/CABLE SYMBOLS

**DESCRIPTION** 

SEE UTILITY UNDERGROUND STRUCTURE LEGEND, SHEET 18

#### PROPOSED SANITARY/STORM SEWER SYMBOLS

STORM DRAIN MANHOLE/TYPE 2 CATCH BASIN (ACTUAL DIMENSION SHOWN FOR PROPOSED)

STORM DRAIN CATCH BASIN, CONCRETE INLET, OR YARD/AREA DRAIN (ACTUAL DIMENSION SHOWN FOR PROPOSED)

#### PROPOSED SURFACE FEATURES/LANDSCAPING





SIGN ROCKERY

TIMBER EDGING

## **ORDER OF WORK**

- 1. ATTEND PRECONSTRUCTION MEETING
- 2. PROVIDE MATERIAL SUBMITTALS
- 3. COORDINATE W/ PSE, COMCAST AND LUMEN TO ORDER UNDERGROUND CONVERSION MATERIALS
- 4. CALL FOR UTILITY LOCATES
- 5. INSTALL TRAFFIC CONTROL AND EROSION CONTROL DEVICES
- 6. PERFORM POTHOLING OPERATIONS
- 7. CONSTRUCT UNDERGROUND UTILITY FACILITIES ( SEE EAGLE TAKE PERMIT FOR CONSTRUCTION SCHEDULE RESTRICTIONS)
- 8. PSE, COMCAST AND LUMEN TO PULL CONDUCTORS, ENERGIZE THEIR FACILITIES, AND WRECK OUT EXISTING OVERHEAD FACILITIES. (CONTRACTOR SHALL PROVIDE 2 WEEK ADVANCE NOTICE TO UTILITIES) NOTE: UTILITIES WILL BE SUBJECT TO THE TOWN'S EAGLE PERMIT REQUIREMENTS AS WELL
- 9. CONSTRUCT STORM IMPROVEMENTS (TO BE COMPLETED IN CONJUNCTION WITH UTILITY WORK, CONTRACTOR TO COORDINATE) (SEE EAGLE TAKE PERMIT FOR CONSTRUCTION SCHEDULE RESTRICTIONS)
- 10. RESTORE PAVED AND CONCRETE SURFACES (STREET AND DRIVEWAYS)
- 11. PROPERTY RESTORATION
- 12. SUBMIT RECORD DRAWINGS

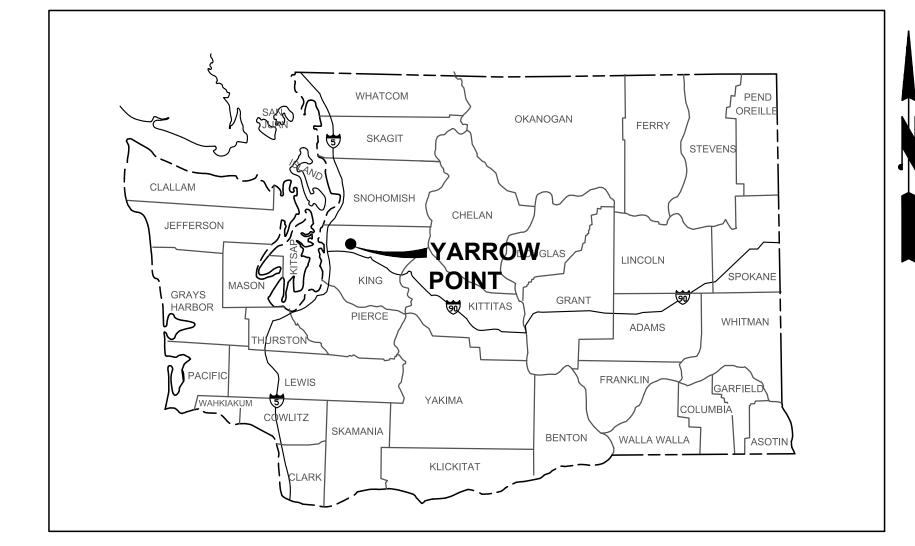

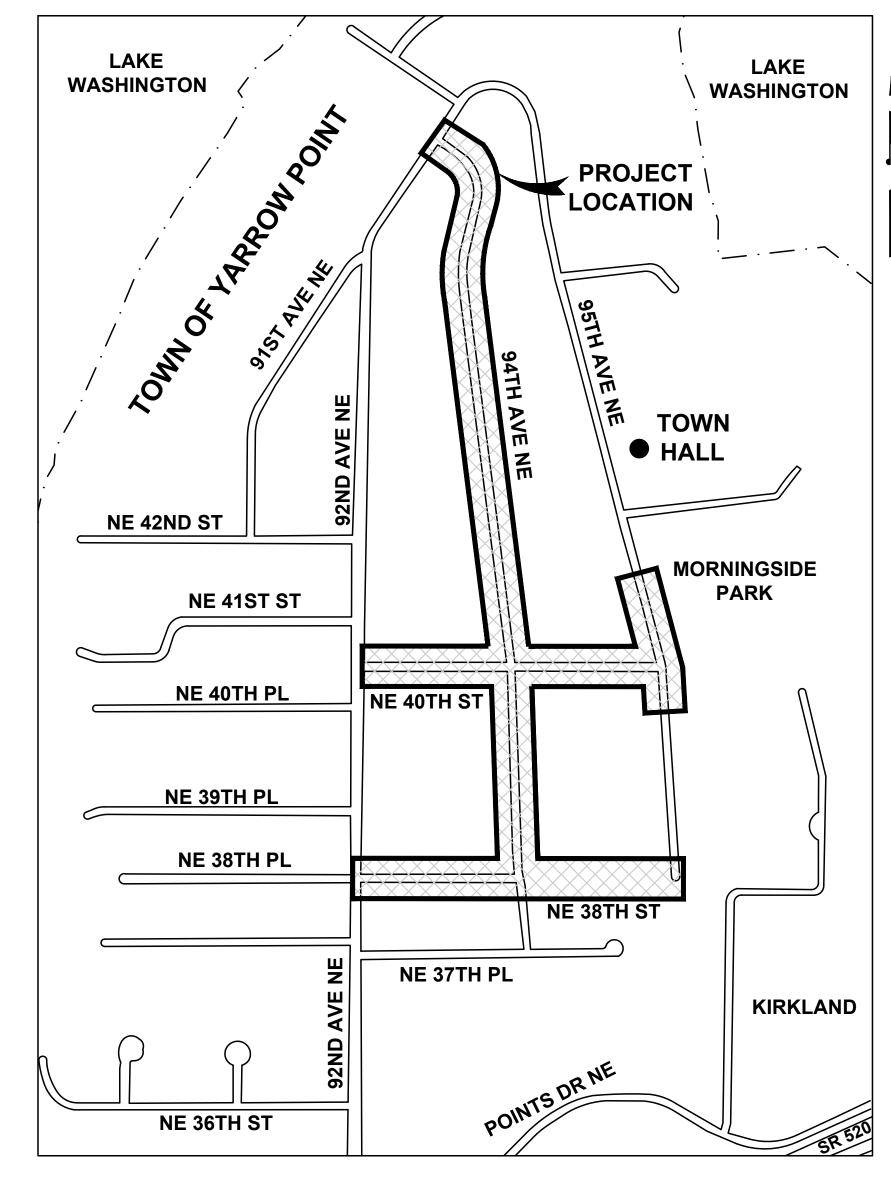

RIGHT-OF-WAY DISCLAIMER

PROPERTY LINES SHOWN HEREON

INFORMATION, NOT ON A SURVEYED

THE RIGHT-OF-WAY AND/OR

ARE BASED ON AVAILABLE


LOCATION AND ARE ONLY


APPROXIMATE.

Gray & Osborne, Inc.

3710 168TH STREET NORTHEAST **BUILDING B, SUITE 210** ARLINGTON, WA 98223 (360) 454-5490



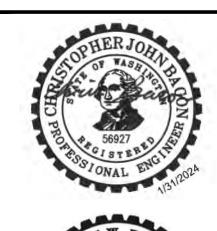

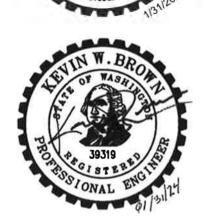

**TOWN OF** YARROW POINT

**TOWN WIDE STORMWATER AND UGC PROJECT** 

REVISION No. DATE ISSUED FOR: **BID PLAN SET** 

ISSUE DATE: JAN 2024 APPROVED BY: CHECKED BY: KWB DRAWN BY: CJB CJB DESIGNER: G & O JOB NO.: 23445 LEGEND.DWG

TWO INCHES AT FULL SCALE IF NOT, SCALE ACCORDINGLY

CIVIL

**VICINITY & LOCATION** MAPS, SYMBOL LEGEND, **ABBREVIATIONS AND** 

INDEX

DRAWING:

OF: **40** 

NOTE: LUMEN REVIEWED THE INCLUDED PLANS AND HAD NO RESERVATIONS WITH WHAT IS SHOWN ON SHEETS 18 - 25.

SHEET INDEX

BID ADDITIVE - SALLYS ALLEY PHASE 2 PLAN & PROFILE

PUGET SOUND ENERGY UGC PLANS (REFERENCE ONLY)

PUGET SOUND ENERGY STREET LIGHT PLANS (REFERENCE ONLY)

SURVEY CONTROL, AND ALIGNMENT TABLES

TEMPORARY EROSION CONTROL DETAILS

COMCAST MARKUPS ON JANUARY 5, 2024

GENERAL CONSTRUCTION NOTES

STORM PLAN & PROFILE

JOINT TRENCH DETAILS

CONSTRUCTION DETAILS

RESTORATION PLAN

JOINT UTILITY TRENCH PLAN

STORM DETAILS

**DESCRIPTION** 

VICINITY & LOCATION MAPS, SYMBOL LEGEND, ABBREVIATIONS AND INDEX

**BURIED UTILITIES IN AREA** CALL BEFORE YOU DIG 1-800-424-5555 EXISTING UTILITIES SHOWN ARE FROM THE BEST AVAILABLE INFORMATION AND NO


TYPE, LOCATION OR DEPTH

Stand Schweder BY: TOWN OF YARROW POINT DATE: JANUARY 2024

APPROVAL EXPIRES: <u>JANUARY 2025</u>

GUARANTEE IS MADE AS TO THE EXACT SIZE,

APPROVAL FOR CONSTRUCTION

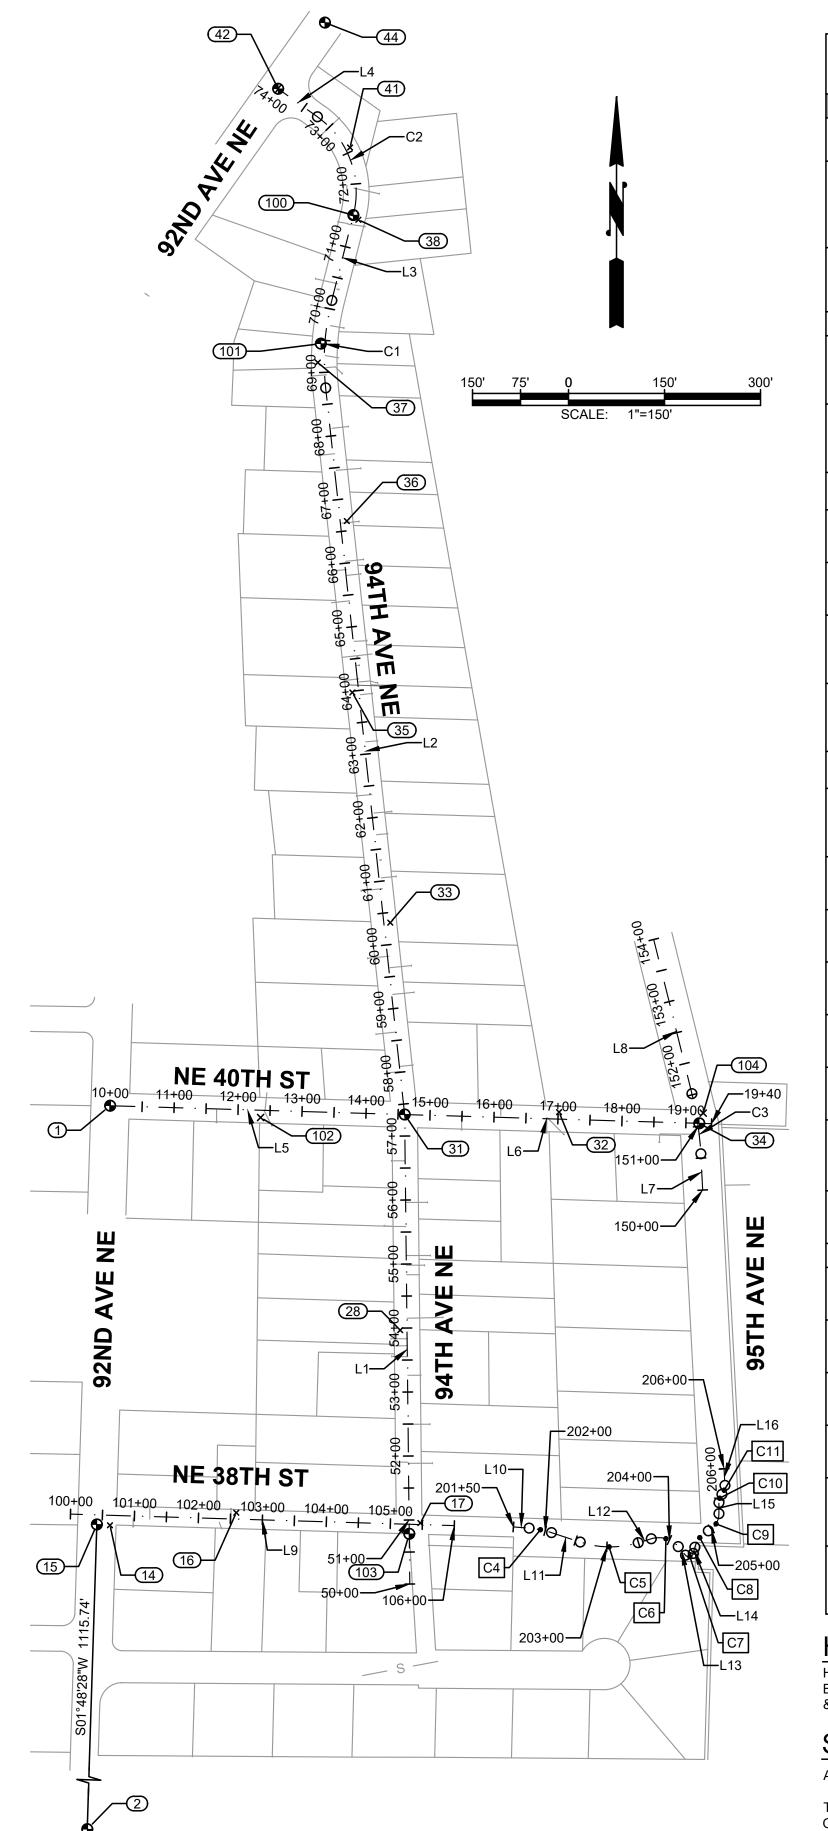

## TOWN OF YARROW POINT - TOWN WIDE STORM & UGC JOB NUMBER - 23445

SURVEY CONTROL & MONUMENTATION

HORIZONTAL DATUM: NAD83/2011

WASHINGTON PLANE COORDINATE SYSTEM, NORTH ZONE, GRID NORTH

HOLDING PACE SURVEY COORDS PROVIDED TO GRAY & OSBORNE BY TOWN OF YARROW POINT.

BASED ON CITY OF BELLEVUE PUBLISHED CONTROL POINTS #34 & #362

VERTICAL DATUM: NAVD88

238203.01

238504.33

238827.48

239500.71

239768.50

240016.20

240239.25

240352.10

240443.91

240547.34

240246.57

240045.70

238836.58

238186.02

238843.44

42

HOLDING PACE SURVEY PROVIDED TO GRAY & OSBORNE BY TOWN OF YARROW POINT

BASED ON CITY OF BELLEVUE PUBLISHED CONTROL POINTS #34 & #362

1299715.67

1299684.11

1300151.30

1299609.31

1299600.79

1299555.43

1299618.79

1299605.80

1299493.42

1299566.56

1299610.88

1299560.14

1300157.61

INT	NORTHING	EASTING	ELEV.	DESCRIPTION
1	238854.95	1299230.91	116.25	SFMC=FOUND MONUMENT IN CASE, 1 3/4" BRASS DISC W/ "X." DOWN 0.55' IN CASE. INTX NE 40TH ST & 92ND AVE NE. CITY OF BELLEVUE HORIZONTAL BENCHMARK: 0034. VERTICAL BENCHMARK: 309.
2	237085.48	1299174.97	153.00	SFMC, PIN SET IN CONCRETE, DOWN 0.5' IN CASE. INTX 92ND AVE NE & NE 34TH ST. CITY OF BELLEVUE HORIZONTAL BENCHMARK: 0362. VERTICAL

2	237085.48	1299174.97	153.00	INTX 92ND AVE NE & NE 34TH ST. CITY OF BELLEVUE HORIZONTAL BENCHMARK: 0362. VERTICAL BENCHMARK: 98.
14	238199.47	1299230.69	132.74	SFNT=FOUND NAIL W/ TAG, NAIL W/ "PACE" CONTROL TAG. SE QUADRANT INTX NE 38TH ST & 92ND AVE NE
15	238200.66	1299210.16	131.50	SFMC, PIN SET IN CONCRETE, DOWN 0.6' IN CASE. AT CENTERLINE 92ND AVE NE, S OF CENTERLINE OF NE 38TH ST.
16	238219.12	1299427.99	150.16	SFNT, NAIL W/ "PACE" CONTROL TAG. AT AP IN BACK OF WEDGE CURB, N SIDE NE 38TH ST. 15' E OF CENTERLINE DRIVEWAY TO 9218 NE 38TH ST.

170.60	SFNT, NAIL W/ "PACE" CONTROL TAG. IN ASPHALT, NE QUADRANT INTX 94TH AVE NE & NE 38TH ST. 3' N OF CENTERLINE OF 38TH ST EXTENDED. 11' S OF E BACK OF WEDGE CURB AT END OF 94TH AVE NE.
161.38	SFNT, NAIL W/ "PACE" CONTROL TAG. 0.5' W OF W BACK OF WEDGE CURB ON 94TH AVE NE. IN ASPHALT. 13' N OF CENTERLINE OF S DRIVEWAY TO 3833 94TH AVE NE.

				AVE NE.
31	238841.22	1299691.07	151.33	SFMC, 1/4" BRASS PLUG W/ PUNCH SET IN CONCRE DOWN 0.7' IN CASE. INTX 94TH AVE NE & NE 40TH S
32	238844.88	1299932.30	153.66	SFNT, NAIL W/ "PACE" CONTROL TAG. 0.5' S OF N WEDGE CURB OF NE 40TH ST. 14' E OF CENTERLINE OF DRIVEWAY TO 4015 95TH AVE NE "BUCHANAN". DRIVEWAY IS ON S SIDE OF THIS PROPERTY.
33	239141.08	1299668.57	140.98	SFNT, NAIL W/ "PACE" CONTROL TAG. AT E WEDGE CURB 94TH AVE NE. 18' N OF CENTERLINE OF DRIVEWAY TO 4024 94TH AVE NE.

140.98 CURB 94TH AVE NE. 18' N OF CENTERLINE OF DRIVEWAY TO 4024 94TH AVE NE.

SFMC, 1 1/2" BRASS DISC W/ PUNCH SET IN CONCRETE. DOWN 0.65' IN CASE. AT INTX 95TH AVE NE & NE 40TH ST.

SFNT, NAIL W/ "PACE" CONTROL TAG. 0.5' E OF W
WEDGE CURB 94TH AVE NE. 26' N OF CENTERLINE OF
DRIVEWAY TO 4425 94TH AVE NE.

SFNT, NAIL W/ "PACE" CONTROL TAG. AT E WEDGE
CURB 94TH AVE NE. 15' S OF CENTERLINE OF
DRIVEWAY TO 4413 94TH AVE NE

98.31 SFNT, NAIL W/ "PACE" CONTROL TAG. 0.7' E OF W
WEDGE CURB 94TH AVE NE. 20' S OF CENTERLINE OF
DRIVEWAY TO 4437 94TH AVE NE.

SFNT, NAIL W/ "PACE" CONTROL TAG. 1' W OF E
WEDGE CURB 94TH AVE NE AT APPROX PC OF CURVE
7' SW OF MAILBOX POST W/ THREE BOXES (4441, 4467,

SFNT, NAIL W/ "PACE" CONTROL TAG. 0.75' SW OF NE WEDGE CURB 94TH AVE NE ~3/4\(\Delta\). 15' SW OF "NO PARKING" SIGN.

75.60 SFMC, INTX 94TH AVE NE & YARROW POINT RD.

SFMC, PLUG W/ PUNCH SET IN CONC. DOWN 0.36' IN CASE. INTX YARROW POINT RD & NE 47TH ST. CITY OF

CASE. INTX YARROW POINT RD & NE 47TH ST. CITY OF BELLEVUE HORIZONTAL BENCHMARK: 0436.
 SFMC, 1/4" BRASS PLUG W/ PUNCH SET IN CONCRETE. DOWN 0.55' IN CASE. CENTERLINE 94TH AVE NE AT PT SE OF YARROW POINT RD.
 SFMC, 1/4" BRASS PLUG W/ PUNCH SET IN CONCRETE.

DOWN 0.6' IN CASE, 94TH AVE NE PI MON, 15' N OF

CENTERLINE DRIVEWAY TO 4437 94TH AVE NE.

SSN=SET NAIL, MAG NAIL AT S WEDGE CURB OF NE
40TH ST. 12' E OF CENTERLINE OF E DRIVEWAY TO
9229 94TH AVE NE.

SFMC, 1/2" INSIDE DIAMETER IRON PIPE COMING
FROM SIDE OF MONUMENT. DOWN 0.5' IN CASE. SHOT
CENTER OF PIPE. SW QUADRANT 94TH AVE NE & NE
38TH ST. IN WEDGE CURB

170.42 CENTER OF PIPE. SW QUADRANT 94TH AVE NE & NE 38TH ST. IN WEDGE CURB.

SSN, MAG NAIL AT E WEDGE CURB FLOW LINE OF 95TH AVE NE AT NE QUADRANT NE 95TH AVE & 40TH ST NE. 15' S OF CENTERLINE WALKWAY TO 4000 95TH

#### HORIZONTAL DATUM

HORIZONTAL DATUM: NAD 83/11, WASHINGTON COORDINATE SYSTEM NORTH ZONE. BASED ON TIES TO CITY OF BELLEVUE SURVEY CONTROL POINTS 34 & 362 (POINTS 1 & 2 IN THIS PLAN SET)

#### SURVEY NOTES

ALL DISTANCES SHOWN ARE GROUND DISTANCES UNLESS OTHERWISE NOTED.

THE LOCATION AND DESCRIPTION OF ALL SURVEY MARKERS SHOWN HEREON ARE BASED ON FIELD OBSERVATIONS TAKEN BY PACE ENGINEERS IN JANUARY, 2021, UNLESS OTHERWISE INDICATED.

WORK PERFORMED IN CONJUNCTION WITH THIS SURVEY UTILIZED THE FOLLOWING EQUIPMENT AND PROCEDURES: (A) 1" TRIMBLE S7 SERIES ELECTRONIC TOTAL STATION, MAINTAINED TO THE MANUFACTURER'S SPECIFICATIONS PER W.A.C. 332-130-100. (B) FIELD TRAVERSE, EXCEEDING REQUIREMENTS SET FORTH IN W.A.C. 332-130-090. (C) LEASE SQUARE ADJUSTMENT USING StarNet VERSION 9.0 EXCEEDING REQUIREMENTS PER W.A.C. 332-130-080.

	94TH AVENUE NE - CONSTRUCTION CENTERLINE ALIGNMENT											
SEGMENT	BEGIN STATION	BEGIN NORTHING	BEGIN EASTING	END STATION	END NORTHING	END EASTING	DISTANCE	BEARING	RADIUS	TANGENT	CURVE LENGTH	DELTA
L1	50+00.00	238,107.67	1,299,699.11	57+33.60	238,841.22	1,299,691.07	733.60	N0°37'41"W				
L2	57+33.60	238,841.22	1,299,691.07	68+75.57	239,976.50	1,299,567.66	1,141.97	N6°12'14"W				
C1	68+75.57	239,976.50	1,299,567.66	70+13.31	240,113.18	1,299,577.18			387.18	69.60	137.74	20°22'58"
L3	70+13.31	240,113.18	1,299,577.18	71+51.23	240,246.90	1,299,610.97	137.92	N14°10'43"E				
C2	71+51.23	240,246.90	1,299,610.97	73+24.72	240,400.20	1,299,554.70			144.75	98.88	173.49	68°40'22"
L4	73+24.72	240,400.20	1,299,554.70	74+00.00	240,443.92	1,299,493.42	75.28	N54°29'38"W				

	NE 40TH STREET - CONSTRUCTION CENTERLINE ALIGNMENT											
SEGMENT	BEGIN STATION	BEGIN NORTHING	BEGIN EASTING	END STATION	END NORTHING	END EASTING	DISTANCE	BEARING	RADIUS	TANGENT	CURVE LENGTH	DELTA
L5	10+00.00	238,854.95	1,299,230.91	14+60.36	238,841.22	1,299,691.07	460.36	S88°17'29"E				
L6	14+60.36	238,841.22	1,299,691.07	19+40.00	238,826.90	1,300,170.49	479.64	S88°17'23"E				

	95TH AVENUE NE - CONSTRUCTION CENTERLINE ALIGNMENT											
SEGMENT	BEGIN STATION	BEGIN NORTHING	BEGIN EASTING	END STATION	END NORTHING	END EASTING	DISTANCE	BEARING	RADIUS	TANGENT	CURVE LENGTH	DELTA
L7	150+00.00	238,723.23	1,300,156.74	150+56.68	238,779.84	1,300,153.79	56.68	N2°59'23"W				
C3	150+56.68	238,779.84	1,300,153.79	151+51.80	238,873.79	1,300,139.85			500.00	47.70	95.12	10°54'00"
L8	151+51.80	238,873.79	1,300,139.85	154+00.00	239,114.73	1,300,080.27	248.20	N13°53'23"W				

	NE 38TH STREET - CONSTRUCTION CENTERLINE ALIGNMENT											
SEGMENT	BEGIN STATION	BEGIN NORTHING	BEGIN EASTING	END STATION	END NORTHING	END EASTING	DISTANCE	BEARING	RADIUS	TANGENT	CURVE LENGTH	DELTA
L9	100+00.00	238,216.91	1,299,168.94	106+00.00	238,198.92	1,299,768.67	600.00	S88°16'54"E				

	SALLY'S ALLEY - CONSTRUCTION CENTERLINE ALIGNMENT											
SEGMENT	BEGIN STATION	BEGIN NORTHING	BEGIN EASTING	END STATION	END NORTHING	END EASTING	DISTANCE	BEARING	RADIUS	TANGENT	CURVE LENGTH	DELTA
L10	201+50.00	238,196.81	1,299,861.05	201+74.53	238,194.95	1,299,885.51	24.53	S85°39'01"E				
C4	201+74.53	238,194.95	1,299,885.51	202+10.26	238,187.97	1,299,920.47			147.50	17.95	35.73	13°52'50"
L11	202+10.26	238,187.97	1,299,920.47	202+57.51	238,173.19	1,299,965.34	47.24	S71°46'11"E				
C5	202+57.51	238,173.19	1,299,965.34	203+49.44	238,172.13	1,300,055.84			150.00	47.46	91.93	35°06'59"
L12	203+49.44	238,172.13	1,300,055.84	203+70.93	238,178.37	1,300,076.40	21.48	N73°06'50"E				
C6	203+70.93	238,178.37	1,300,076.40	204+17.34	238,166.03	1,300,118.47			40.00	26.21	46.41	66°28'38"
L13	204+17.34	238,166.03	1,300,118.47	204+34.91	238,152.65	1,300,129.86	17.57	S40°24'32"E				
C7	204+34.91	238,152.65	1,300,129.86	204+50.15	238,155.40	1,300,141.96			7.00	13.39	15.25	124°47'25"
L14	204+50.15	238,155.40	1,300,141.96	204+60.12	238,165.04	1,300,144.51	9.97	N14°48'04"E				
C8	204+60.12	238,165.04	1,300,144.51	204+94.19	238,190.65	1,300,165.39			40.00	18.14	34.07	48°47'48"
C9	204+94.19	238,190.65	1,300,165.39	205+27.49	238,217.52	1,300,182.05			30.00	18.60	33.30	63°35'52"
L15	205+27.49	238,217.52	1,300,182.05	205+44.84	238,234.86	1,300,182.05	17.35	N0°00'00"E				
C10	205+44.84	238,234.86	1,300,182.05	205+58.84	238,247.75	1,300,186.76			20.00	7.30	14.00	40°07'05"
C11	205+58.84	238,247.75	1,300,186.76	205+73.89	238,261.68	1,300,191.44			20.00	7.90	15.05	43°06'27"
L16	205+73.89	238,261.68	1,300,191.44	206+00.00	238,287.76	1,300,190.07	26.12	N2°59'23"W				

DISCLAIMER:

EXCEPTING PORTIONS OF SALLY'S ALLEY, NE 40TH STREET, AND NE 95TH STREET, ALL TOPOGRAPHIC DATA SHOWN HEREON WAS PERFORMED BY PACE (SEE NOTES, THIS SHEET). ADDITIONAL SURVEY FOR THE NOTED EXCEPTIONS WAS PERFORMED BY GRAY AND OSBORNE ON MAY 16, 2023 UTILIZING PACE CONTROL.

#### VERTICAL DATUM

ASSUMED APPROXIMATE

VERTICAL DATUM: NAVD 88 BASED ON TIES TO CITY OF BELLEVUE SURVEY CONTROL POINTS 34 & 362 (POINTS 1 & 2 IN THIS PLAN SET)

RIGHT OF WAY MARGINS AND CENTERLINES SHOWN HEREON AREA BASED UPON THE FOUND CENTERLINE MONUMENTS.
PARCEL/LOT LINES SHOWN HEREON ARE PER KING COUNTY GIS AND SHOULD BE

THIS SURVEY WAS PERFORMED WITHOUT THE BENEFIT OF A TITLE REPORT AND DOES NOT PURPORT TO SHOW ALL EASEMENTS.

THIS TOPOGRAPHIC SURVEY DRAWING ACCURATELY PRESENTS SURFACE FEATURES LOCATED DURING THE COURSE OF THIS SURVEY. UNDERGROUND UTILITIES SHOWN HEREON ARE BASED SOLELY UPON INFORMATION PROVIDED BY OTHERS AND PACE ENGINEERS, INC. DOES NOT ACCEPT RESPONSIBILITY OR ASSUME LIABILITY FOR THEIR ACCURACY OR COMPLETENESS. CONTRACTOR/ENGINEERS SHALL VERIFY EXACT SIZE AND LOCATION PRIOR TO CONSTRUCTION.

CALL FOR LOCATE: UTILITY LOCATION SERVICE: 811

#### RIGHT-OF-WAY DISCLAIMER

THE RIGHT-OF-WAY AND/OR
PROPERTY LINES SHOWN HEREON
ARE BASED ON AVAILABLE
INFORMATION, NOT ON A SURVEYED
LOCATION AND ARE ONLY
APPROXIMATE.

#### APPROVAL FOR CONSTRUCTION

Staus Schweder

BY: TOWN OF YARROW POINT


DATE: JANUARY 2024


APPROVAL EXPIRES: <u>JANUARY 2025</u>


Gray & Osborne, Inc.

3710 168TH STREET NORTHEAST BUILDING B, SUITE 210 ARLINGTON, WA 98223

(360) 454-5490

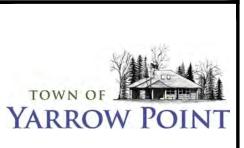

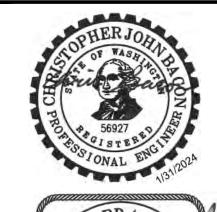

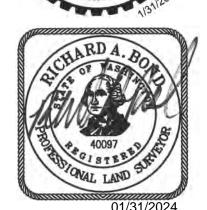

TOWN OF YARROW POINT

TOWN WIDE STORMWATER AND UGC PROJECT

lo.	DATE	REVISION

No. DATE REVISION

ISSUED FOR:

BID PLAN SET

ISSUE DATE: JAN 2024
APPROVED BY: KWB
CHECKED BY: KWB
DRAWN BY: CJB
DESIGNER: CJB
G & O JOB NO.: 23445





FILE: SURVEY CONTROL.DWG

CIVIL

SURVEY CONTROL, KEY MAP AND ALIGNMENT TABLES

DRAWING: 2 OF: 40

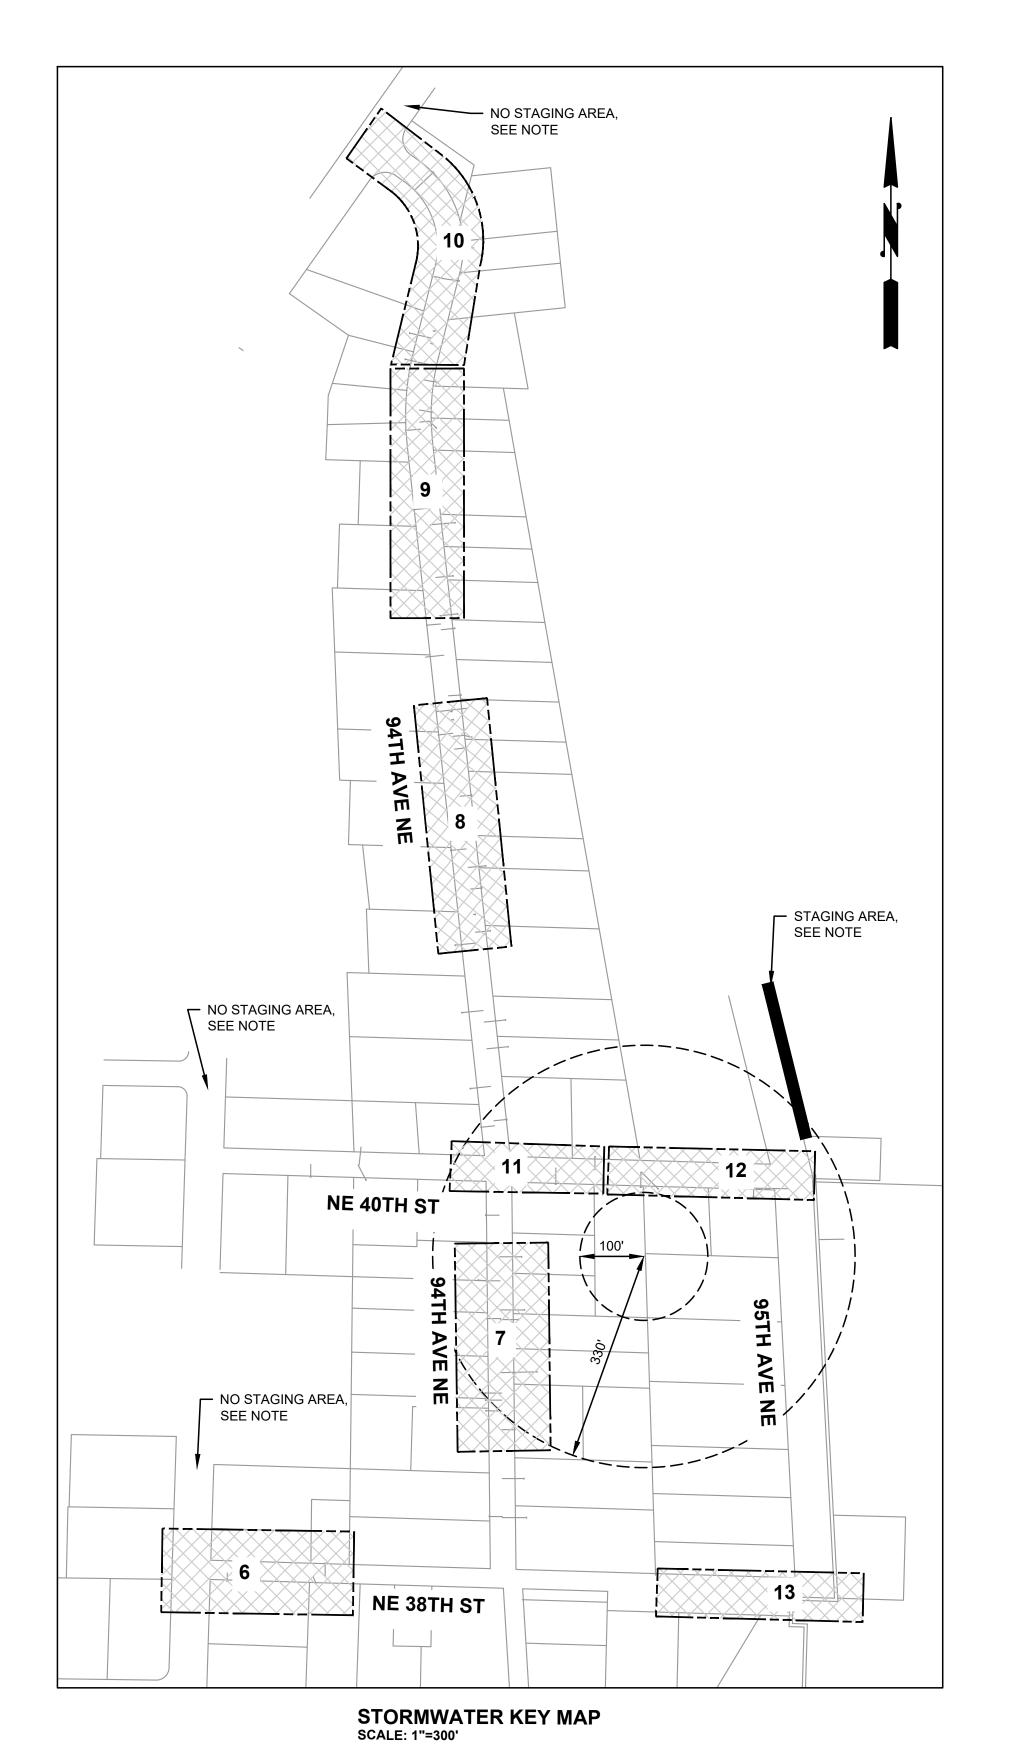

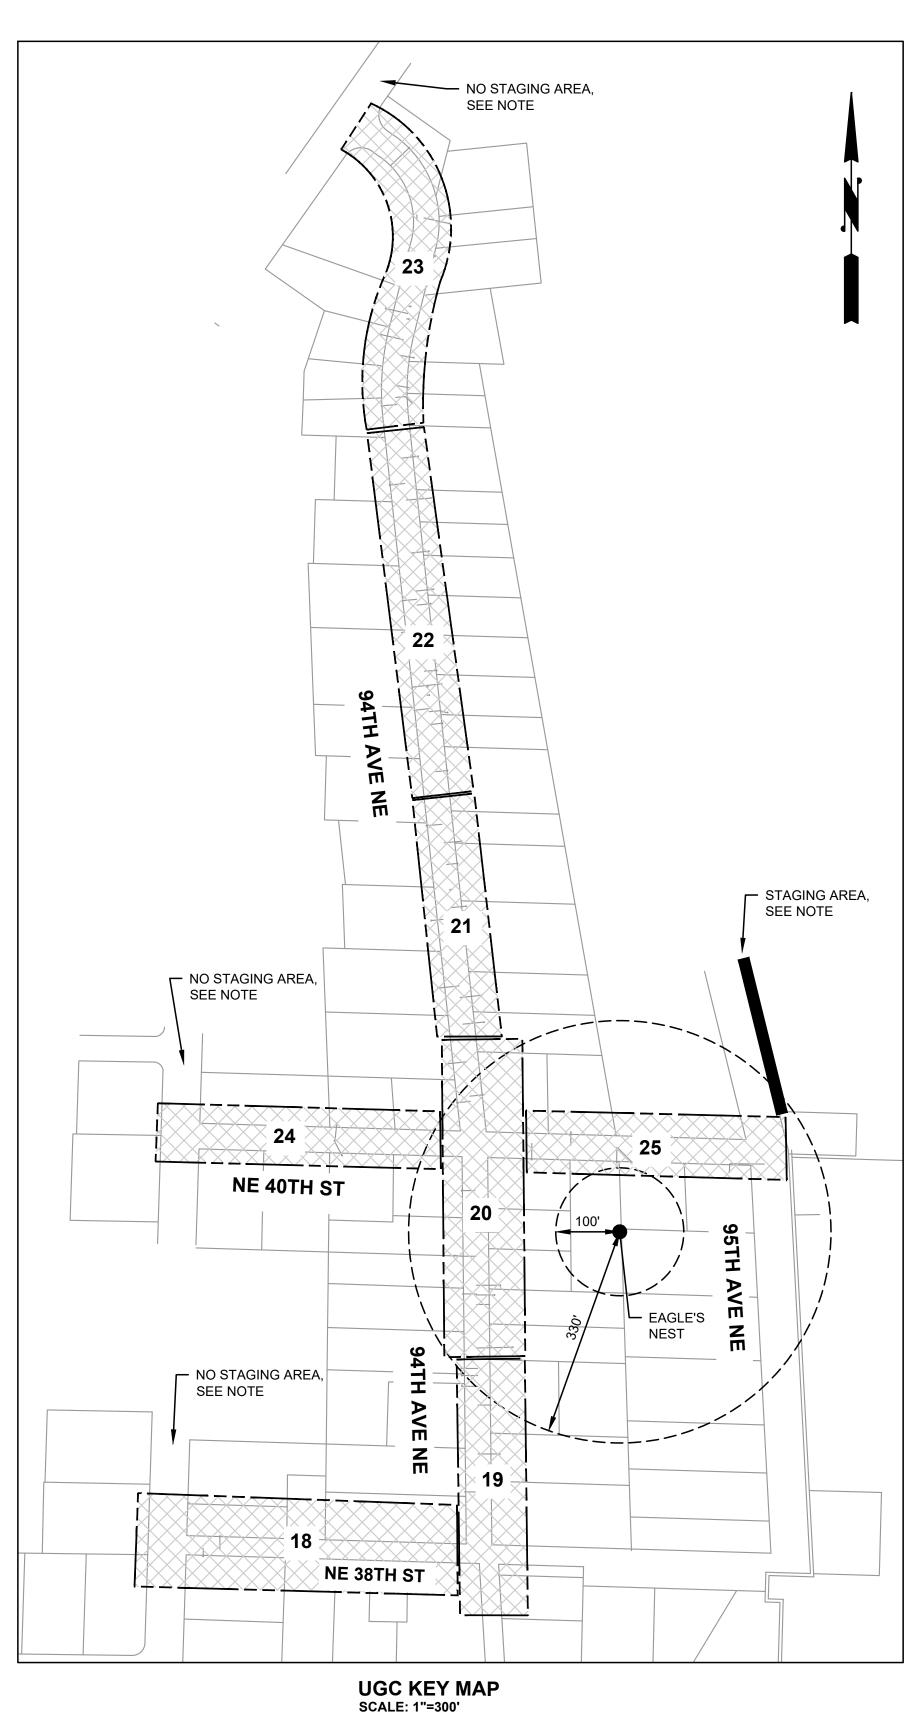



NO MATERIALS MAY BE STORED WITHIN THE 92ND AVE. NE CORRIDOR.

EAST SHOULDER OF 95TH AVE NE FROM THE NORTH SIDE OF 4000 95TH AVE NE DRIVEWAY TO TOWN HALL SOUTH ENTRANCE. (APPROX. DIMENSIONS: 8' X 200')

THIS DESIGNATED STAGING AREA IS LIMITED AND NO MATERIALS MAY BE ON SITE FOR MORE THAN 3 WEEKS PRIOR TO BEING INSTALLED. CONTRACTOR SHALL COORDINATE.

ALL STAGING AREAS SHALL BE RESTORED TO PRE-CONSTRUCTION CONDITIONS AT NO ADDITIONAL COST TO THE TOWN.

Gray & Osborne, Inc.

3710 168TH STREET NORTHEAST, BUILDING B, SUITE 210 ARLINGTON, WA 98223 (360) 454-5490







## TOWN OF YARROW POINT

TOWN WIDE STORMWATER AND UGC PROJECT

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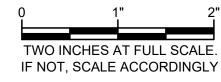
CHECKED BY: KWB

DRAWN BY: CJB

DESIGNER: CJB

G & O JOB NO.: 23445

FILE: SURVEY CONTROL.DWG



CIVIL

KEY MAPS

DRAWING: 3 OF: 40

RIGHT-OF-WAY DISCLAIMER

THE RIGHT-OF-WAY AND/OR
PROPERTY LINES SHOWN HEREON
ARE BASED ON AVAILABLE
INFORMATION, NOT ON A SURVEYED
LOCATION AND ARE ONLY
APPROXIMATE.

S-WAY AND/OR
NES SHOWN HEREON
N AVAILABLE
, NOT ON A SURVEYED

Showeder

TOWN OF YARROW POINT
DATE: JANUARY 2024

APPROVAL EXPIRES: JANUARY 2025

APPROVAL FOR CONSTRUCTION

#### **GENERAL NOTES TOWN OF YARROW POINT**

- 1. THIS DEVELOPMENT PROJECT SHALL CONFORM TO THE TOWN OF YARROW POINT'S REQUIREMENTS AND BE IN ACCORDANCE WITH THE APPROVED PLANS. ANY CHANGES FROM THE APPROVED PLAN WILL REQUIRE APPROVAL FROM THE OWNER, ENGINEER, BUILDING OFFICIAL, TOWN ENGINEER, AND TOWN PLANNER AS APPLICABLE.
- 2. ALL WORKMANSHIP AND MATERIALS SHALL CONFORM TO THE "WASHINGTON STATE DEPARTMENT OF TRANSPORTATION (WSDOT) STANDARD SPECIFICATIONS FOR ROAD, BRIDGE, AND MUNICIPAL CONSTRUCTION" (LATEST EDITION), EXCEPT WHERE SUPPLEMENTED OR MODIFIED BY THE TOWN. COPIES OF THE ABOVE DOCUMENTS SHALL BE AVAILABLE AT THE JOB SITE DURING CONSTRUCTION.
- 3. A PRE-CONSTRUCTION MEETING IS REQUIRED PRIOR TO THE START OF ALL CONSTRUCTION. CONTACT THE TOWN ENGINEER OR THE TOWN BUILDING OFFICIAL TO SCHEDULE A MEETING.
- 4. LOCATIONS SHOWN FOR EXISTING UTILITIES ARE APPROXIMATE. THE CONTRACTOR IS CAUTIONED THAT OVERHEAD UTILITY LINES MAY NOT BE SHOWN ON THE DRAWINGS. IT SHALL BE THE CONTRACTOR'S RESPONSIBILITY TO DETERMINE THE TRUE ELEVATIONS AND LOCATIONS OF ALL UNDERGROUND UTILITIES AND THE EXTENT OF ANY HAZARDS CREATED BY OVERHEAD UTILITY LINES. IDENTIFICATION, LOCATION MARKING, AND RESPONSIBILITY FOR UNDERGROUND FACILITIES OR UTILITIES IS GOVERNED BY PROVISION OF CHAPTER 19.122 REVISED CODE OF WASHINGTON (RCW). PRIOR TO STARTING CONSTRUCTION, THE CONTRACTOR SHALL CALL ONECALL (1-800-424-5555) FOR UTILITY LOCATIONS (WATER, SANITARY SEWER, STORM SEWER, GAS, POWER, TELEPHONE, CABLE TELEVISION, AND INTERNET.
- 5. AS-BUILT DRAWINGS ARE REQUIRED PRIOR TO PROJECT ACCEPTANCE. 7. THE CONTRACTOR SHALL HAVE A COPY OF THESE PLANS AND THE CONTRACT SPECIFICATIONS ON THE JOB SITE WHENEVER CONSTRUCTION IS IN PROGRESS.
- 8. PER TOWN OF YARROW POINT MUNICIPAL CODE SECTION 10.12, CONTRACTOR'S VEHICLES, INCLUDING TRUCK AND TRAILER COMBINATIONS, SHALL NOT HAVE AN OVERALL LENGTH IN EXCESS OF 40 FEET.

### STORM DRAINAGE NOTES **TOWN OF YARROW POINT** (MODIFIED:NOT ALL NOTES ARE SHOWN)

- 2. BEFORE ANY CONSTRUCTION MAY OCCUR, THE CONTRACTOR SHALL HAVE PLANS WHICH HAVE BEEN SIGNED AND APPROVED BY THE TOWN OF YARROW POINT, OBTAINED ALL TOWN, COUNTY, STATE, FEDERAL, AND OTHER REQUIRED PERMIETS, AND HAVE POSTED ALL REQUIRED BONDS. GONTAGE
- 4. ANY DEVIATION FROM THE APPROVED PLANS WILL REQUIRE WRITTEN APPROVAL. ALL CHANGES SHALL BE SUBMITTED TO THE TOWN.
- 6. ALL DISTURBED AREAS SHALL BE SEEDED AND MULCHED OR SIMILARLY STABILIZED TO THE SATISFACTION OF THE TOWN OF YARROW POINT FOR THE PREVENTION OF ON-SITE EROSION AFTER THE COMPLETION OF CONSTRUCTION.
- 9. ALL CATCH BASINS SHALL BE TYPE I UNLESS OTHERWISE NOTED, CATCH BASINS WITH A DEPTH OF OVER FIVE FEET (5') TO THE PIPE INVERT SHALL BE A TYPE II CATCH BASIN. TYPE II CATCH BASINS EXCEEDING FIVE FEET (5') IN DEPTH SHALL HAVE A STANDARD LADDER INSTALLED.
- 13. CONSTRUCTION OF DEWATERING (GROUNDWATER) SYSTEMS SHALL BE IN ACCORDANCE WITH THE APWA STANDARD SPECIFICATIONS.
- 15. ALL TRENCH BACKFILL SHALL BE COMPACTED TO 95 PERCENT DENSITY IN ROADWAYS, ROADWAY SHOULDERS, ROADWAY PRISM AND DRIVEWAYS, AND 85 PERCENT DENSITY IN UNPAVED AREAS. ALL PIPE ZONE COMPACTION SHALL BE 95 PERCENT.
- 16. THE CONTRACTOR SHALL BE RESPONSIBLE FOR PROVIDING ADEQUATE SAFEGUARDS, SAFETY DEVICES, PROTECTIVE EQUIPMENT, CONFINED SPACE PROTECTION, FLAGGERS, AND ANY OTHER NEEDED ACTIONS TO PROTECT THE LIFE, HEALTH, AND SAFETY OF THE PUBLIC, AND TO PROTECT PROPERTY IN CONNECTION WITH THE PERFORMANCE OF WORK COVERED BY THE CONTRACT. ANY WORK WITHIN THE TRAVELED RIGHT-OF-WAY THAT MAY INTERRUPT NORMAL TRAFFIC FLOW SHALL REQUIRE A TRAFFIC CONTROL PLAN APPROVED BY THE TOWN OF YARROW POINT. ALL SECTIONS OF THE WSDOT STANDARD SPECIFICATIONS, TRAFFIC CONTROL SECTION, AND THE MANUAL OF UNIFORM TRAFFIC CONTROL DEVICES (MUTCD) SHALL APPLY.
- 19. APPROXIMATE LOCATIONS OF EXISTING UTILITIES HAVE BEEN OBTAINED FROM AVAILABLE RECORDS AND ARE SHOWN FOR CONVENIENCE. THE CONTRACTOR SHALL BE RESPONSIBLE FOR VERIFICATION OF EXISTING UTILITY LOCATIONS WHETHER OR NOT THESE UTILITIES ARE SHOWN ON THE PLANS. THE CONTRACTOR SHALL EXERCISE ALL CARE TO AVOID DAMAGE TO ANY UTILITY. IF CONFLICTS WITH EXISTING UTILITIES ARISE DURING CONSTRUCTION, THE CONTRACTOR SHALL NOTIFY THE TOWN ENGINEER OR THE TOWN BUILDING OFFICIAL IMMEDIATELY AND ANY CHANGES REQUIRED SHALL BE APPROVED BY THE APPROPRIATE TOWN STAFF PRIOR TO COMMENCEMENT OF RELATED CONSTRUCTION ON THE PROJECT.
- 22. ALL INLET, MANHOLE, AND CATCH BASIN FRAMES AND GRATES SHALL NOT BE ADJUSTED TO GRADE UNTIL IMMEDIATELY PRIOR TO FINAL PAVING. ALL CATCH BASIN GRATES SHALL BE SET 0.10' BELOW PAVEMENT LEVEL.
- 25. GROUT ALL SEAMS AND OPENINGS IN ALL INLETS, CATCH BASINS, AND MANHOLES.

#### **TEMPORARY EROSION/SEDIMENTATION NOTES TOWN OF YARROW POINT** (MODIFIED; NOT ALL NOTES ARE SHOWN)

#### 1. THE APPROVED CONSTRUCTION SEQUENCE SHALL BE AS FOLLOWS:

- a. CONDUCT PRE-CONSTRUCTION MEETING.
- b. FLAG OR FENCE CLEARING LIMITS.
- d. INSTALL CATCH BASIN PROTECTION IF REQUIRED.
- INSTALL PERIMETER PROTECTION (SILT FENCE, BRUSH BARRIER, ETC.) IF REQUIRED.

- J. MAINTAIN EROSION CONTROL MEASURES IN ACCORDANCE WITH TOWN OF YARROW POINT STANDARDS AND MANUFACTURER'S RECOMMENDATIONS
- k. RELOCATE EROSION CONTROL MEASURES OR INSTALL NEW MEASURES SO THAT AS SITE CONDITIONS CHANGE, THE EROSION AND SEDIMENT CONTROL IS ALWAYS IN ACCORDANCE WITH THE TOWN TESC MINIMUM REQUIREMENTS.
- I. COVER ALL AREAS WITHIN THE SPECIFIED TIME FRAME WITH STRAW, WOOD FIBER MULCH, COMPOST, PLASTIC SHEETING, CRUSHED ROCK OR EQUIVALENT.

- o. UPON COMPLETION OF THE PROJECT. ALL DISTURBED AREAS MUST BE STABILIZED AND BEST MANAGEMENT PRACTICES REMOVED IF APPROPRIATE.
- 3. THE IMPLEMENTATION OF THIS ESC PLAN AND THE CONSTRUCTION, MAINTENANCE, REPLACEMENT. AND UPGRADING OF THESE ESC FACILITIES IS THE RESPONSIBILITY OF THE PERMITTEE/CONTRACTOR UNTIL ALL CONSTRUCTION IS APPROVED.
- 5. THE ESC FACILITIES SHOWN ON THIS PLAN MUST BE CONSTRUCTED PRIOR TO OR IN CONJUNCTION WITH ALL CLEARING AND GRADING ACTIVITIES IN SUCH A MANNER AS TO ENSURE THAT SEDIMENT-LADEN WATER DOES NOT ENTER THE DRAINAGE SYSTEM OR VIOLATE APPLICABLE WATER STANDARDS. WHEREVER POSSIBLE, MAINTAIN NATURAL VEGETATION FOR SILT CONTROL.
- THE ESC FACILITIES SHOWN ON THIS PLAN ARE THE MINIMUM REQUIREMENTS FOR ANTICIPATED SITE CONDITIONS. DURING THE CONSTRUCTION PERIOD, THESE ESC FACILITIES SHALL BE UPGRADED (E.G. ADDITIONAL SUMPS, RELOCATION OF DITCHES AND SILT FENCES, ETC.) AS NEEDED FOR UNEXPECTED STORM EVENTS. ADDITIONALLY, MORE ESC FACILITIES MAY BE REQUIRED TO ENSURE COMPLETE SILTATION CONTROL. THEREFORE, DURING THE COURSE OF CONSTRUCTION IT SHALL BE THE OBLIGATION AND RESPONSIBILITY OF THE CONTRACTOR TO ADDRESS ANY NEW CONDITIONS THAT MAY BE CREATED BY HIS ACTIVITIES AND TO PROVIDE ADDITIONAL FACILITIES OVER AND ABOVE THE MINIMUM REQUIREMENTS AS MAY BE NEEDED.
- 7. THE ESC FACILITIES SHALL BE INSPECTED BY THE PERMITTEE/CONTRACTOR DAILY DURING NON-RAINFALL PERIODS, EVERY HOUR (DAYLIGHT) DURING RAINFALL EVENTS, AT THE END OF EVERY RAINFALL, AND MAINTAINED AS NECESSARY TO ENSURE THEIR CONTINUED FUNCTIONING. IN ADDITION, TEMPORARY SILTATION PONDS AND ALL TEMPORARY SILTATION CONTROLS SHALL BE MAINTAINED IN A SATISFACTORY CONDITION UNTIL SUCH TIME THAT CLEARING AND/OR CONSTRUCTION IS COMPLETED, PERMANENT DRAINAGE FACILITIES ARE OPERATIONAL, AND THE POTENTIAL FOR EROSION HAS PASSED. WRITTEN RECORDS SHALL BE KEPT DOCUMENTING THE REVIEWS OF THE ESC FACILITIES.
- ALL DENUDED SOILS MUST BE STABILIZE WITH AN APPROVED TESC METHOD (E.G. SEEDING, MULCHING, PLASTIC COVERING, CRUSHED ROCK) WITHIN THE FOLLOWING TIMELINES:
  - a. MAY 1 TO SEPTEMBER 30 SOILS MUST BE STABILIZED WITHIN 7 DAYS OF GRADING.
- b. OCTOBER 1 TO APRIL 30 SOILS MUST BE STABILIZED WITHIN 2 DAYS OF GRADING
- C. STABILIZE SOILS AT THE END OF THE WORKDAY PRIOR TO A WEEKEND, HOLIDAY, OR PREDICTED RAIN EVENT.
- 10. AT NO TIME SHALL MORE THAN 1' OF SEDIMENT BE ALLOWED TO ACCUMULATE WITHIN A CATCH BASIN. ALL CATCH BASINS AND CONVEYANCE LINES SHALL BE CLEANED PRIOR TO PAVING. THE CLEANING OPERATION SHALL NOT FLUSH SEDIMENT-LADEN WATER INTO THE DOWNSTREAM SYSTEM.

- 17. THE ESC FACILITIES SHALL BE CONSTRUCTED IN ACCORDANCE WITH THE DETAILS ON THE APPROVED PLANS. LOCATIONS MAY BE MOVED TO SUIT FIELD CONDITIONS, SUBJECT TO APPROVAL BY THE TOWN ENGINEER OR THE TOWN BUILDING OFFICIAL.
- 21. OFF-SITE STREETS MUST BE KEPT CLEAN AT ALL TIMES. IF DIRT IS DEPOSITED ON THE PUBLIC STREET SYSTEM THE STREET SHALL BE IMMEDIATELY CLEANED WITH POWER SWEEPER OR OTHER EQUIPMENT.
- 22. ANY CATCH BASINS COLLECTING RUNOFF FROM THE SITE, WHETHER THEY ARE ON OR OFF THE SITE. SHALL HAVE THEIR GRATES COVERED WITH FILTER FABRIC DURING CONSTRUCTION. CATCH BASINS DIRECTLY DOWNSTREAM OF THE CONSTRUCTION ENTRANCE OR ANY OTHER CATCH BASIN AS DETERMINED BY THE TOWN ENGINEER OR TOWN BUILDING OFFICIAL SHALL BE PROTECTED WITH A "FILTER FABRIC SOCK" OR EQUIVALENT.
- 26. ALL PROPERTIES ADJACENT TO THE PROJECT SITE SHALL BE PROTECTED FROM SEDIMENT DEPOSITION AND RUNOFF.
- 27. DO NOT FLUSH CONCRETE BY-PRODUCTS OR TRUCKS NEAR OR INTO THE STORM DRAINAGE SYSTEM. IF EXPOSED AGGREGATE IS FLUSHED INTO THE STORM SYSTEM, IT COULD MEAN RE-CLEANING THE ENTIRE DOWNSTREAM STORM SYSTEM, OR POSSIBLY RE-LAYING THE STORM LINE.
- 28. PRIOR TO OCTOBER 1 OF EACH YEAR (THE BEGINNING OF THE WET SEASON), ALL DISTURBED AREAS SHALL BE REVIEWED TO IDENTIFY WHICH ONES CAN BE SEEDED IN PREPARATION FOR THE WINTER RAINS. THE IDENTIFIED DISTURBED AREA SHALL BE SEEDED WITHIN ONE WEEK AFTER OCTOBER 1. A SITE PLAN DEPICTING THE AREAS TO BE SEEDED AND THE AREAS TO REMAIN UNCOVERED SHALL BE SUBMITTED TO THE TOWN ENGINEER. THE TOWN ENGINEER CAN REQUIRE SEEDING OF ADDITIONAL AREAS IN ORDER TO PROTECT SURFACE WATERS, ADJACENT PROPERTIES, OR DRAINAGE FACILITIES.
- 30. A WATER TRUCK SHALL BE ON SITE AT ALL TIMES TO PROVIDE DUST CONTROL THIS WORK SHALL BE INCIDENTAL TO CONSTRUCTION, SEE SECTION 2-07.



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TOWN OF YARROW POINT

TOWN WIDE STORMWATER AND **UGC PROJECT** 

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ISSUED FOR: **BID PLAN SET ISSUE DATE:** JAN 2024

APPROVED BY: KWB CHECKED BY: KWB DRAWN BY: CJB CJB **DESIGNER:** G & O JOB NO .: 23445 GEN NOTES.DWG

TWO INCHES AT FULL SCALE IF NOT, SCALE ACCORDINGLY

GENERAL

**GENERAL** CONSTRUCTION

NOTES

DRAWING:

OF: **40** 

#### RIGHT-OF-WAY DISCLAIMER

THE RIGHT-OF-WAY AND/OR PROPERTY LINES SHOWN HEREON ARE BASED ON AVAILABLE INFORMATION, NOT ON A SURVEYED LOCATION AND ARE ONLY APPROXIMATE.

**APPROVAL FOR CONSTRUCTION** Stand Schweder

BY: TOWN OF YARROW POINT

DATE: JANUARY 2024

**BURIED UTILITIES IN AREA** 


CALL BEFORE YOU DIG

1-800-424-5555

EXISTING UTILITIES SHOWN ARE FROM THE

BEST AVAILABLE INFORMATION AND NO GUARANTEE IS MADE AS TO THE EXACT SIZE TYPE, LOCATION OR DEPTH


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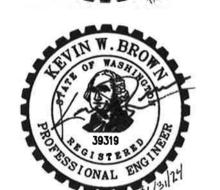


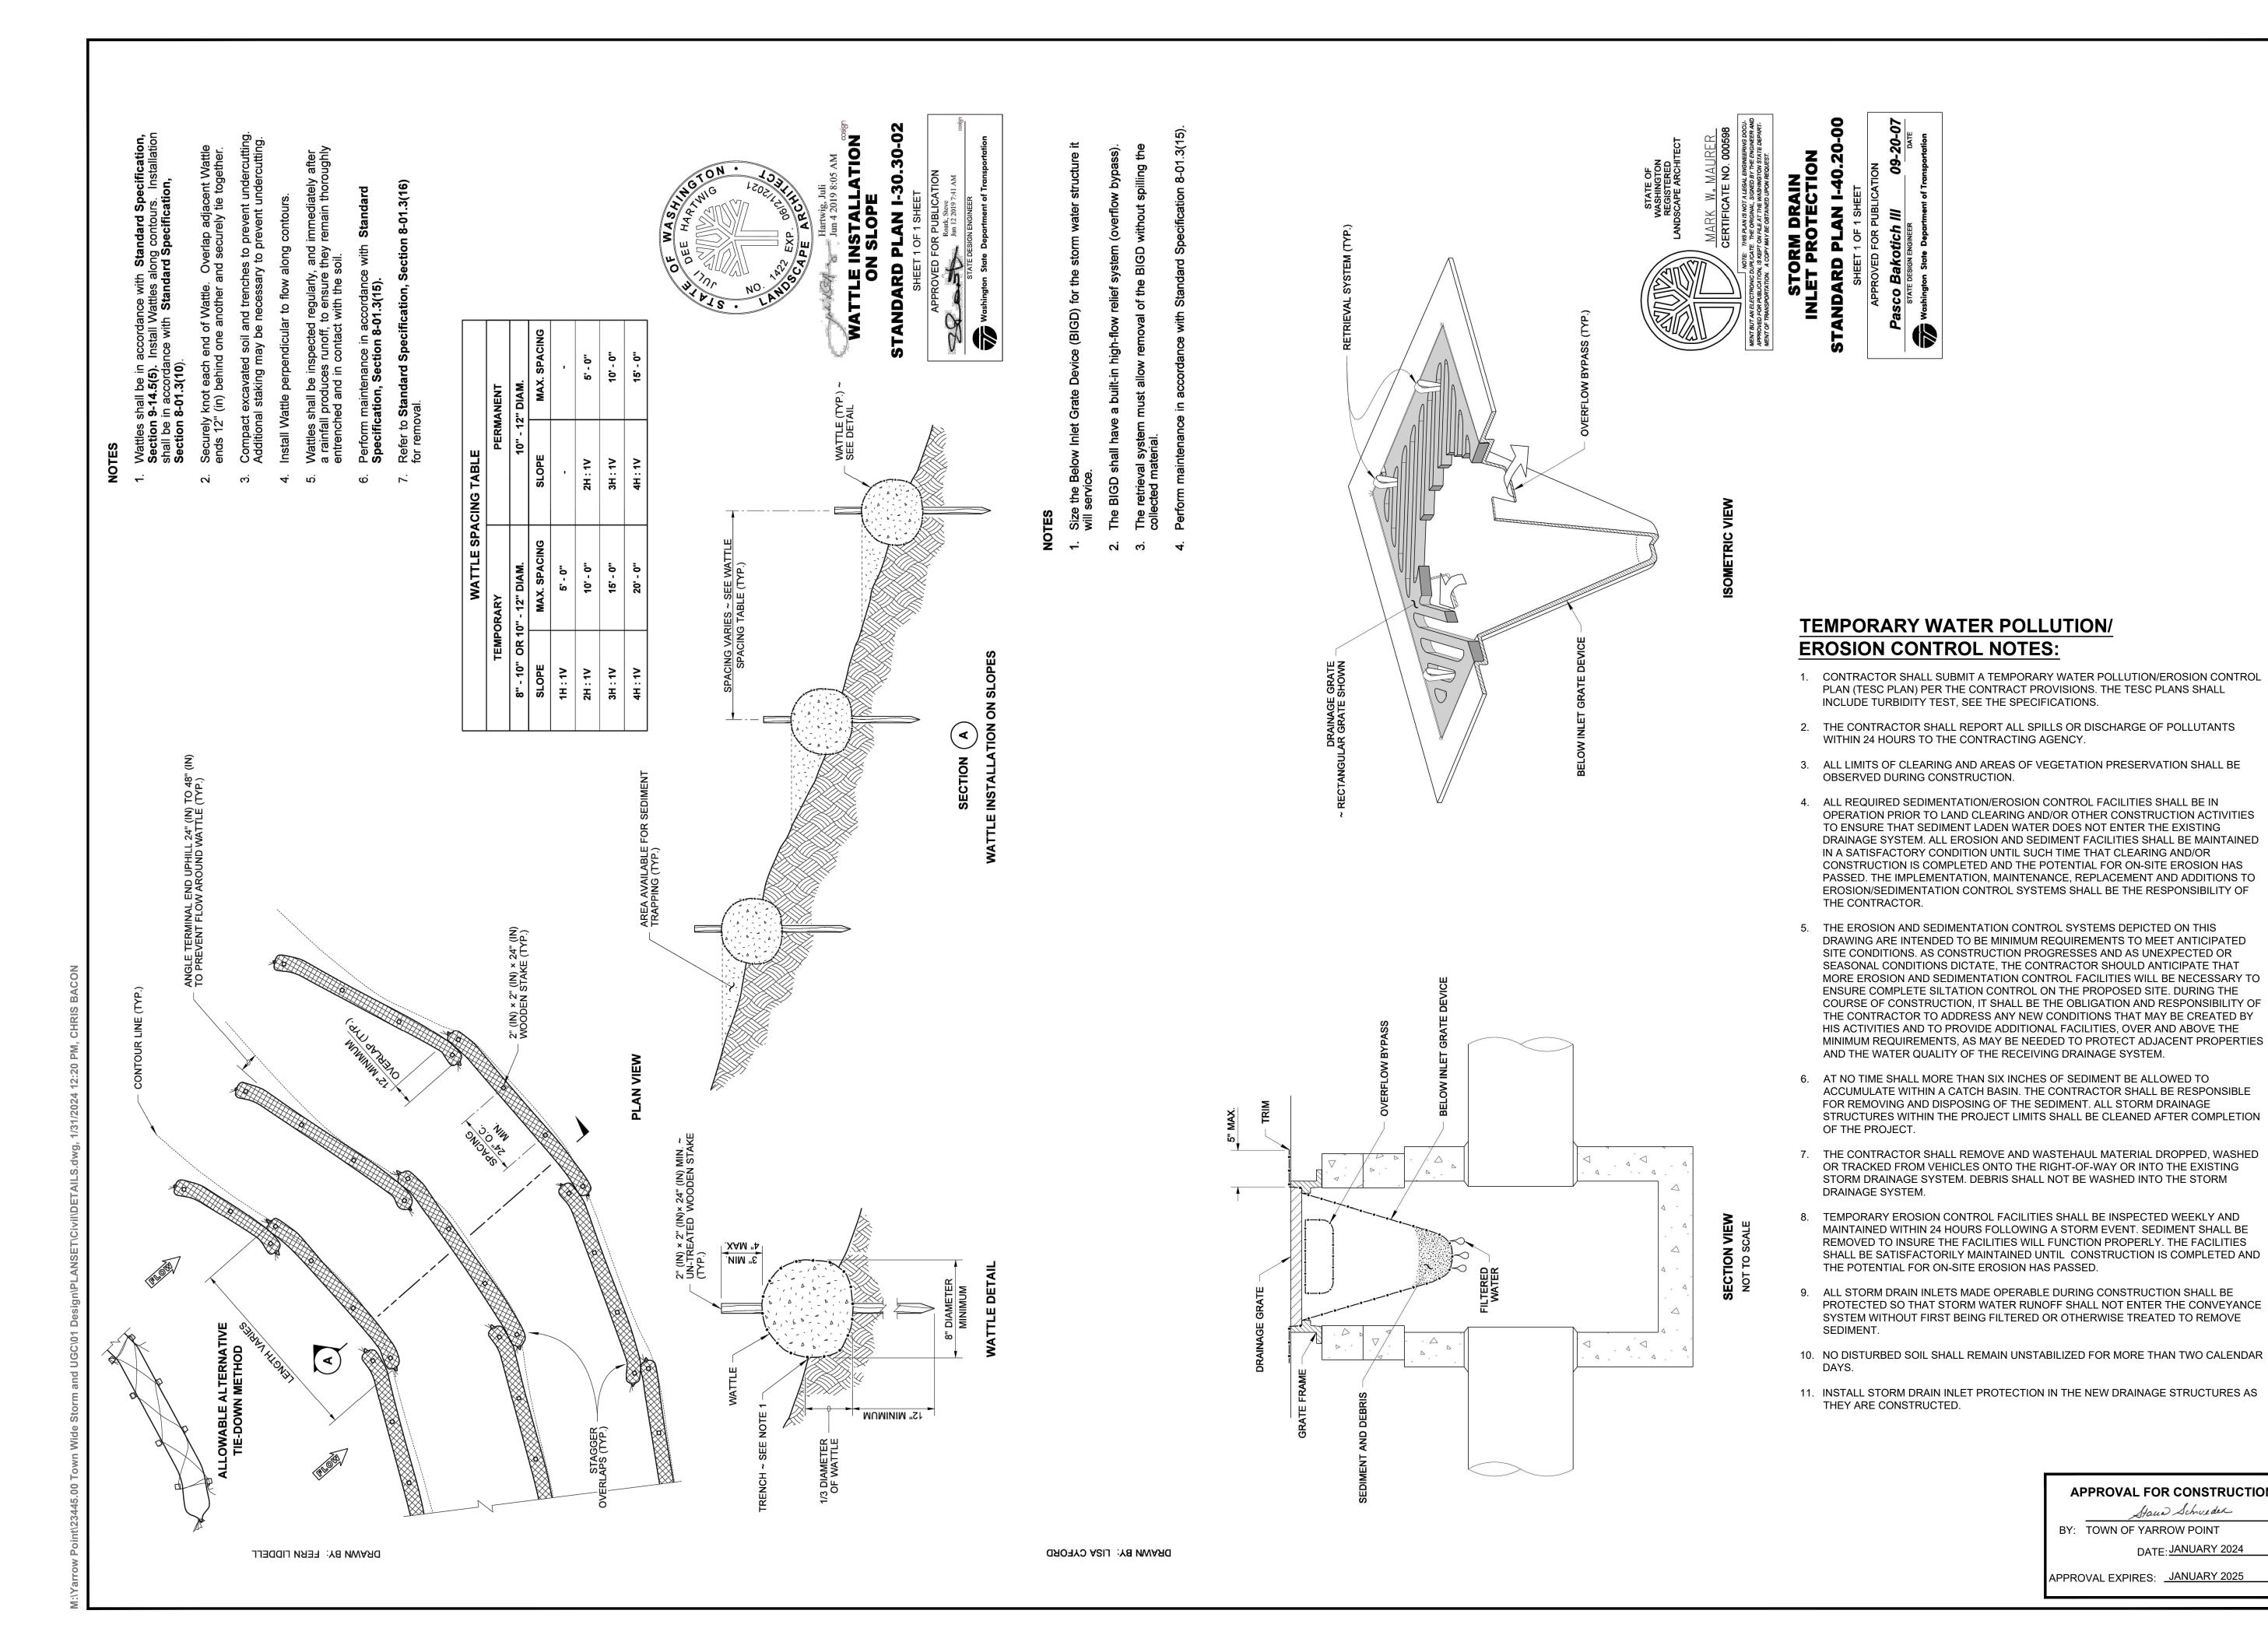

BUILDING B, SUITE 210 ARLINGTON, WA 98223 (360) 454-5490





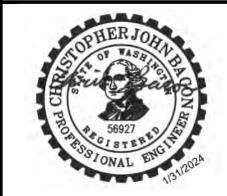

#### **TOWN OF YARROW POINT**

**TOWN WIDE** STORMWATER AND **UGC PROJECT** 

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DETAILS.DWG

TWO INCHES AT FULL SCALE IF NOT, SCALE ACCORDINGLY

FILE:

CIVIL

**TEMPORARY EROSION** 

DRAWING: **5** 

DATE: JANUARY 2024 APPROVAL EXPIRES: <u>JANUARY 2025</u>


APPROVAL FOR CONSTRUCTION

BY: TOWN OF YARROW POINT

Stand Schweder

**CONTROL DETAILS** 

of: **40** 

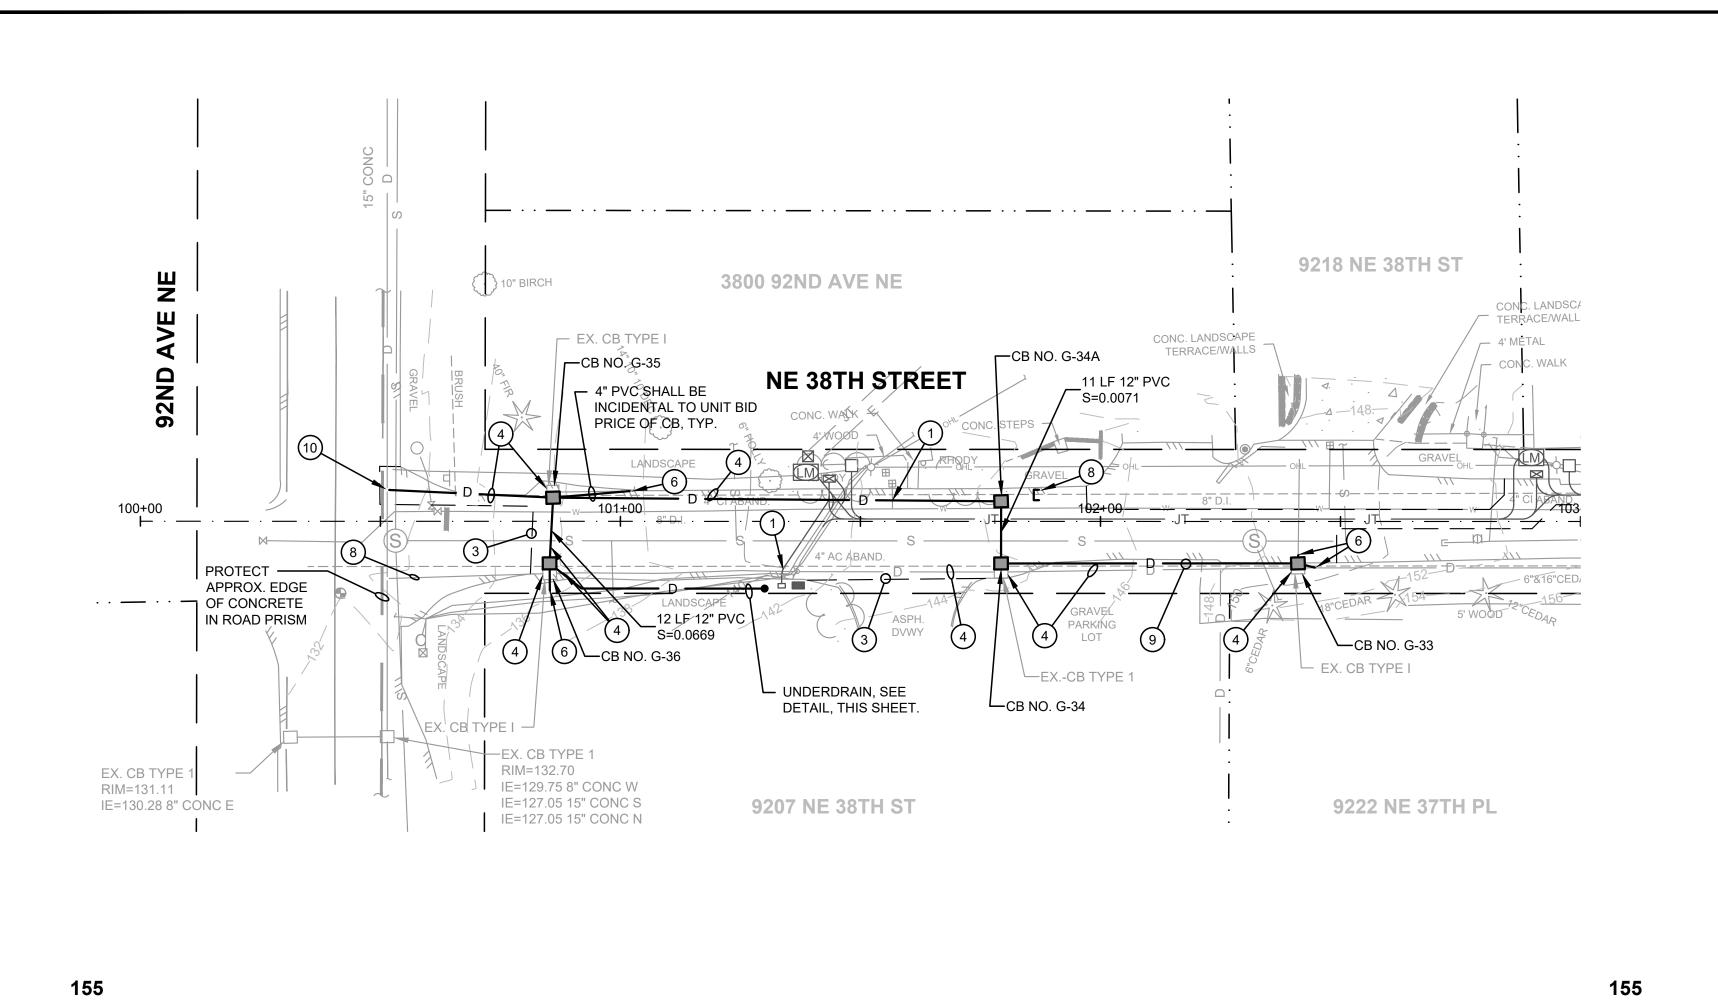

: EXIST: GRADE @CENTERLINE :

OF CONSTRUCTION - - 8" WATER MAIN

102<del>+</del>00

150

140

135

130

125


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115

100+00

15" CONC :

101+00

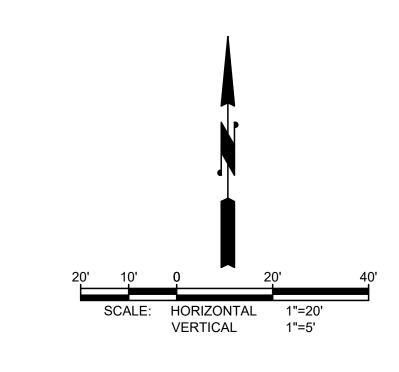


#### **GENERAL STORM DRAINAGE NOTES**

- 1. INSTALL BYPASS PUMPING, AS NEEDED, TO MAINTAIN STORWATER FLOW. BYPASS PUMPING SHALL BE INCLUDED IN THE UNIT BID PRICE FOR STORM PIPE.
- 2. IRRIGATION (PIPES, WIRES, SPRINKLER HEADS, ETC.) ENCOUNTERED SHALL BE CUT AT THE LIMITS OF EXCAVATION AND PIPES SHALL BE BROUGHT TO FINISHED GRADE AND CAPPED. COORDINATE WITH HOME OWNERS AS NEEDED.
- 3. ALL NEW CATCH BASINS HAVE A VANED GRATE EXCEPT AS NOTED.

## STORM DRAINAGE NOTES

- <u>CAUTION</u>: POTENTIAL UTILITY CONFLICT. VERIFY (POTHOLE) EXACT LOCATION AND DEPTH OF EXISTING UTILITY. SEE ORDER OF WORK.
- PROTECT EXISTING CONCRETE DRIVEWAY, RETAINING WALL, SURVEY MONUMENT, UNDERGROUND UTILITIES, AND MAILBOX STRUCTURES DURING CONSTRUCTION.
- 3 SAWCUT EXISTING PAVEMENT AND SEAL JOINT (WHERE APPLICABLE) THEN APPLY SAND BLANKET TO THE SURFACE JOINT.
- REMOVE AND WASTEHAUL EXISTING STORM DRAINAGE STRUCTURE(S)/PIPE.
- 5 CONNECT NEW STORM PIPE TO EXISTING CATCH BASIN. CORE DRILL IF KNOCK OUT IS NOT PRESENT.
- 6 CONNECT NEW STORM PIPE TO EXISTING STORM PIPE.
- REMOVE AND WASTEHAUL EXISTING MONUMENT. INSTALL PRECAST MONUMENT PER DETAIL, SHEET 38.
- 8 ABANDON EXISTING PIPE PER SPECIFICATIONS.
- REMOVE EXISTING ASBESTOS CEMENT PIPE AS NEEDED.
- 10 CONNECT NEW STORM PIPE TO EXISTING STORM PIPE W / INSERT-A-TEE. PROTECT EXIST. CONC. IN THE ROAD PRISM.
- 11 CAP STORM STUB AT R/W.

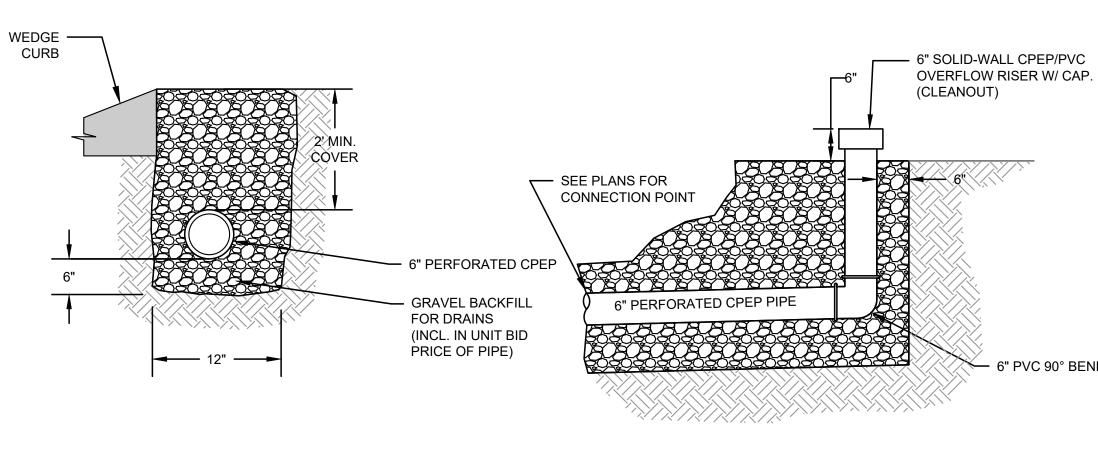

- 1. ALL COSTS ASSOCIATED WITH INSTALLING THE VERTICAL SECTION(S) OF PIPE SHALL BE INCLUDED IN THE UNIT PRICE BID PER FOOT FOR PIPE MEASURED ON THE HORIZONTAL PLANE
- 2. ALL EXPOSED PIPE AND CAP SHALL BE .WHITE OR GRAY AND SHALL MATCH.

## **UNDERDRAIN DETAIL**

**CALL BEFORE YOU DIG** 1-800-424-5555 EXISTING UTILITIES SHOWN ARE FROM THE BEST AVAILABLE INFORMATION AND NO GUARANTEE IS MADE AS TO THE EXACT SIZE, TYPE, LOCATION OR DEPTH


**BURIED UTILITIES IN AREA** 


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ARLINGTON, WA 98223 (360) 454-5490

YARROW POINT



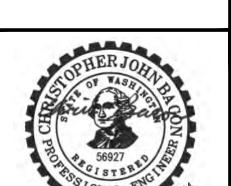

**TOWN OF YARROW POINT** 

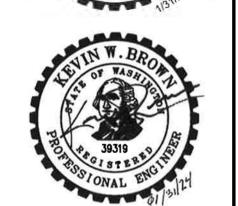**TOWN WIDE STORMWATER AND UGC PROJECT** 

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DRAW	N BY:	CJB

TWO INCHES AT FULL SCALE IF NOT, SCALE ACCORDINGLY

STORM P&P.DWG

CJB 23445

DESIGNER:

G & O JOB NO.:

CIVIL

of: **40** 

STORM PLAN & RIGHT-OF-WAY DISCLAIMER APPROVAL FOR CONSTRUCTION **PROFILE** Stand Schweder THE RIGHT-OF-WAY AND/OR PROPERTY LINES SHOWN HEREON BY: TOWN OF YARROW POINT ARE BASED ON AVAILABLE DRAWING: **6** DATE: JANUARY 2024 INFORMATION, NOT ON A SURVEYED LOCATION AND ARE ONLY APPROVAL EXPIRES: JANUARY 2025 APPROXIMATE.

- EXIST. ELEV. @CENTERLINE

OF CONSTRUCTION

145

140


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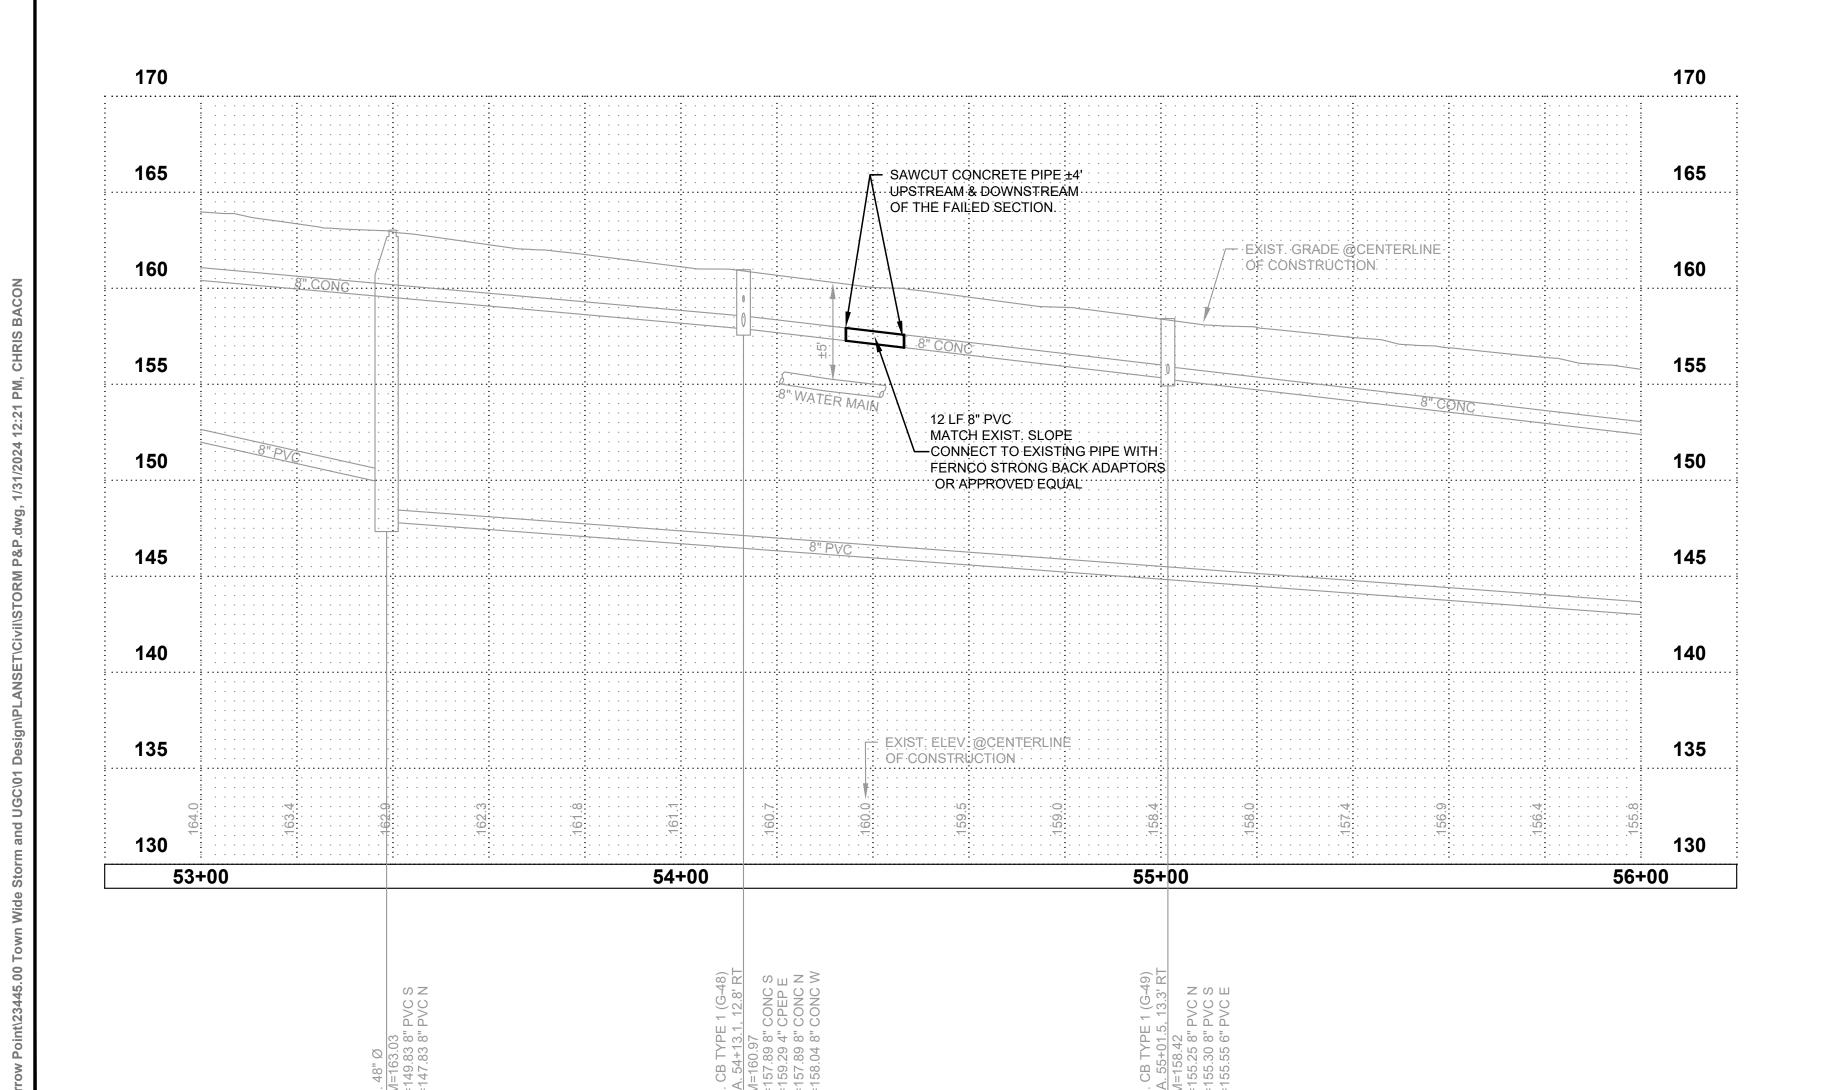
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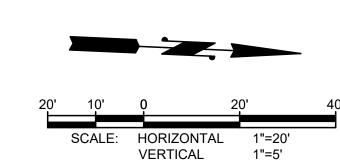
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103+00








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- 11 CAP STORM STUB AT R/W.

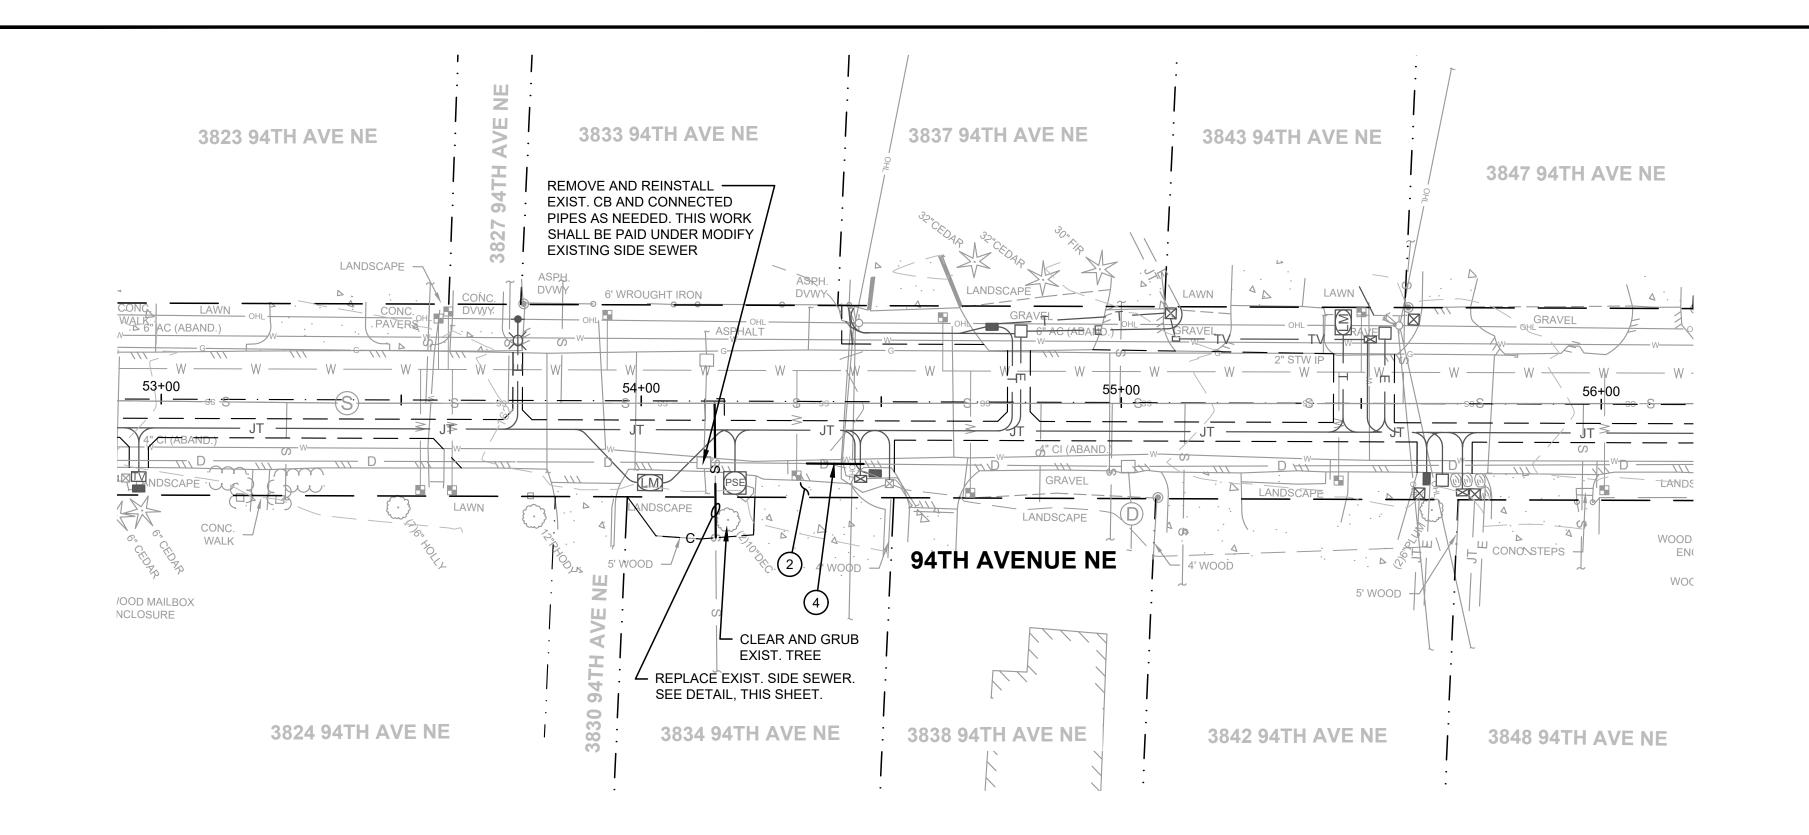

#### NOTES:

1. SAWCUT EXIST PIPE AT LIMITS OF EXCAVATION (±3' MIN. BEYOND FAILED SECTION OF SIDE SEWER).
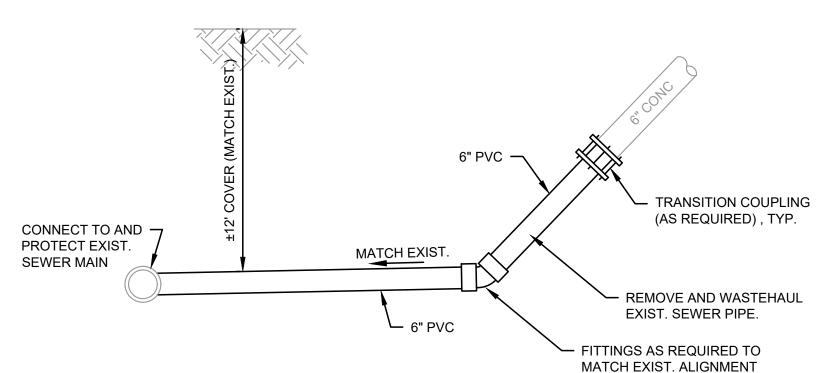
#### SIDE SEWER REPLACEMENT DETAIL

NTS

BURIED UTILITIES IN AREA
CALL BEFORE YOU DIG
1-800-424-5555
EXISTING UTILITIES SHOWN ARE FROM THE
BEST AVAILABLE INFORMATION AND NO
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#### APPROVAL FOR CONSTRUCTION

Staud Schweder
BY: TOWN OF YARROW POINT

DATE: JANUARY 2024

APPROVAL EXPIRES: JANUARY 2025

Gray & Osborne, Inc.

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BUILDING B, SUITE 210

ARLINGTON, WA 98223 (360) 454-5490



YARROW POINT



## TOWN OF YARROW POINT

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FILE: STORM P&P.DWG

0 1" 2"

TWO INCHES AT FULL SCALE.

KWB CJB

CJB

CHECKED BY:

DRAWN BY:

DESIGNER:


CIVIL

IF NOT, SCALE ACCORDINGLY

\_\_\_\_

STORM PLAN & PROFILE

DRAWING: 7 OF: 40

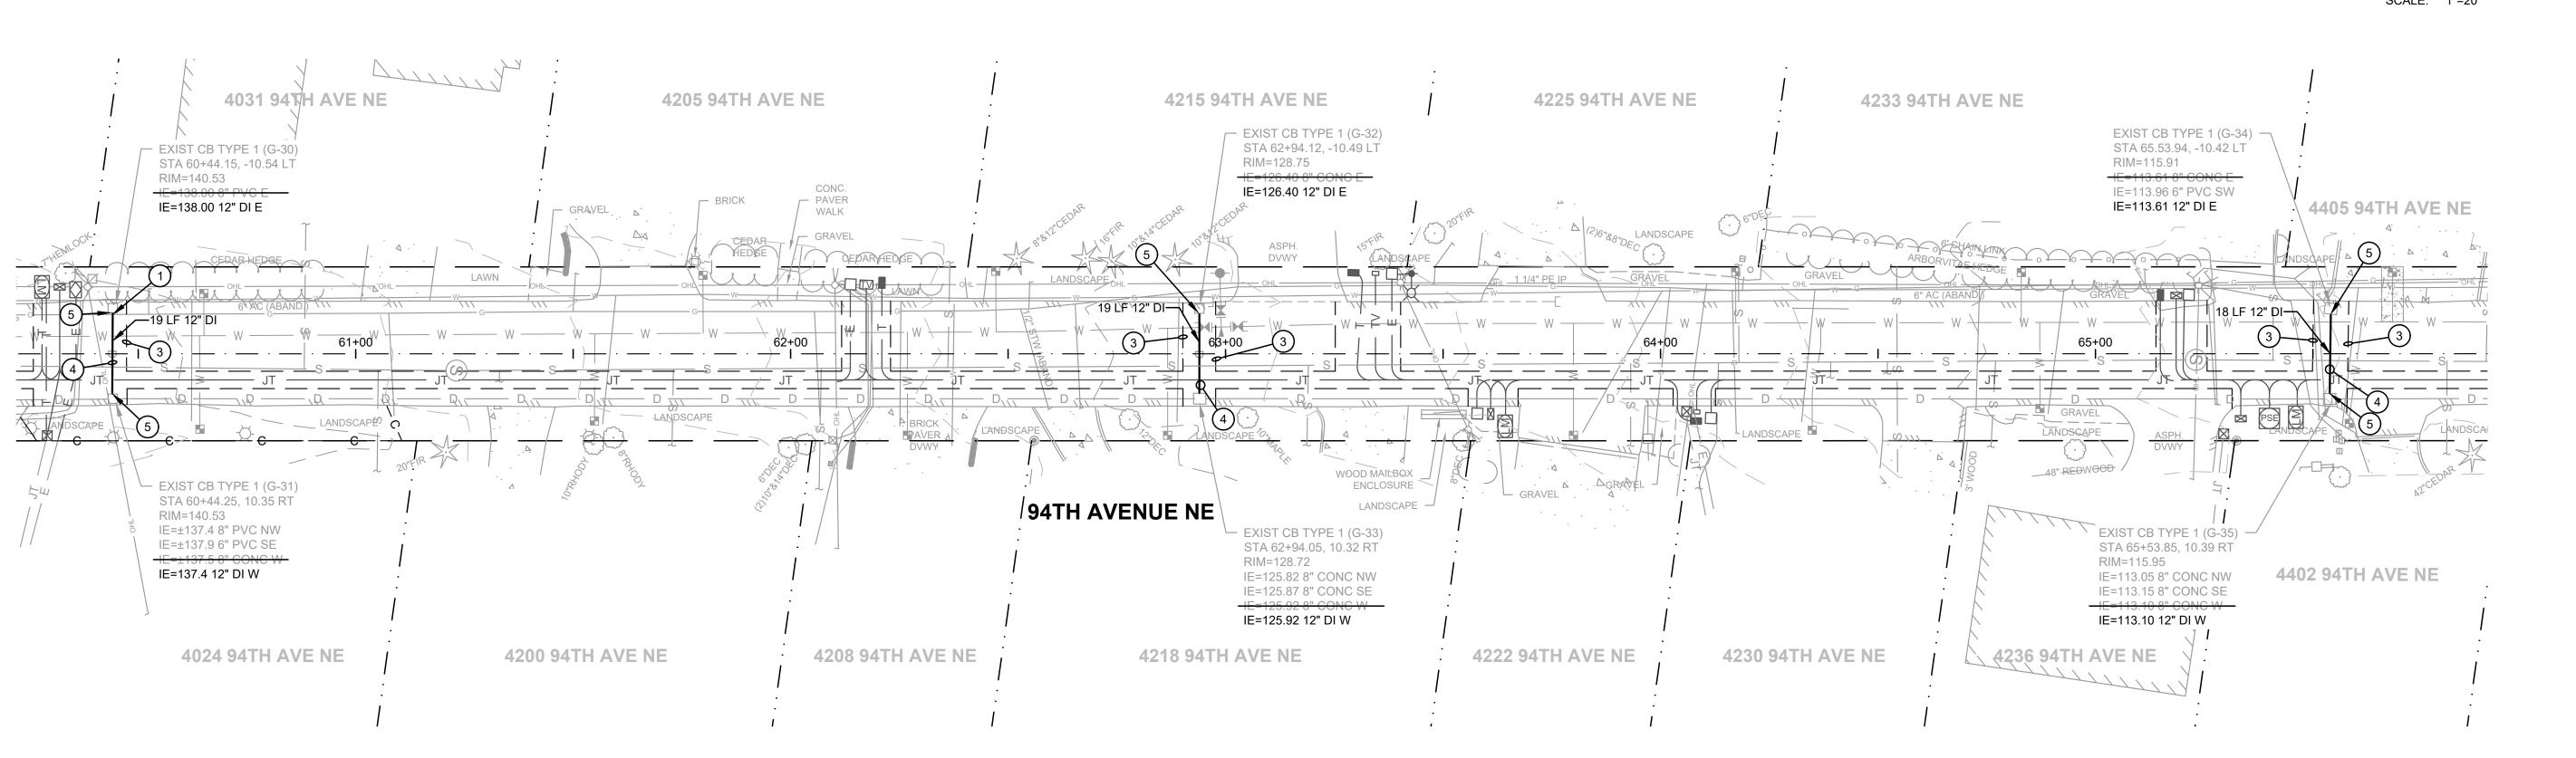



BUILDING B, SUITE 210 ARLINGTON, WA 98223 (360) 454-5490







### **TOWN OF** YARROW POINT

**TOWN WIDE STORMWATER AND UGC PROJECT** 

#### **GENERAL STORM DRAINAGE NOTES**

- 1. INSTALL BYPASS PUMPING, AS NEEDED, TO MAINTAIN STORWATER FLOW. BYPASS PUMPING SHALL BE INCLUDED IN THE UNIT BID PRICE FOR STORM PIPE.
- 2. IRRIGATION (PIPES, WIRES, SPRINKLER HEADS, ETC.) ENCOUNTERED SHALL BE CUT AT THE LIMITS OF EXCAVATION AND PIPES SHALL BE BROUGHT TO FINISHED
- 3. ALL NEW CATCH BASINS HAVE A VANED GRATE EXCEPT AS NOTED.

### **STORM DRAINAGE NOTES**

- CAUTION: POTENTIAL UTILITY CONFLICT. VERIFY (POTHOLE) EXACT LOCATION AND DEPTH OF EXISTING UTILITY. SEE ORDER OF WORK.
- 2 PROTECT EXISTING CONCRETE DRIVEWAY, RETAINING WALL, SURVEY MONUMENT, UNDERGROUND UTILITIES, AND MAILBOX STRUCTURES DURING CONSTRUCTION.
- 3 SAWCUT EXISTING PAVEMENT AND SEAL JOINT (WHERE APPLICABLE) THEN APPLY SAND BLANKET TO THE SURFACE JOINT.
- 4 REMOVE AND WASTEHAUL EXISTING STORM DRAINAGE STRUCTURE(S)/PIPE.
- CONNECT NEW STORM PIPE TO EXISTING CATCH BASIN. CORE DRILL IF KNOCK OUT IS NOT PRESENT.
- 6 CONNECT NEW STORM PIPE TO EXISTING STORM PIPE.
- REMOVE AND WASTEHAUL EXISTING MONUMENT. INSTALL PRECAST MONUMENT PER DETAIL, SHEET 38.

**BURIED UTILITIES IN AREA CALL BEFORE YOU DIG** 1-800-424-5555 EXISTING UTILITIES SHOWN ARE FROM THE BEST AVAILABLE INFORMATION AND NO GUARANTEE IS MADE AS TO THE EXACT SIZE, TYPE, LOCATION OR DEPTH

APPROVAL FOR CONSTRUCTION

APPROVAL EXPIRES: <u>JANUARY 2025</u>

Stand Schweder

- 8 ABANDON EXISTING PIPE PER SPECIFICATIONS.
- 9 REMOVE EXISTING ASBESTOS CEMENT PIPE AS NEEDED.
- 10 CONNECT NEW STORM PIPE TO EXISTING STORM PIPE W / INSERT-A-TEE. PROTECT EXIST. CONC. IN THE ROAD PRISM.
- 11 CAP STORM STUB AT R/W.

No. DATE REVISION ISSUED FOR: **BID PLAN SET** 

ISSUE DATE: JAN 2024 APPROVED BY: KWB CHECKED BY: KWB DRAWN BY: CJB CJB DESIGNER: G & O JOB NO.: 23445 STORM P&P.DWG

> TWO INCHES AT FULL SCALE. IF NOT, SCALE ACCORDINGLY

CIVIL

STORM PLAN &

DRAWING: 8

**PROFILE** 


of: **40** 


RIGHT-OF-WAY DISCLAIMER

THE RIGHT-OF-WAY AND/OR PROPERTY LINES SHOWN HEREON ARE BASED ON AVAILABLE LOCATION AND ARE ONLY APPROXIMATE.

BY: TOWN OF YARROW POINT INFORMATION, NOT ON A SURVEYED

DATE: JANUARY 2024

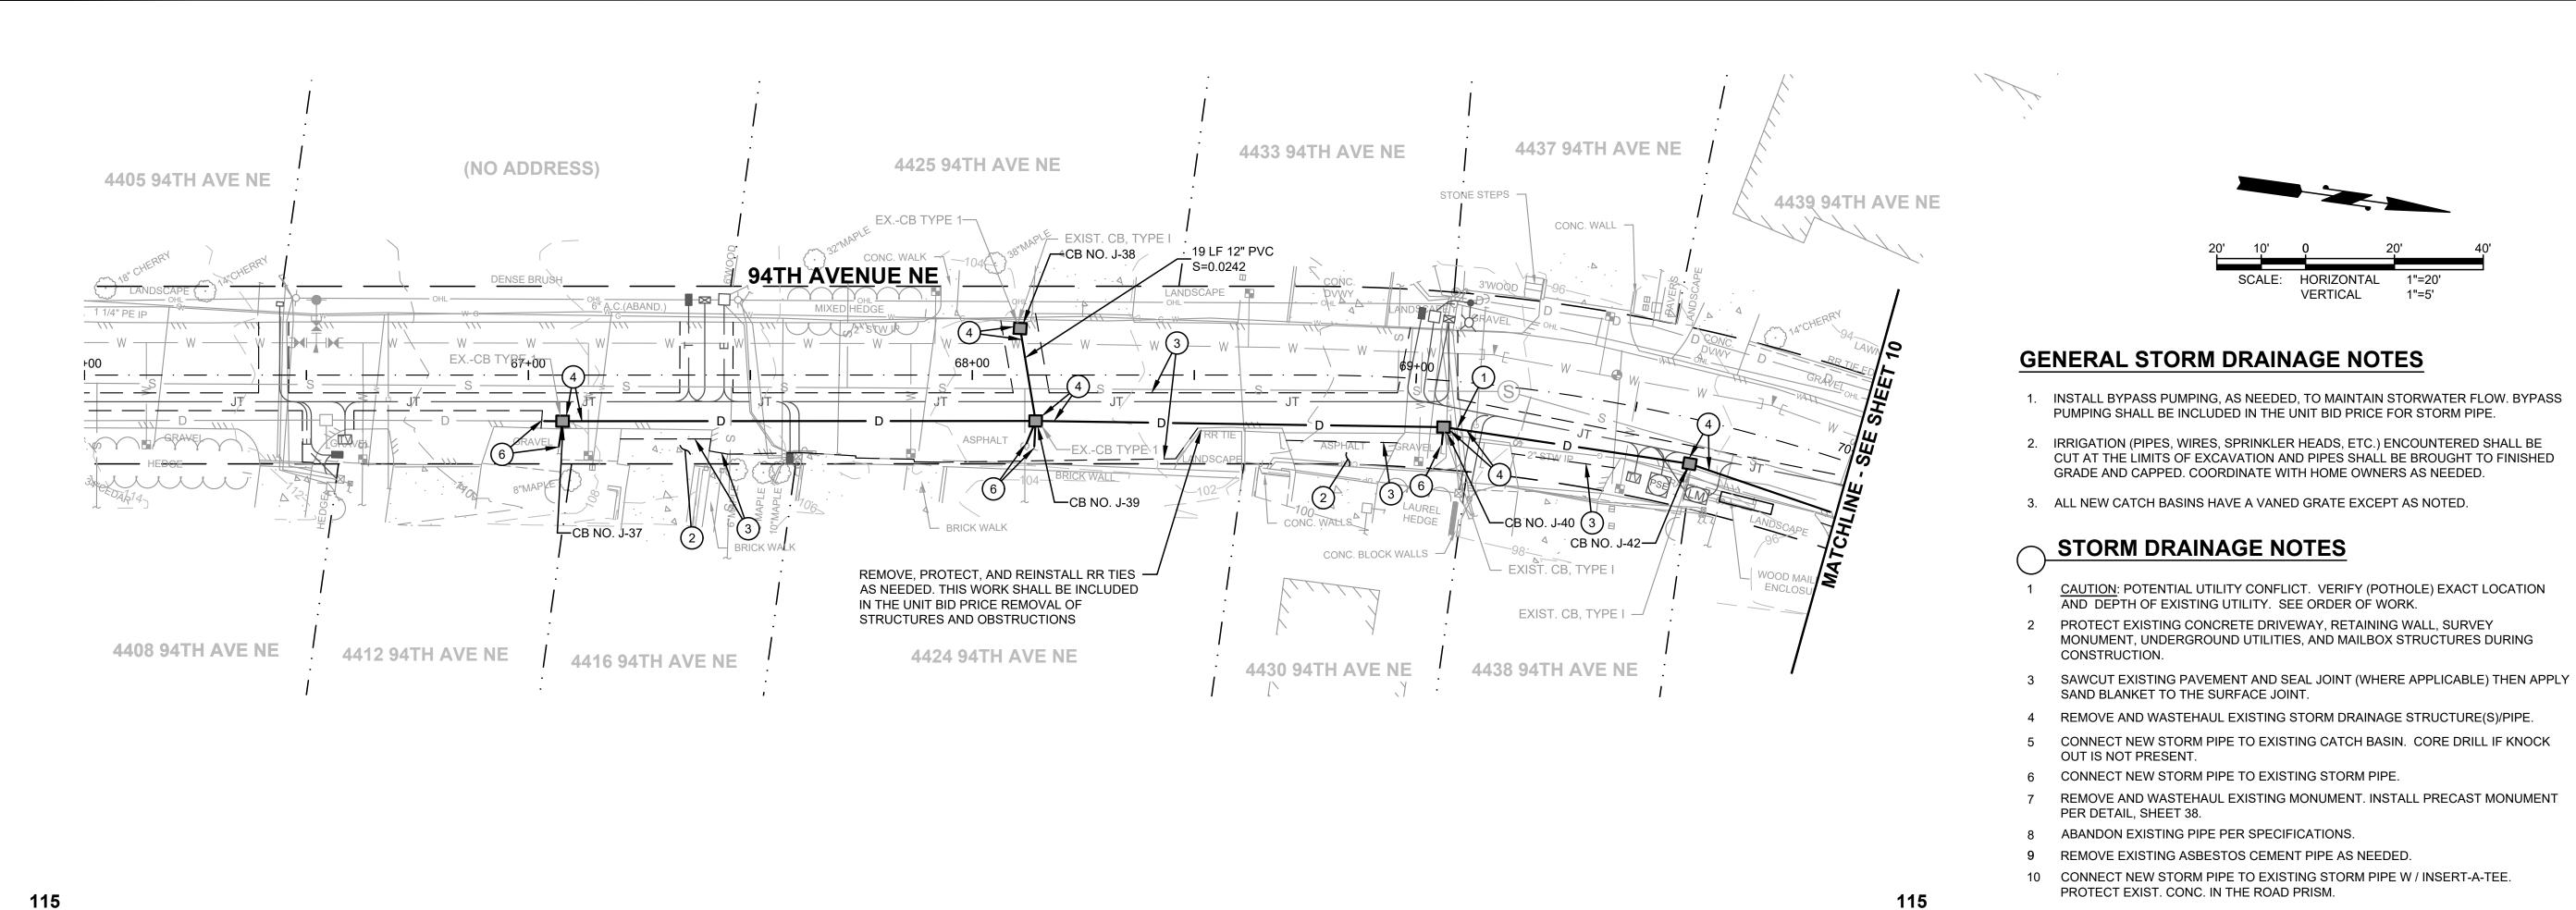

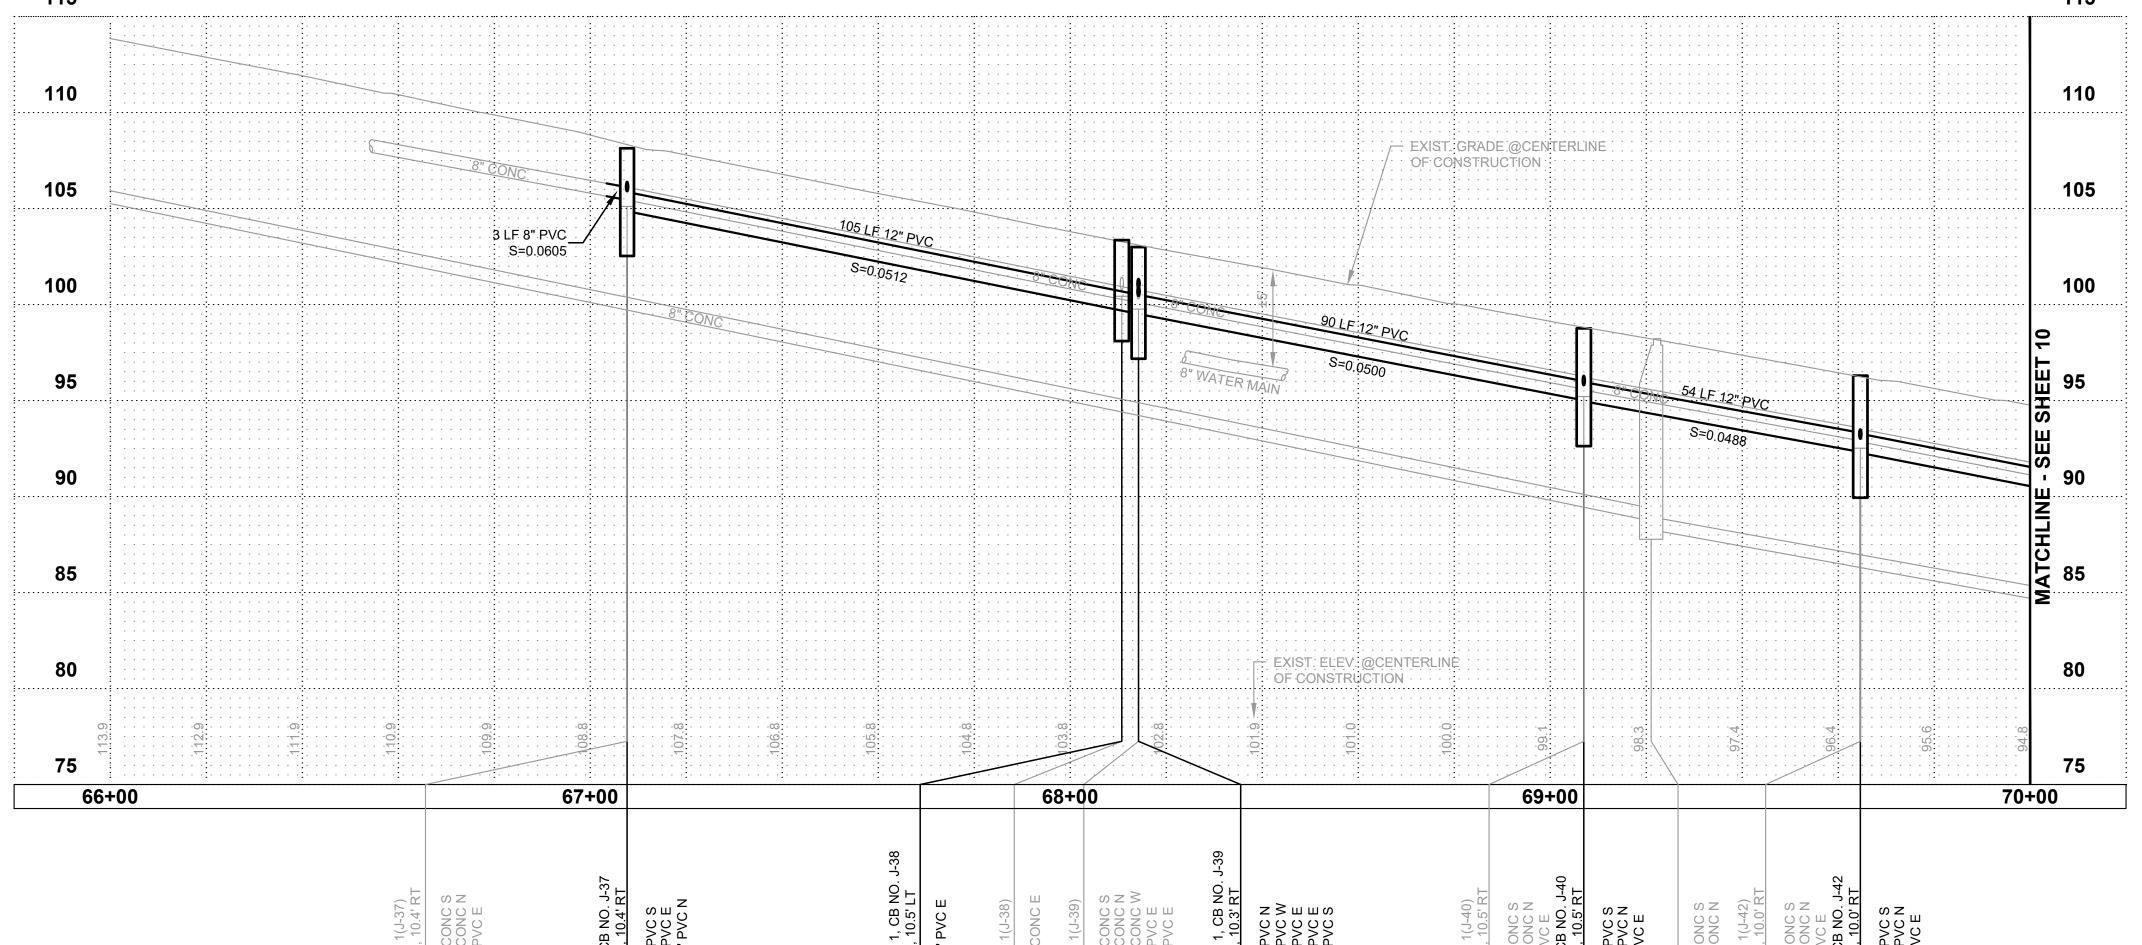




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#### **TOWN OF** YARROW POINT

**TOWN WIDE STORMWATER AND UGC PROJECT** 

No. DATE REVISION ISSUED FOR: **BID PLAN SET** ISSUE DATE: JAN 2024 APPROVED BY: KWB KWB CHECKED BY: CJB DRAWN BY:

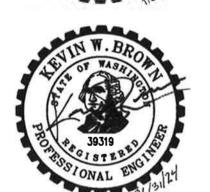TWO INCHES AT FULL SCALE IF NOT, SCALE ACCORDINGLY

CJB

23445

STORM P&P.DWG

CIVIL

DESIGNER:

G & O JOB NO.:

**BURIED UTILITIES IN AREA CALL BEFORE YOU DIG** 1-800-424-5555 EXISTING UTILITIES SHOWN ARE FROM THE BEST AVAILABLE INFORMATION AND NO GUARANTEE IS MADE AS TO THE EXACT SIZE, TYPE, LOCATION OR DEPTH

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11 CAP STORM STUB AT R/W.

#### **APPROVAL FOR CONSTRUCTION**

HORIZONTAL VERTICAL

1"=5'

BY: TOWN OF YARROW POINT

APPROVAL EXPIRES: <u>JANUARY 2025</u>


RIGHT-OF-WAY DISCLAIMER

DATE: JANUARY 2024

OF: **40** DRAWING:

STORM PLAN &


**PROFILE** 

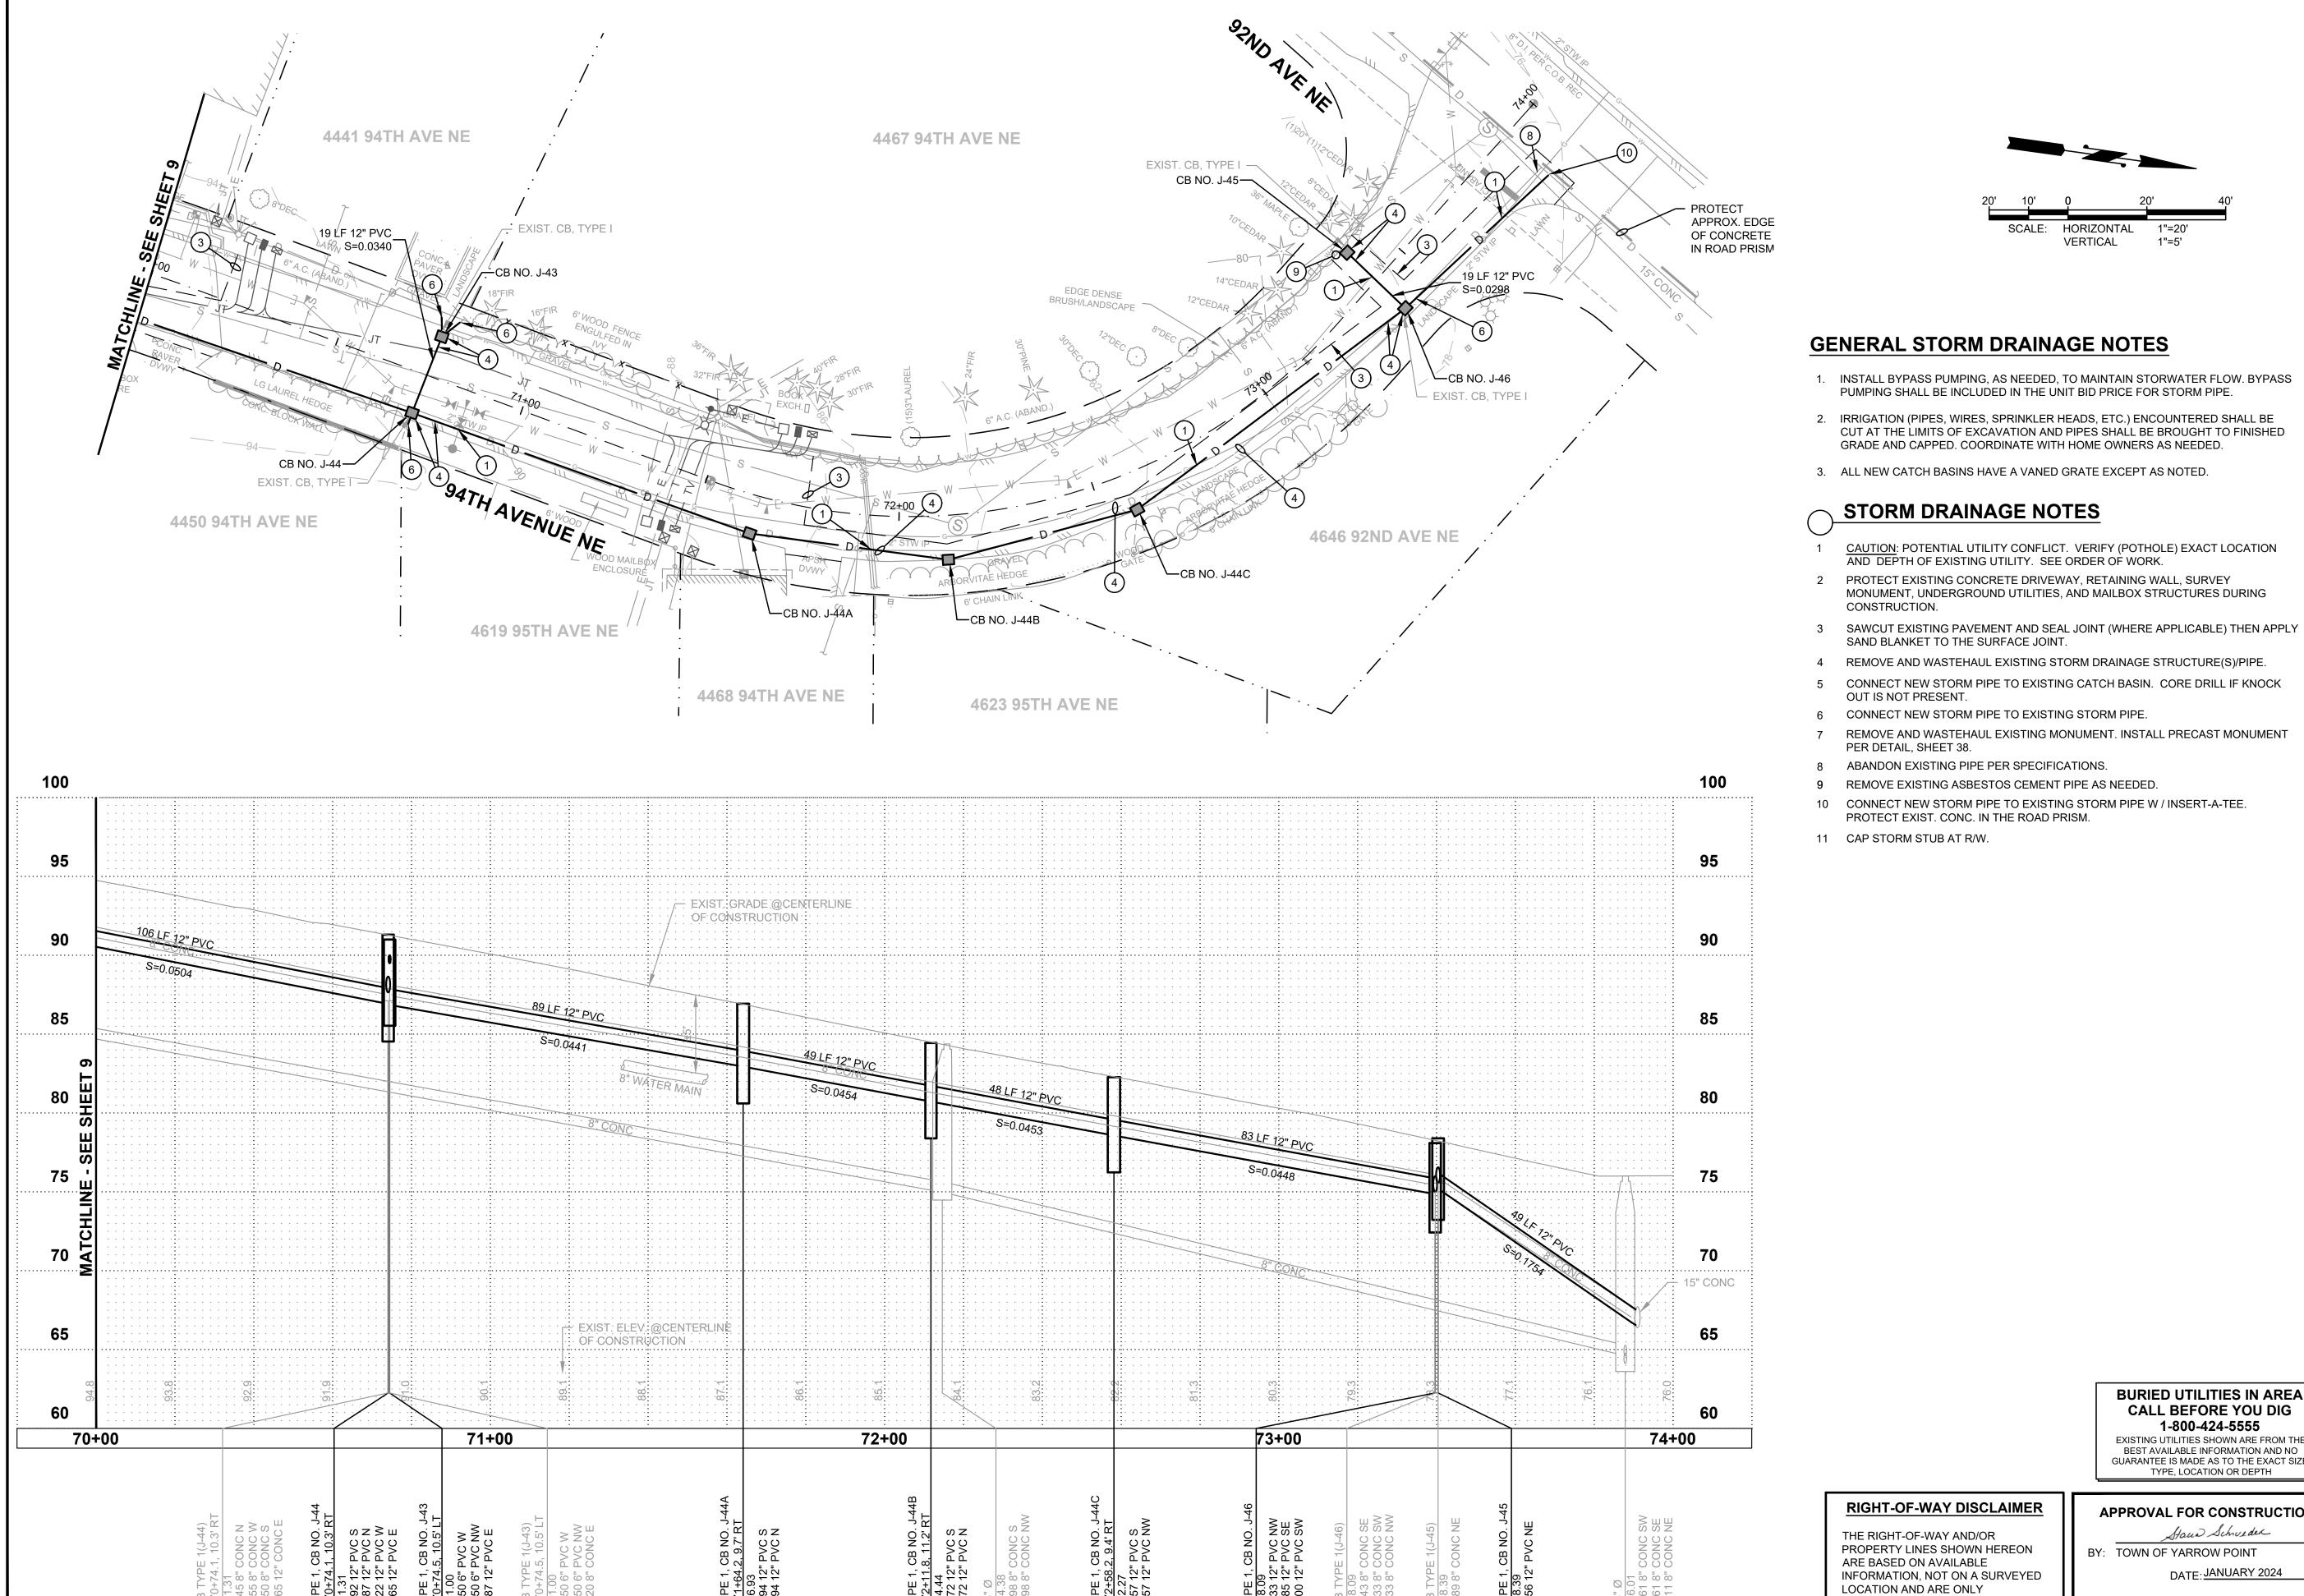




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**TOWN OF YARROW POINT** 

**TOWN WIDE** STORMWATER AND **UGC PROJECT** 

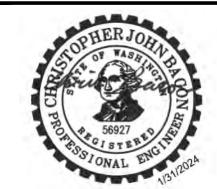No. DATE REVISION ISSUED FOR: **BID PLAN SET** ISSUE DATE: JAN 2024 APPROVED BY: KWB

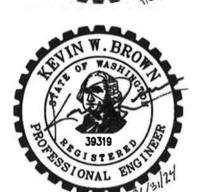CJB DRAWN BY: CJB DESIGNER: G & O JOB NO.: 23445 STORM P&P.DWG

CHECKED BY:

KWB

TWO INCHES AT FULL SCALE IF NOT, SCALE ACCORDINGLY

CIVIL

**CALL BEFORE YOU DIG** 1-800-424-5555 EXISTING UTILITIES SHOWN ARE FROM THE BEST AVAILABLE INFORMATION AND NO GUARANTEE IS MADE AS TO THE EXACT SIZE, TYPE, LOCATION OR DEPTH

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#### **APPROVAL FOR CONSTRUCTION**

**BURIED UTILITIES IN AREA** 

BY: TOWN OF YARROW POINT

APPROVAL EXPIRES: <u>JANUARY 2025</u>

HORIZONTAL

1"=5'


VERTICAL


DATE: JANUARY 2024


DRAWING: 10 OF: 40

STORM PLAN &

**PROFILE** 

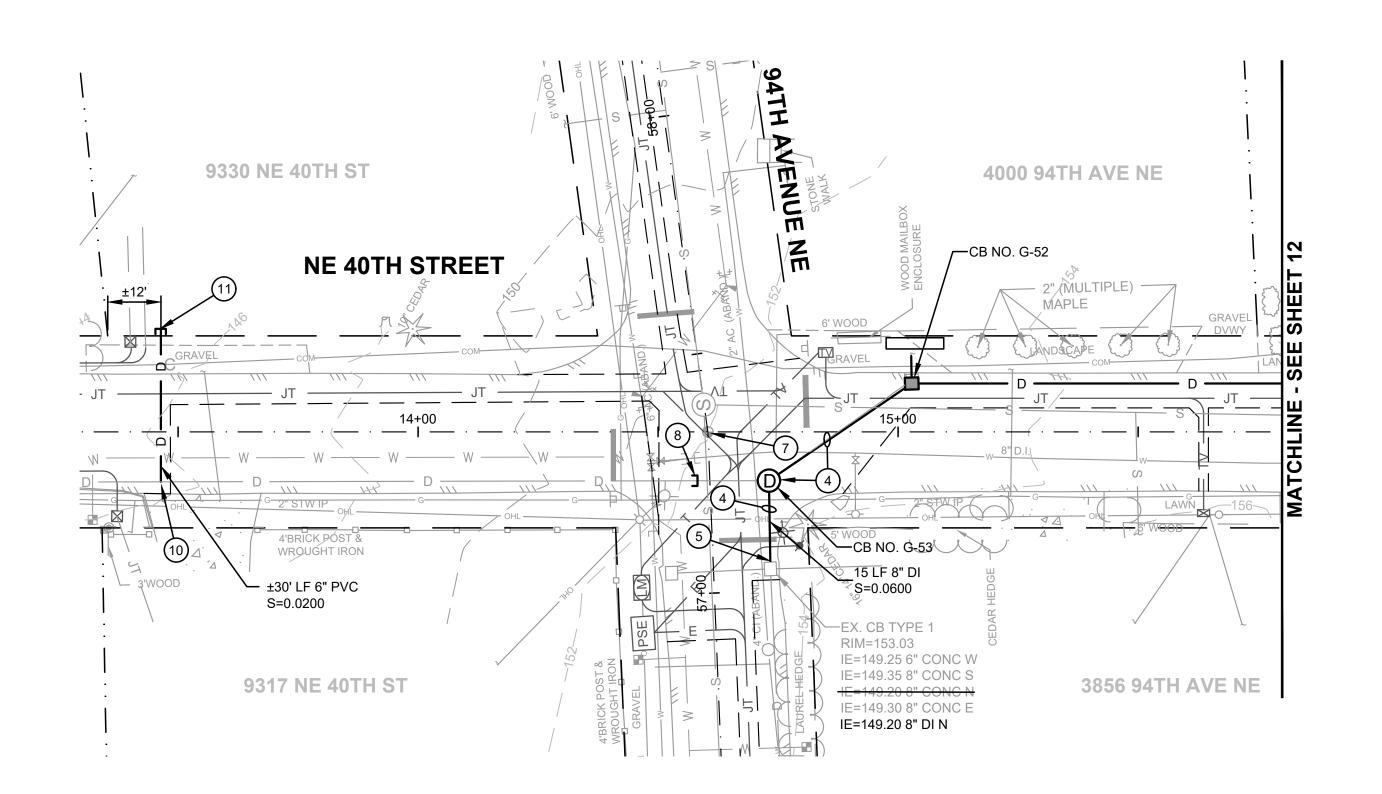

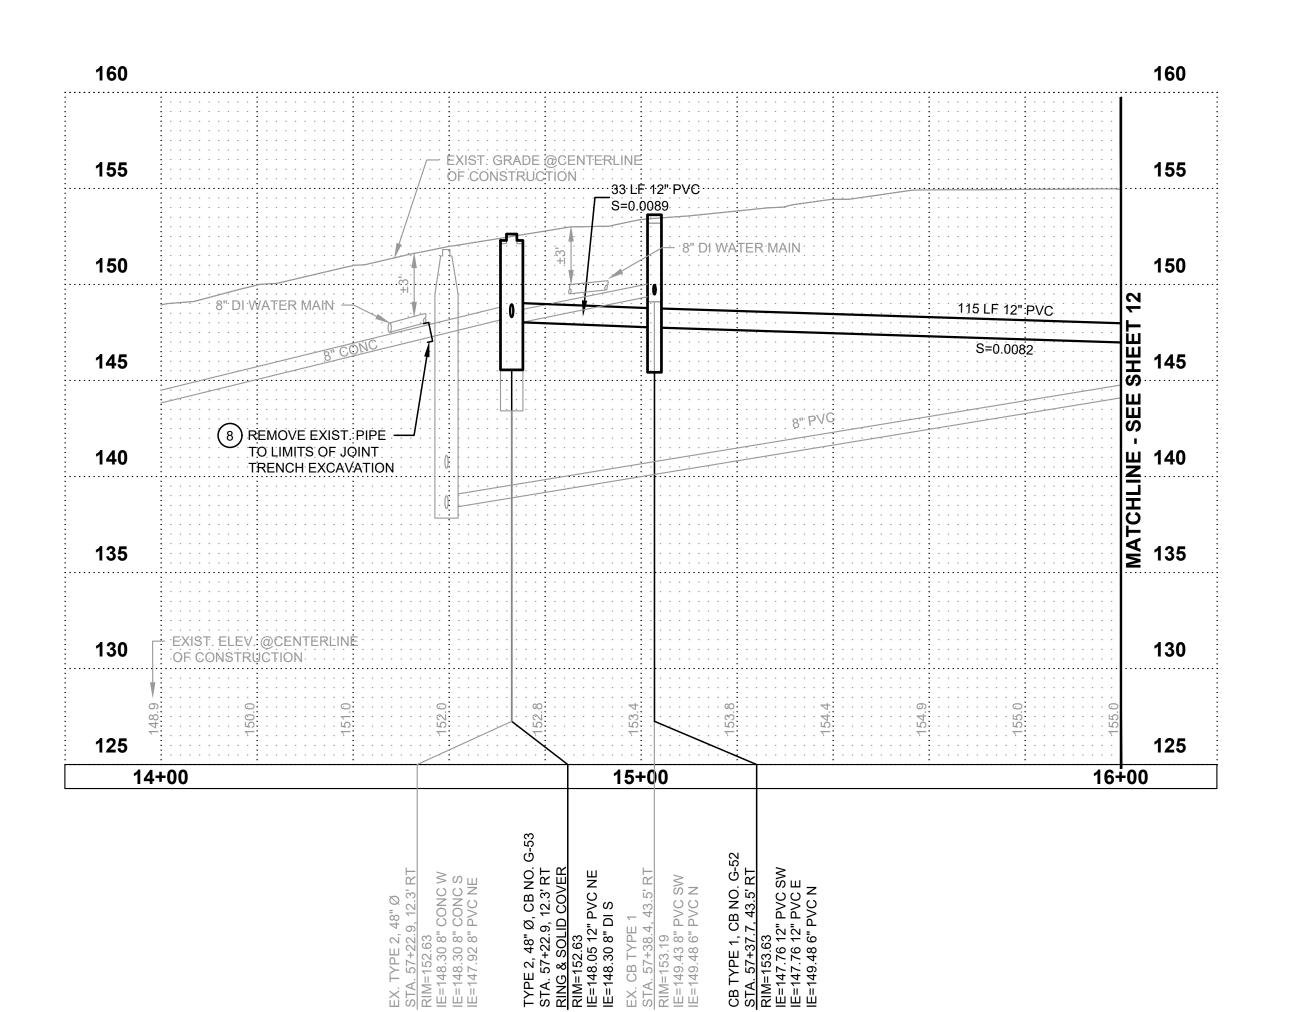

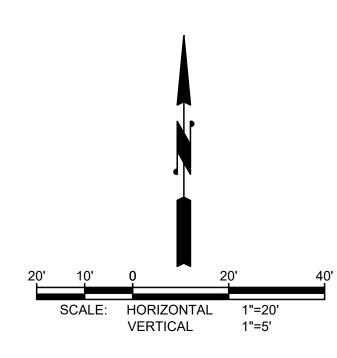

### **GENERAL STORM DRAINAGE NOTES**

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## TOWN OF YARROW POINT

TOWN WIDE STORMWATER AND UGC PROJECT

No. DATE REVISION

ISSUED FOR:
BID PLAN SET

ISSUE DATE: JAN 2024

APPROVED BY: KWB

CHECKED BY: KWB

DRAWN BY: CJB

DESIGNER: CJB

G & O JOB NO.: 23445

FILE: STORM P&P.DWG

TWO INCHES AT FULL SCALE.
IF NOT, SCALE ACCORDINGLY

CIVIL

BURIED UTILITIES IN AREA CALL BEFORE YOU DIG 1-800-424-5555

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#### APPROVAL FOR CONSTRUCTION

Staw Schweder
BY: TOWN OF YARROW POINT

APPROVAL EXPIRES: <u>JANUARY 2025</u>


DATE: JANUARY 2024


- 11


PROFILE

STORM PLAN &

DRAWING: 11 OF: 40

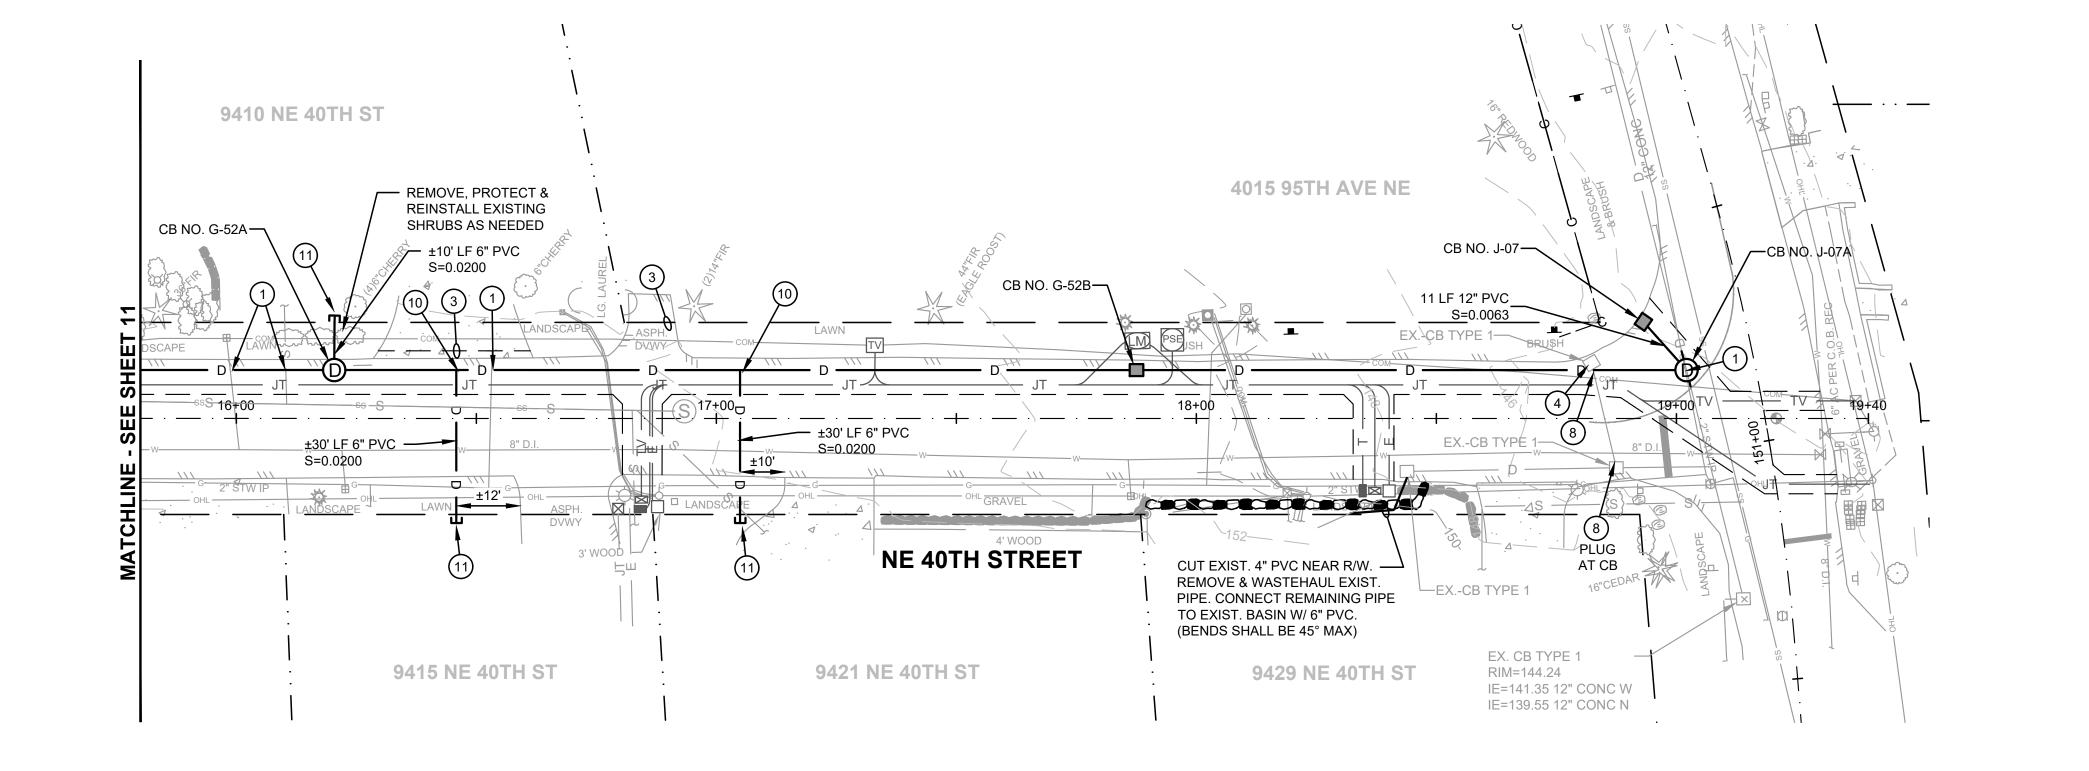

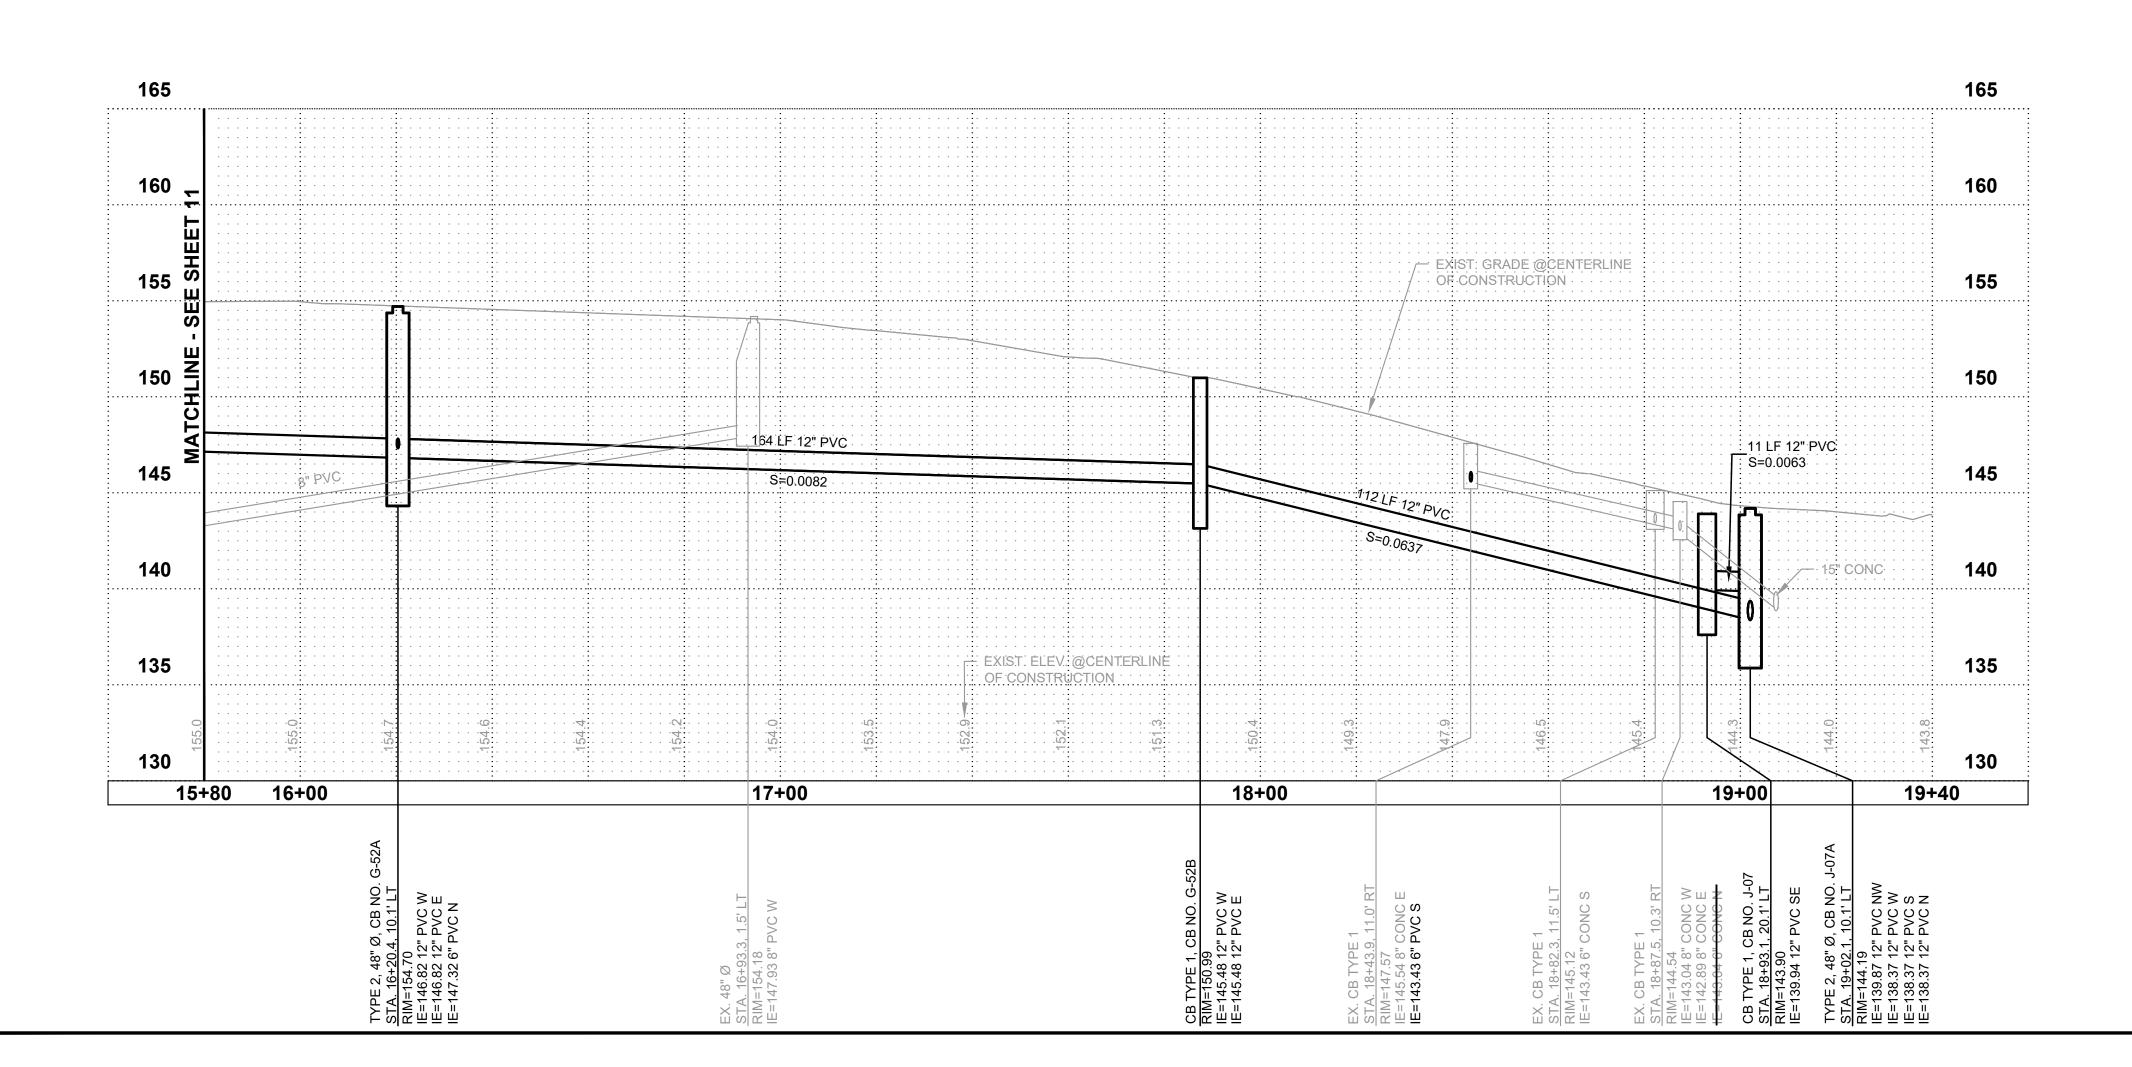

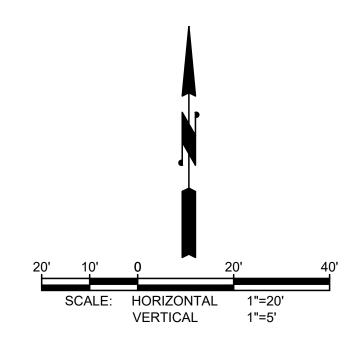

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3710 168TH STREET NORTHEAST BUILDING B, SUITE 210 ARLINGTON, WA 98223 (360) 454-5490







## TOWN OF YARROW POINT

TOWN WIDE STORMWATER AND UGC PROJECT

No. DATE REVISION  SSUED FOR:  BID PLAN SET  SSUE DATE: JAN 2024  APPROVED BY: KWB			
BID PLAN SET SSUE DATE: JAN 2024	No.	DATE	REVISION
SSUE DATE: JAN 2024	SSUE	D FOR:	
			BID PLAN SET
PPROVED BY: KWB	SSUE	DATE:	JAN 2024
	PPR	OVED BY:	KWB

0 1" 2"
TWO INCHES AT FULL SCALE.

KWB

CJB

CJB

23445

CHECKED BY:

DRAWN BY:

DESIGNER:

G & O JOB NO.:

CIVIL

IF NOT, SCALE ACCORDINGLY

BURIED UTILITIES IN AREA CALL BEFORE YOU DIG 1-800-424-5555

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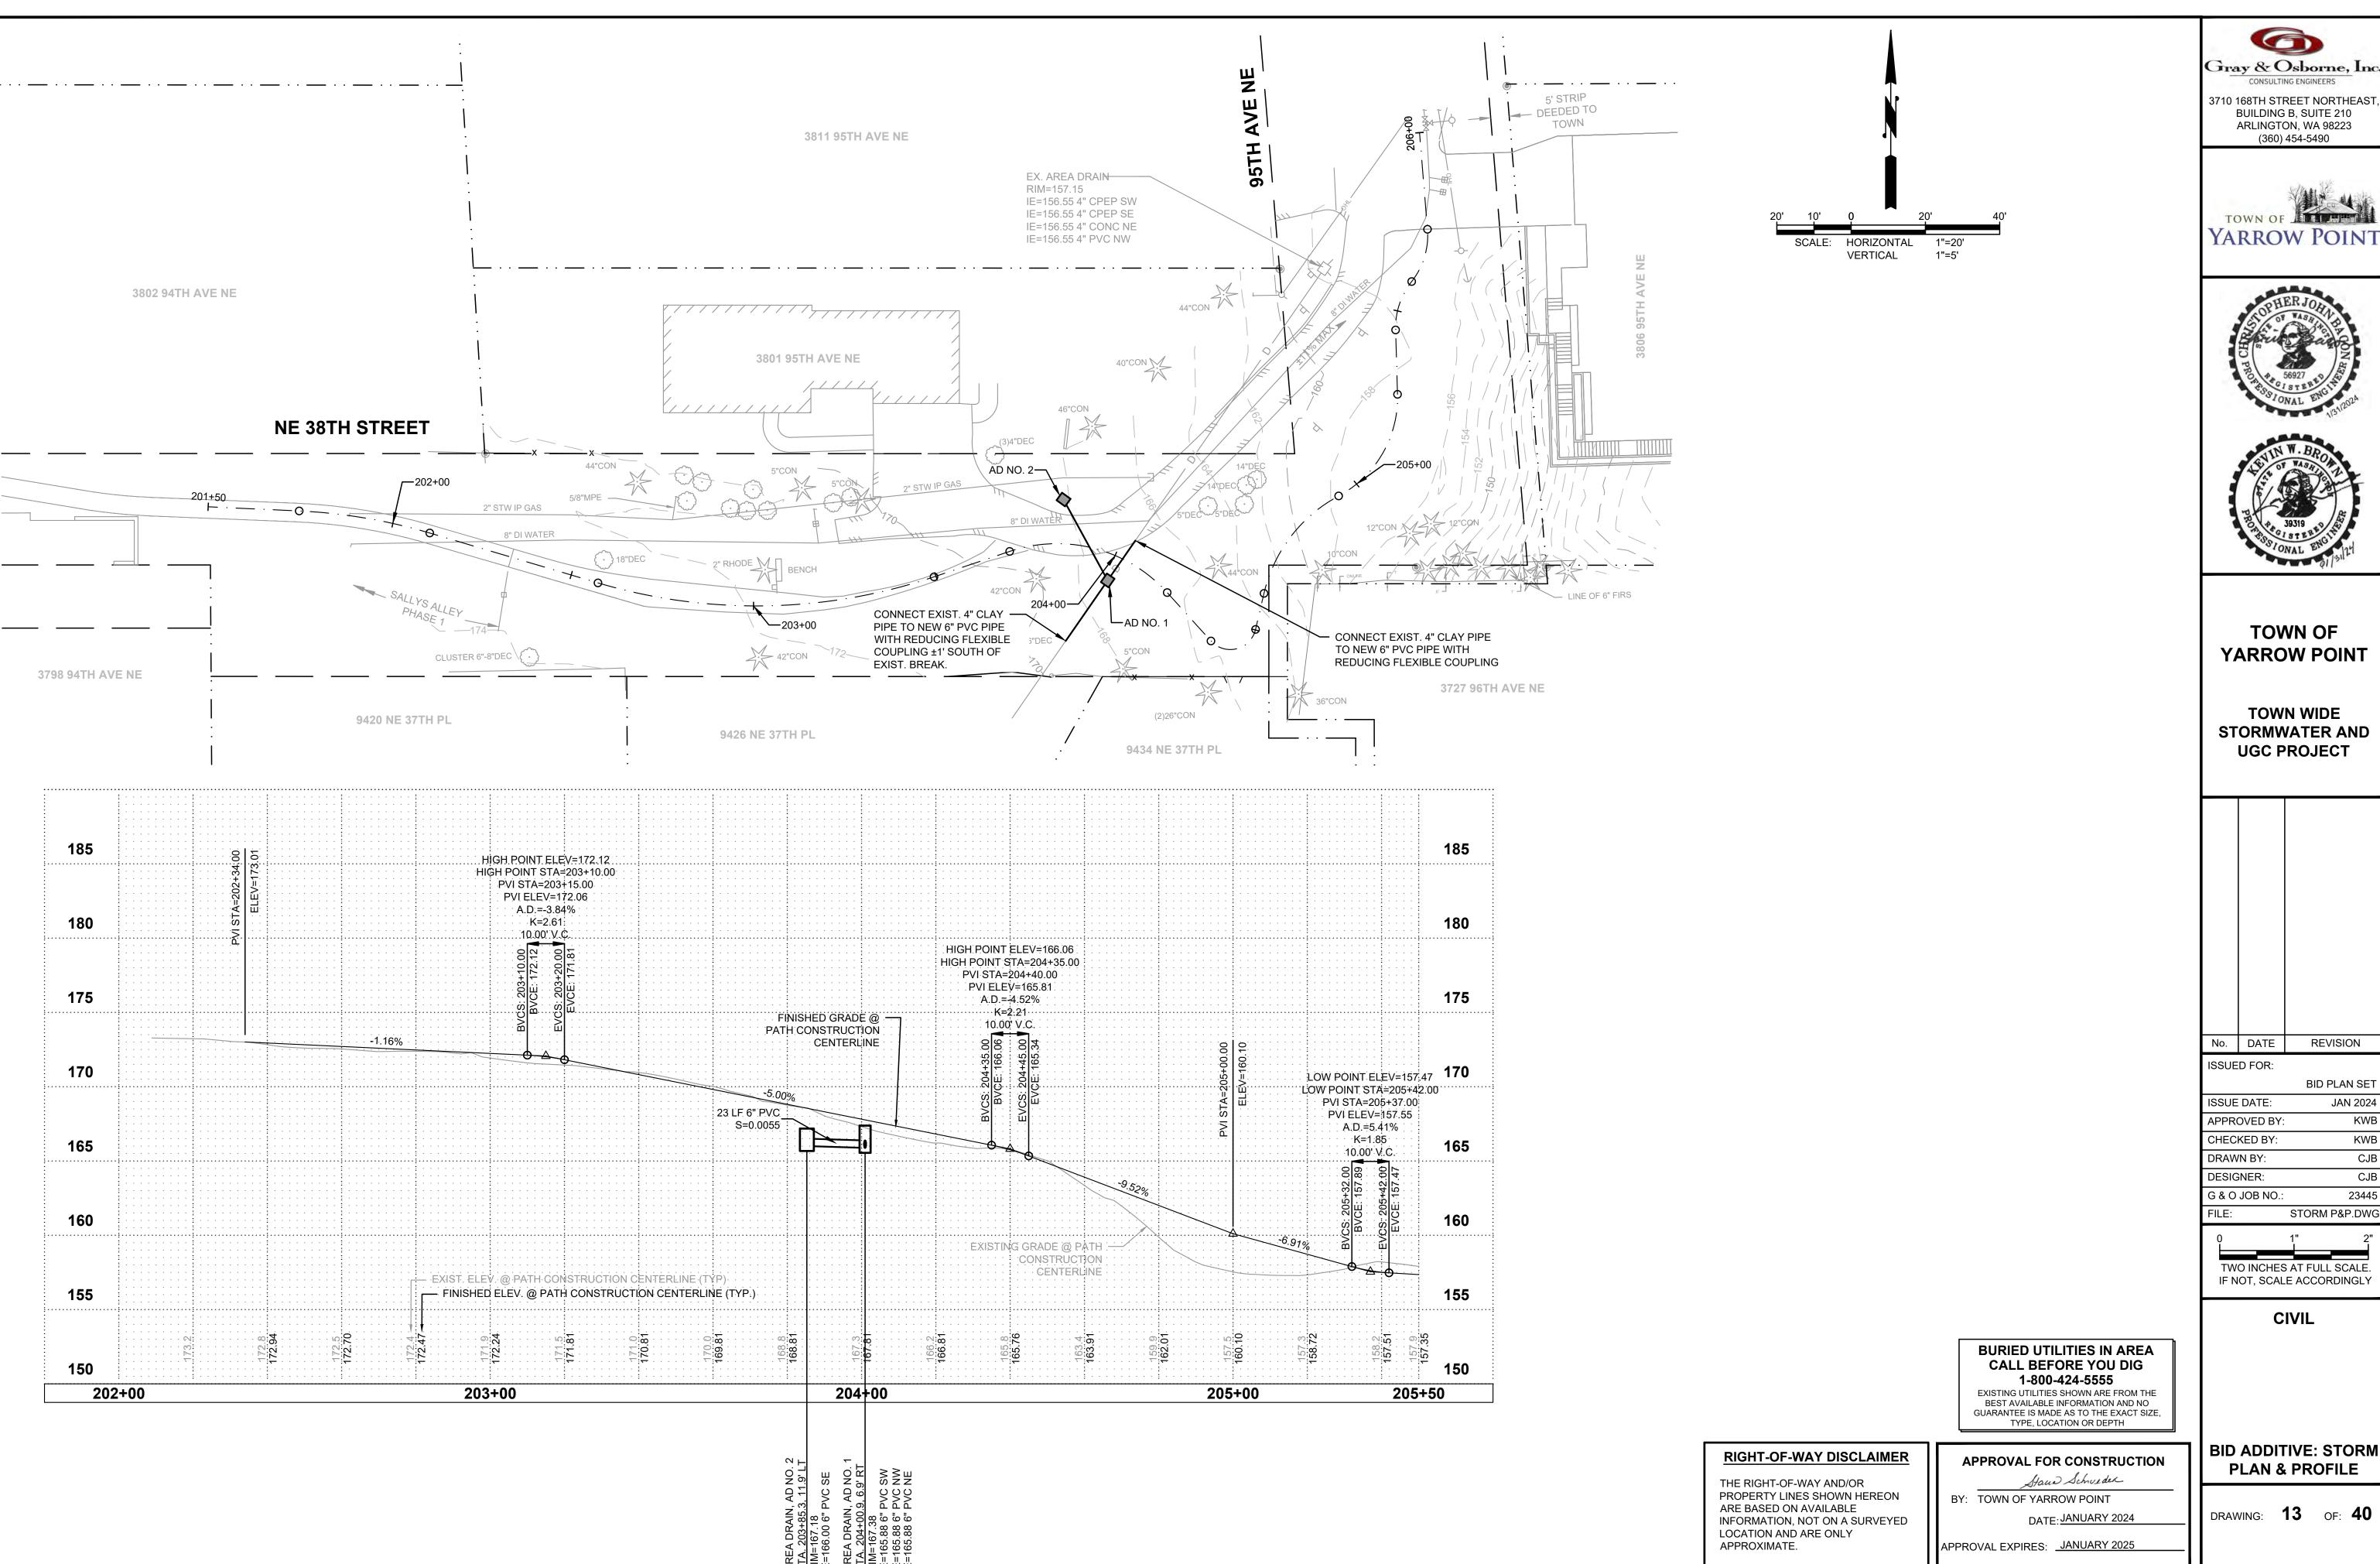
Stand Schweder
BY: TOWN OF YARROW POINT

DATE: JANUARY 2024

APPROVAL EXPIRES: <u>JANUARY 2025</u>

STORM PLAN & PROFILE

DRAWING: **12** OF: **40** 



Gray & Osborne, Inc.

> 3710 168TH STREET NORTHEAST BUILDING B, SUITE 210 ARLINGTON, WA 98223 (360) 454-5490







#### **TOWN OF** YARROW POINT

**TOWN WIDE** STORMWATER AND **UGC PROJECT** 

No.	DATE	REVISION


**BID PLAN SET** ISSUE DATE: JAN 2024 APPROVED BY: KWB CHECKED BY: KWB CJB DRAWN BY: CJB DESIGNER: 23445 G & O JOB NO.:

TWO INCHES AT FULL SCALE. IF NOT, SCALE ACCORDINGLY

STORM P&P.DWG


CIVIL

DRAWING: 13 OF: 40

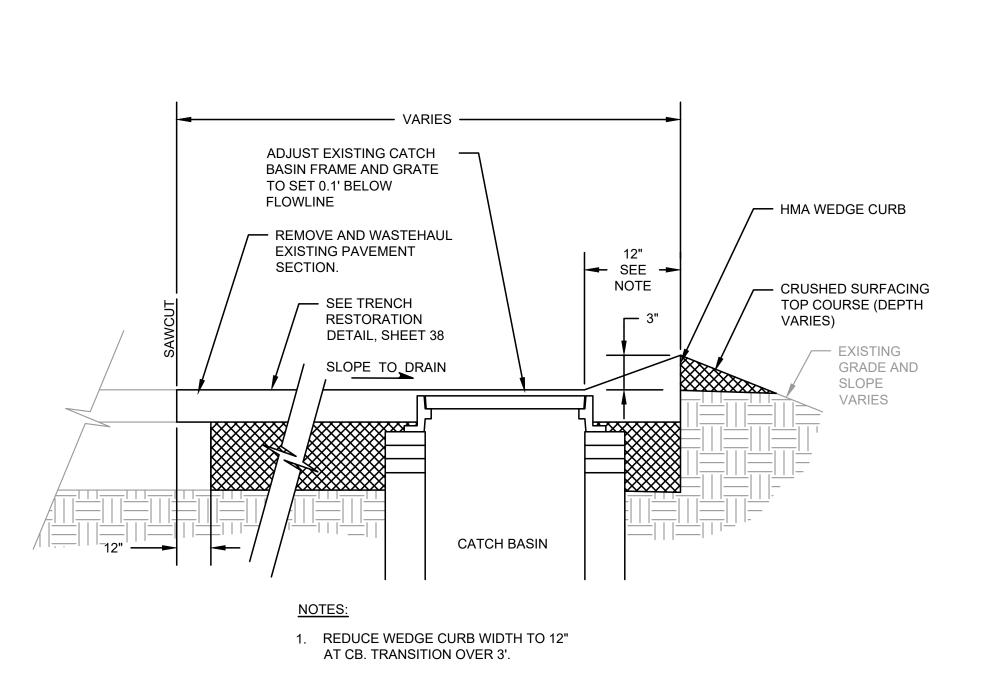

## **CATCH BASIN PLACEMENT DETAIL**

NOT TO SCALE

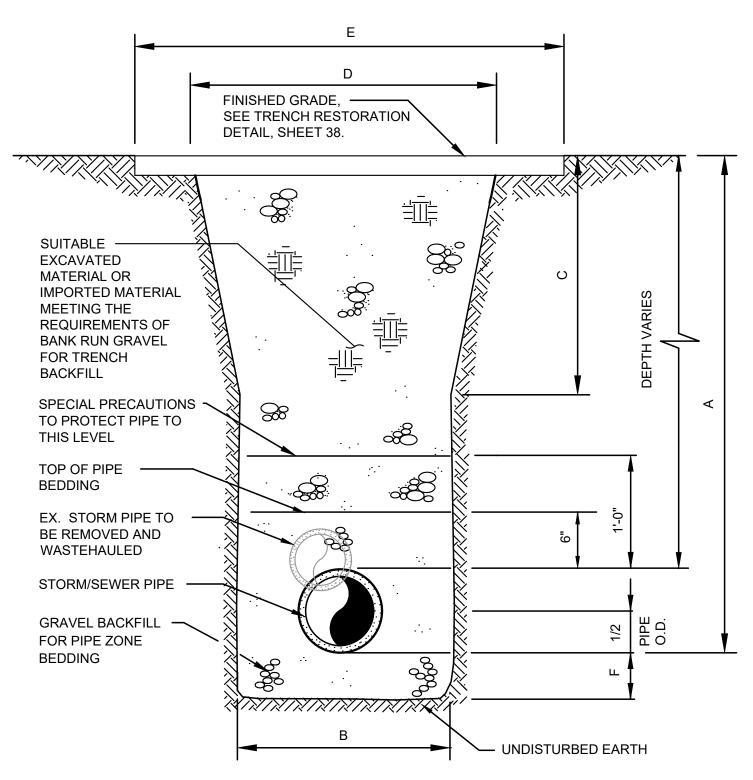


#### **TYPICAL** TRENCH SECTION

NOT TO SCALE

		4", 6", & 8" DIAMETER PIPE										
А	6' OR LESS	8'	10'	12'	14'	16'	18'	20'	22'	24'	26'	28'
В		2.50'										
С	1.50'	1.50'	1.75'	2.25'	2.75'	3.25'	3.75'	4.25'	4.75'	5.25'	5.75'	6.25
D	5.50'	5.50' 5.50' 6.00' 7.00' 8.00' 9.00' 10.00' 11.00' 12.00' 13.00' 14.00' 15.00'										
E						SEE F	LANS					•
F			-			4	in					

			12"	DIAN	/IETE	ER P	IPE					
А	6' OR LESS	8'	10'	12'	14'	16'	18'	20'	22'	24'	26'	28'
В						4.	50'					
С	1.50'	1.50'	1.75'	2.25'	2.75'	3.25'	3.75'	4.25'	4.75'	5.25'	5.75'	6.25'
D	7.50'	7.50'	8.00'	9.00'	10.00'	11.00'	12.00'	13.00'	14.00'	15.00'	16.00	17.00
E	8.50'	8.50'	9.00'	10.00'	11.00'	12.00'	13.00'	14.00'	15.00'	16.00'	17.00	18.00
F						6	in					

#### **PAYMENT LIMIT SCHEDULE**

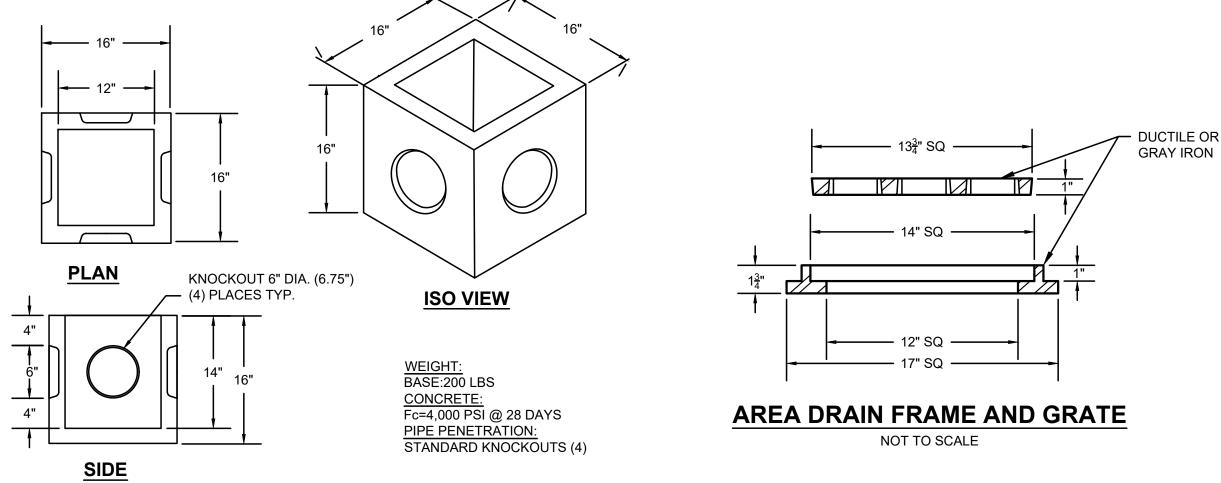

**AREA DRAIN** 



3710 168TH STREET NORTHEAST BUILDING B, SUITE 210 ARLINGTON, WA 98223 (360) 454-5490





STRUCTURE SIZE AND TYPE

NEW STORM

PLANS FOR

LOCATION)

PIPE (SEE

PER PLANS

"GPK" GASKETED HEAVY DUTY SAND

2. IN ORDER TO MAKE CONNECTION TO EX.

IN THE COST OF THE STRUCTURE.

PIPE, INSTALL 3' LENGTH OF NEW STORM

PIPE (SIZE TO MATCH EX. PIPE) AND FERNCO

ADAPTOR. THIS WORK SHALL BE INCLUDED

**CATCH BASIN CONNECTION DETAIL** 

(SIZE AS REQUIRED)

COLLAR REQUIRED FOR ALL CONNECTIONS.

NOTES:

EXISTING PIPE,

SEE NOTE 2, TYP.

TYP.

**NEW PIPE** 

(3' LONG), TYP.

— GROUT (TYP.)

SEE NOTE 1 (TYP.)

6" GRAVEL BACKFILL

FOR FOUNDATIONS

- UNDISTURBED OR COMPACTED

APPROVAL FOR CONSTRUCTION


BY: TOWN OF YARROW POINT

APPROVAL EXPIRES: <u>JANUARY 2025</u>

Stand Schweder

DATE: JANUARY 2024

SUB-GRADE

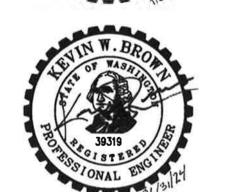

**TOWN OF** YARROW POINT

**TOWN WIDE** STORMWATER AND **UGC PROJECT** 

REVISION No. DATE

ISSUED FOR: **BID PLAN SET** ISSUE DATE: JAN 2024 APPROVED BY: KWB CHECKED BY: KWB CJB DRAWN BY: CJB DESIGNER: 23445 G & O JOB NO.:

TWO INCHES AT FULL SCALE IF NOT, SCALE ACCORDINGLY

**DETAILS.DWG** 

CIVIL

STORM DETAILS


DRAWING: 14 OF: 40

NOT TO SCALE

DRAWN BY: LISA CYFORD

AL .	REINFO PLAIN C	ALL ME	CPSSP (STD. SF	SOLID V (STD. SF	PROFILE (STD. SF
				şi/	Ś
7				35/ 50/	


NCES	MAXIMUM INSIDE DIAMETER (INCHES)	12"	15"	12"	15"	15"
PIPE ALLOWANCES	PIPE MATERIAL	REINFORCED OR PLAIN CONCRETE	ALL METAL PIPE	CPSSP ★ (STD. SPEC. SECT. 9-05.20)	SOLID WALL PVC (STD. SPEC. SECT. 9-05.12(1))	PROFILE WALL PVC

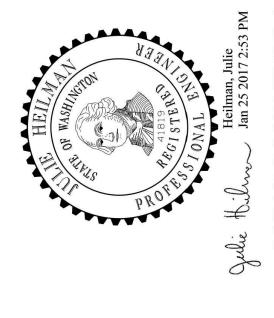

Y------



DRAWN BY: FERN LIDDELL

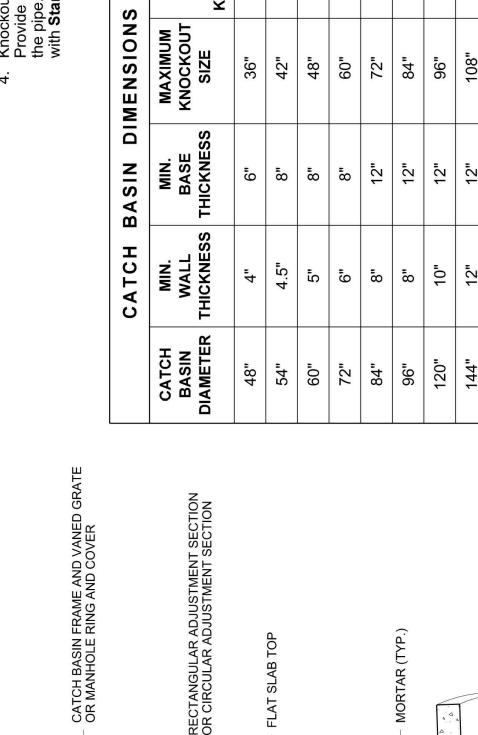


Z" MIN. \_:XAM "81\_

15' - 0" MAX. (FOR MAINTENANCE)

PIPE ALI	IAL WIT	ALL	30.	36"	42"	54"	09	72"	84"	96
PIPE	PIPE MATERIAL WIT	CONCRETE	24"	30"	36"	42"	54"	.09	99	18"
	CATCH	BASIN	48"	54"	.09	72"	84"	96	120"	144"
	∑" <u></u> Z"		.XA	Z S X X X X X X X X X X X X X X X X X X	Z _			SE INTEGRAL BASE PRECAST WITH RISER	(48" (IN) - 72" (IN) ONLY)	

	PIPE	E ALLO	PIPE ALLOWANCES		
CATCH	PIPE MATERIAL WITH MAXIMUM INSIDE DIAMETER	IAL WITH N	MAXIMUM IN	SIDE DIAM	ETER
BASIN	CONCRETE	ALL	CPSSP (1)	SOLID	PROFILE
DIAMETER		METAL	<b>PP</b> (4)	$\frac{WALL}{PVC^{(2)}}$	WALL PVC ③
48"	24"	30"	24"	30"	30"
54"	30	36"	30	36"	36"
09	36"	42"	36"	42"	42"
72"	42"	54"	42"	48"	48"
84"	54"	09	54"	48"	48"
96	09	72"	09	48"	48"
120"	99	84"	09	48"	48"
144"	82	96	09	48"	48"
1) Corrugated	1) Corrugated Polyethylene Storm Sewer Pipe	Storm Sew	er Pine		

- (1) Corru (See (2) (See (3) (See (4) Polyp
- **TOWN OF** YARROW POINT **TOWN WIDE** STORMWATER AND **UGC PROJECT**

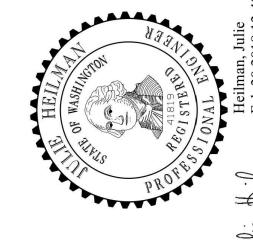


TOWN OF YARROW POINT

6

Gray & Osborne, Inc.

3710 168TH STREET NORTHEAST, BUILDING B, SUITE 210 ARLINGTON, WA 98223 (360) 454-5490

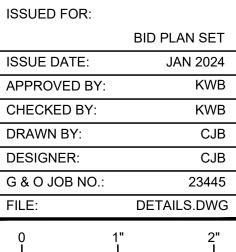

No. DATE REVISION

TWO INCHES AT FULL SCALE IF NOT, SCALE ACCORDINGLY CIVIL

STORM DETAILS

APPROVAL FOR CONSTRUCTION


BY: TOWN OF YARROW POINT

APPROVAL EXPIRES: JANUARY 2025

Stand Schweder

DATE: JANUARY 2024


DRAWING: 15 OF: 40

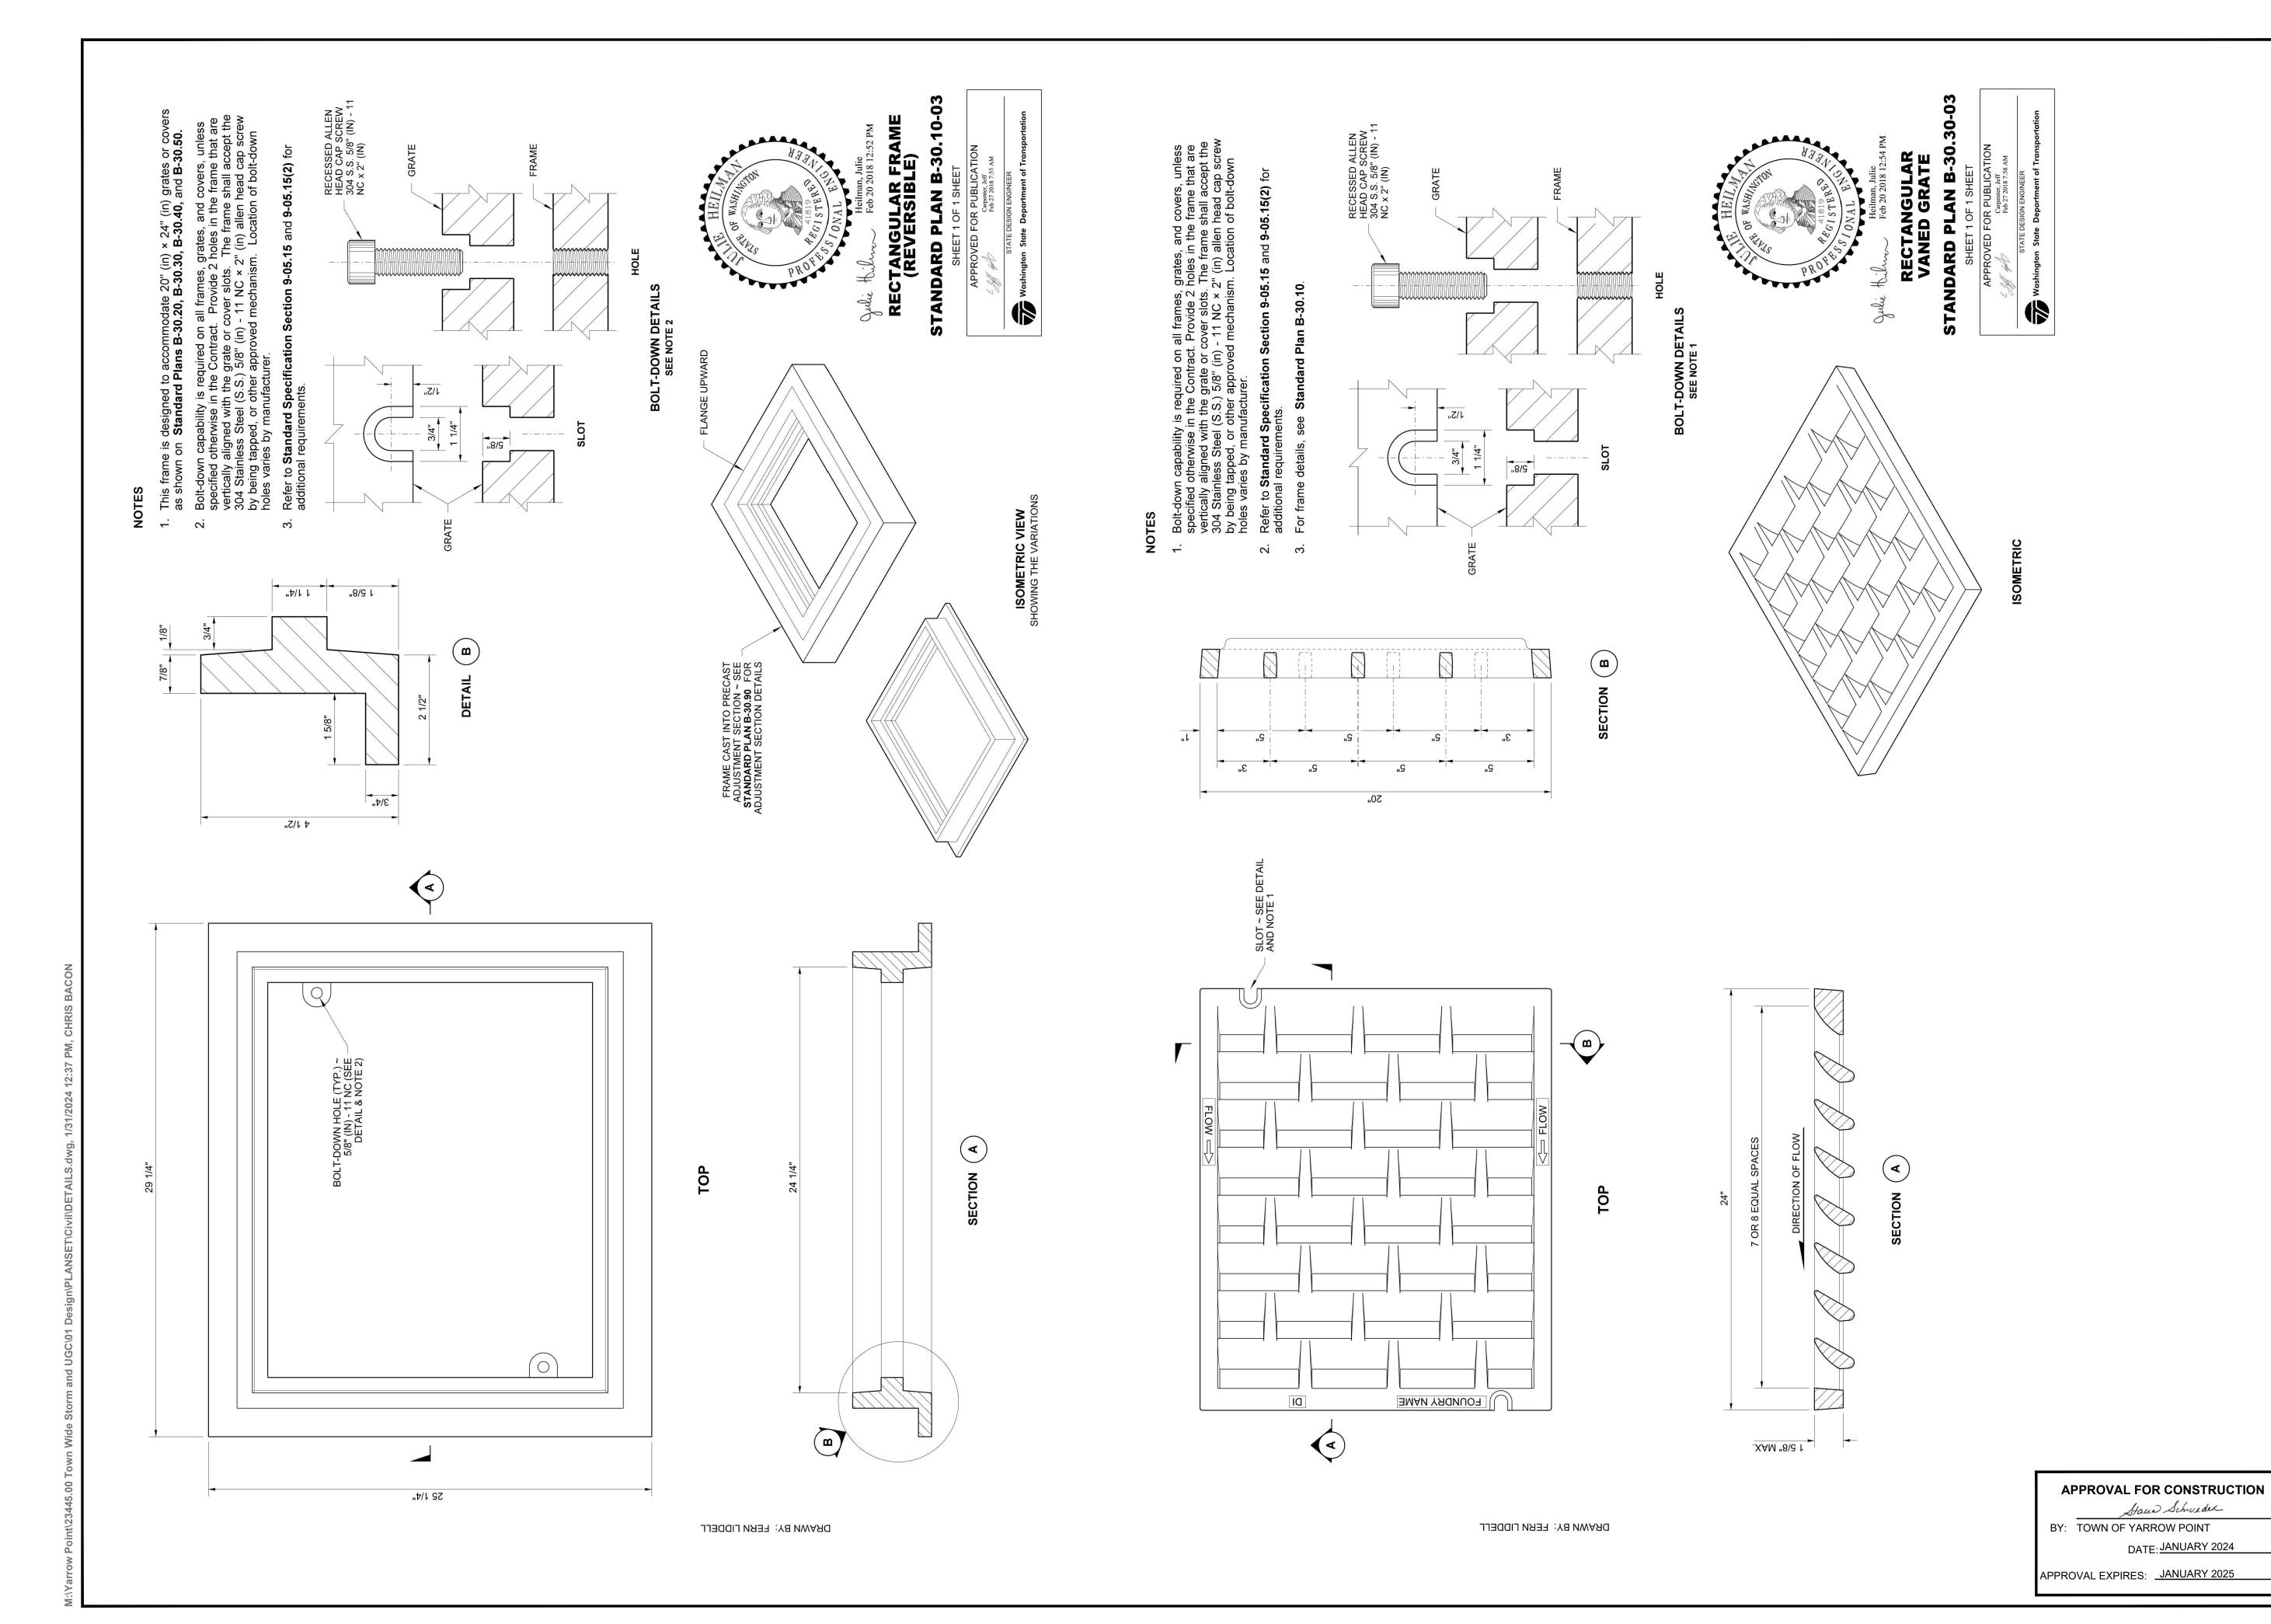



6 Gray & Osborne, Inc.

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**TOWN OF** YARROW POINT

**TOWN WIDE** STORMWATER AND **UGC PROJECT** 

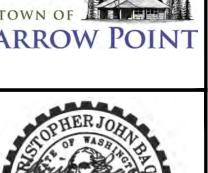No. DATE REVISION ISSUED FOR:

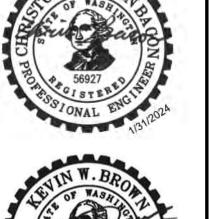
		BID PLAN SET
SSUE DATE:		JAN 2024
APPROVED BY:		KWB
CHECKED BY:		KWB
DRAWN BY:		CJB
DESIGNER:		CJB
G & O JOB NO.:		23445
FILE:		DETAILS.DWG
•	411	0"

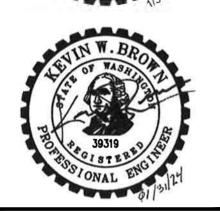TWO INCHES AT FULL SCALE IF NOT, SCALE ACCORDINGLY

CIVIL

STORM DETAILS

DRAWING: 16 OF: 40

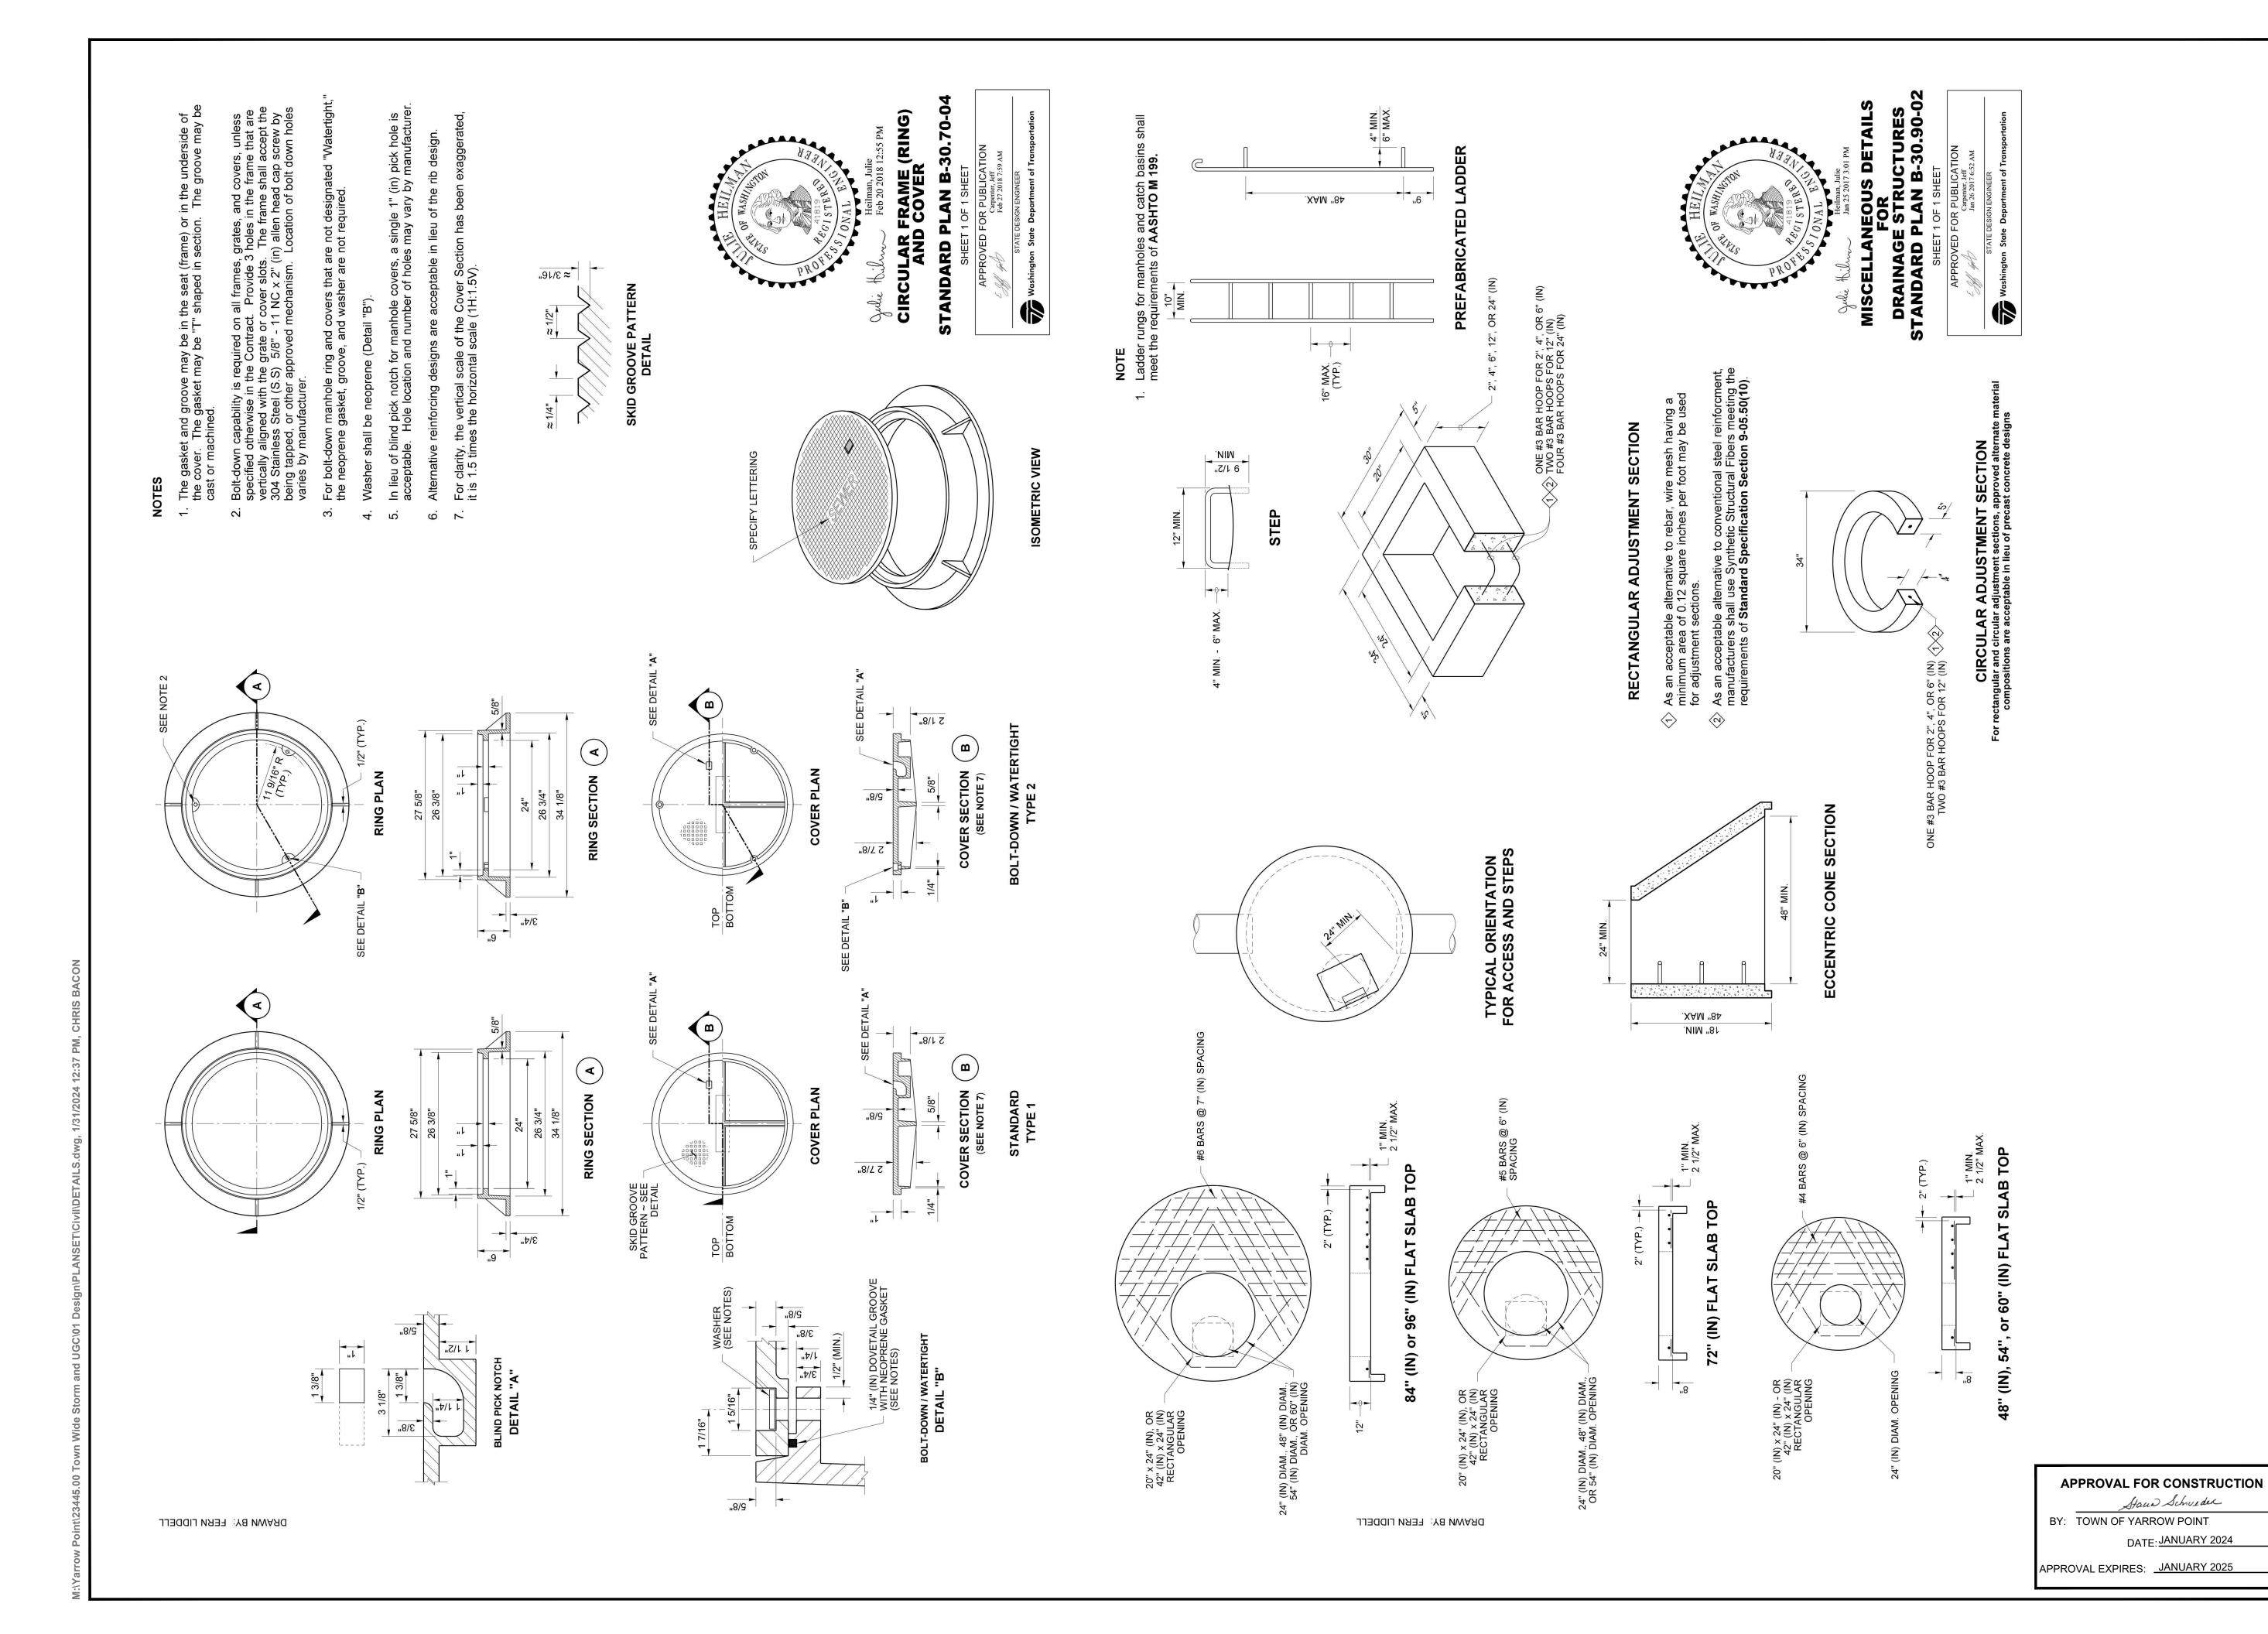



3710 168TH STREET NORTHEAST, BUILDING B, SUITE 210 ARLINGTON, WA 98223 (360) 454-5490



**TOWN OF** 

YARROW POINT

TOWN WIDE STORMWATER AND

**UGC PROJECT** 

No. DATE

ISSUED FOR:

ISSUE DATE:

DRAWN BY:

DESIGNER:

G & O JOB NO.:

APPROVED BY: CHECKED BY:

REVISION

**BID PLAN SET** 


JAN 2024

KWB CJB

CJB

23445

**DETAILS.DWG** 

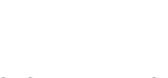

TWO INCHES AT FULL SCALE. IF NOT, SCALE ACCORDINGLY

CIVIL

STORM DETAILS

DRAWING: **17** OF: **40** 

- ☐ PSE HANDHOLE, CONCRETE 30x30
- PSE VAULT, 507 TUT
- PSE HANDHOLE, CONCRETE 32X44
- PSE PSE VAULT, 575 J-BOX
- □ COMCAST HANDHOLE, 11x18

**3800 92ND AVE NE** 

PRIVATE CONVERSION

3 10" BIRCH

L-3800

101+00

C-HH-1

- LUMEN HANDHOLE, 1730
- LM LUMEN VAULT, 3660

C-HH2

P-HH31

PARK/NG

P- IP7/J02 - 3

P- HH31/V07 -3

C- HH2/HH3 -4

L-3800/9220 -4

P-IP7

9207 NE 38TH ST

EXISTING SERVICE TRANSFER

CONC. LANDSCAPE TERRACE/WALL

CONDUIT SIZE (IN INCHES) -UTILITY SYMBOL KEY

END STRUCTURE NAME

UTILITY SYMBOL -

START STRUCTURE NAME

9218 NE 38TH ST

EXISTING SERVICE TRANSFER

**NE 38TH STREET** 

9222 NE 37TH PL

(UTILITY SERVICE FROM

NE 37TH STREET)

PSE INTOLIGHT HANDHOLES ARE THE SAME STRUCTURE AS PSE HANDHOLES, BUT LABELED DIFFERENTLY ON THE UTILITY'S PLANS (SEE SHEETS PSE 1 & PSE INTOLIGHT 1).

L-9220

C-HH3

P-HH32

P-IP7/J02 -3

P-HH31/V07-3

P-HH32/V07-3

C-HH3/HH4-2

C-HH3/V1-4

L-9220/9399-4

9228 NE 37TH PL

(UTILITY SERVICE FROM

NE 37TH STREET)

S' WOOD ON 6" CONC FOOTING **3805 94TH AVE NE** 

PRIVATE CONVERSION

C-HH4B

L-9390

P-HH33

(NO ADDRESS)

EXISTING SERVICE TRANSFER

6' WOOD ON 6"

P: PSE C: COMCAST L: LUMEN PI: PSE INTOLIGHT

**CONDUIT NAMING CONVENTION DETAIL** 

C-HH3/V1-4

#### **GENERAL NOTES**

- 1. EXISTING OVERHEAD AND UNDERGROUND UTILITIES SHALL REMAIN IN USE UNTIL THE NEW UNDERGROUND SYSTEM IS COMPLETED AND ACCEPTED BY THE UTILITY
- 2. CONTRACTOR SHALL BE AVAILABLE, AS NEEDED, TO ASSIST EACH UTILITY PULL WIRE, MAKE TRANSFERS / CONVERSIONS, ETC. WHENEVER THE UTILITY IS ON SITE OR AS COORDINATED WITH EACH UTILITY. CONTRACTOR TO COORDINATE.
- WHEN ENCOUNTERED, EXIST. IRRIGATION SHALL BE CUT BACK AS NEEDED. PRIOR TO BACKFILLING, CUT IRRIGATION ENDS SHALL BE BROUGHT TO THE SURFACE AND CAPPED. CONTRACTOR TO COORDINATE MODIFICATIONS WITH CONTACTING AGENCY.
- 4. CONTRACTOR SHALL EXCAVATE AND INSTALL UTILITY-FURNISHED STRUCTURE, MAKE CONDUIT CONNECTIONS, AND BACKFILL PER PSE PLANS & DETAIL SHEET 27.

P-V07


C-HH4

L-9399

C- HH4/HH4B -2

L-9399/9390-2

P-V07/HH33 -3

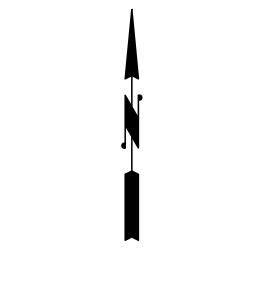




**CONSTRUCTION NOTES** 

- 1. CAUTION: POTENTIAL UTILITY CONFLICT. VERIFY POTHOLE) EXACT LOCATION AND DEPTH OF EXISTING UTILITY. SEE ORDER OF WORK.
- 2. PROTECT EXISTING DRIVEWAY, RETAINING WALL, WATER METER, SURVEY MONUMENT, MAILBOX SUPPORT, FENCE, TREE AND UNDERGROUND UTILITY DURING CONSTRUCTION.
- 3. REMOVE AND WASTEHAUL EXIST. AC PIPE AS NEEDED. PLUG ENDS WITH COMMERCIAL CONC.
- 4. EXIST. POLE AND APPURTENANCES WILL BE REMOVED BY LUMEN. CONTRACTOR TO COORDINATE.
- 5. INSTALL CONDUIT TO ±2' OF STRUCTURE LOCATION AND EXCAVATE REMAINING DISTANCE. STRUCTURE / CONNECTION WILL BE MADE BY OTHERS. COORDINATE WITH THE UTILITY.

INSTALL STREET LIGHT TUBE PER DETAIL,

- SHEET PSE INTOLIGHT 1. LIGHT POLE TO BE INSTALLED BY OTHERS.
- SEE EXISTING SERVICE TRANSFER DETAIL, SHEET 27.
  - SEE PRIVATE CONVERSION DETAIL, SHEET 27.
  - 9. CLEAR AND GRUB EXIST. TREE AND STUMP.

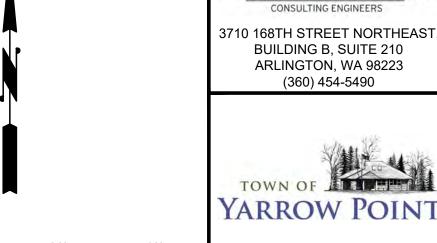



6

Gray & Osborne, Inc.



**TOWN OF** YARROW POINT

**TOWN WIDE STORMWATER AND UGC PROJECT** 

No.	DATE	REVISION
SSUE	D FOR:	
		BID PLAN SET

1990ED FOK:	
	BID PLAN SET
ISSUE DATE:	JAN 2024
APPROVED BY:	KWB
CHECKED BY:	KWB
DRAWN BY:	CJB
DESIGNER:	CJB
G & O JOB NO.:	23445
FILE:	UGC PLAN.DWG

TWO INCHES AT FULL SCALE IF NOT, SCALE ACCORDINGLY

CIVIL

JOINT UTILITY TRENCH

**PLAN** 

**BURIED UTILITIES IN AREA CALL BEFORE YOU DIG** 1-800-424-5555

EXISTING UTILITIES SHOWN ARE FROM THE BEST AVAILABLE INFORMATION AND NO GUARANTEE IS MADE AS TO THE EXACT SIZE, TYPE, LOCATION OR DEPTH

APPROVAL FOR CONSTRUCTION Stand Schweder

BY: TOWN OF YARROW POINT

DATE: JANUARY 2024

DRAWING: 18 OF: 40

## RIGHT-OF-WAY DISCLAIMER

PROPERTY LINES SHOWN HEREON ARE BASED ON AVAILABLE INFORMATION, NOT ON A SURVEYED LOCATION AND ARE ONLY APPROXIMATE.

Z

VENUE

2N

100+00

THE RIGHT-OF-WAY AND/OR

P-V07/HH34-3

P-V07/J02-3

P- IP7/J02 -3

C-HH3/V1-4

L-9399/3802-4

L-9399/3798-4

9240 NE 37TH PL

(UTILITY SERVICE FROM

NE 37TH STREET)

APPROVAL EXPIRES: JANUARY 2025

- ☐ PSE HANDHOLE, CONCRETE 30x30
- PSE VAULT, 507 TUT
- PSE HANDHOLE, CONCRETE 32X44
- PSE PSE VAULT, 575 J-BOX □ COMCAST HANDHOLE, 11x18
  - LUMEN HANDHOLE, 1730

NE 38TH STREET - SEE SHEET 18

P-V07/HH35 -3

P-V07/HH34 -3

P-V07/J02 -3

C-HH3/V1-4

L-9399/3802-4

L-9399/3798-4

PI-SL6

9240 NE 37TH PL

(UTILITY SERVICE FROM NE 37TH STREET

**3798 94TH AVE NE** 

C-HH3 / V1 -4

C- V1 / HH5 -4

C-V1 / V2 -4

**EXISTING SERVICE TRANSFER** 

PI-HH6/SL6 -2 P-V07/HH34 -3

P-J02 / IP8 -3 C-V1/HH5 -4 L-9399/3798 -4

L-3798

P-IP8

P-HH34 / PI-HH6

C-HH5

P-IP7/J02 -3

LM LUMEN VAULT, 3660

**3805 94TH AVE NE** 

PRIVATE CONVERSION

P-IP7/J02 -3

P- V07 / J02 -3

P- J02 / IP8 -3

C- V1 / V2 -4

**APPROX** 

L-3802

- REMOVE, PROTECT,

AND REINSTALL EXIST. LANDSCAPE ROCKS

C-V1

**LOCATION OF** 

**FUTURE DWY.** 

BY OTHERS

P-IP7/J02 -3

P-V07 / J02 -3

P-IP8 / J02 -3

C-V1 / V2 -4

L-3802/3817-4

**3802 94TH AVE NE** 

(NO ACTIVE UTILITY SERVICE)

BLOWUP SCALE: 1"=5"

P-J02

## **CONDUIT NAMING CONVENTION DETAIL** C-HH3/V1-4 UTILITY SYMBOL -START STRUCTURE NAME END STRUCTURE NAME CONDUIT SIZE (IN INCHES) -UTILITY SYMBOL KEY P: PSE C: COMCAST L: LUMEN PI: PSE INTOLIGHT

**3813 94TH AVE NE** 

PRIVATE CONVERSION

94TH AVENE

3812 94TH AVE NE

EXISTING SERVICE TRANSFER

P- J02 / V06 -3

C- V1 / V2 -4

L-3802/3817-4

REMAINS OF

CONC. STEPS

PI-HH5/SL5 -2

P-HH29 / V06 -3

P-J02 / V06 -3

C-V1 / V2 -4

C-V2 / HH6 -4

L-3845/3834 -4

L-3845/3822 -2

PSE INTOLIGHT HANDHOLES ARE THE SAME STRUCTURE AS PSE HANDHOLES, BUT LABELED DIFFERENTLY ON THE UTILITY'S PLANS (SEE SHEETS PSE 1 & PSE INTOLIGHT 1).

**3823 94TH AVE NE** 

PI-HH5/SL5 -2

P- HH29 / V06 -3

P- J02 / V06 -3

C- V2 / HH7 -4 L- 3845/3834 -4

C-V2

P-HH30

L-3822

**3824 94TH AVE NE** 

EXISTING SERVICE TRANSFER

WOOD MAILBO

**EN¢LOSURE** 

PI-SL5

LANDSCAPE

LAWN

EXISTING SERVICE TRANSFER


L-3845

C-HH6

P-HH29 / PI-HH5


#### **GENERAL NOTES**


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#### JOINT UTILITY TRENCH **CONSTRUCTION NOTES**

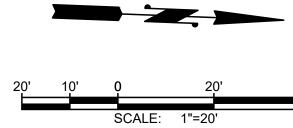
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- 6. INSTALL STREET LIGHT TUBE PER DETAIL, SHEET PSE INTOLIGHT 1. LIGHT POLE TO BE INSTALLED BY OTHERS.
- 7. SEE EXISTING SERVICE TRANSFER DETAIL, SHEET 27.
- 8. SEE PRIVATE CONVERSION DETAIL, SHEET 27.
- 9. CLEAR AND GRUB EXIST. TREE AND STUMP.



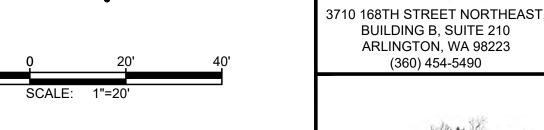

6

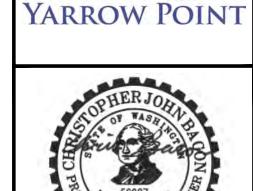Gray & Osborne, Inc.

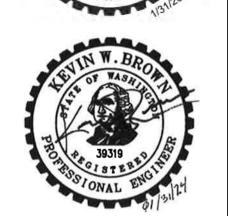

#### **TOWN OF** YARROW POINT

**TOWN WIDE STORMWATER AND UGC PROJECT** 

No.	DATE	REVISION
SSUE	D FOR:	
		BID PLAN SET
SSUE	DATE:	JAN 2024
PPROVED BY:		KWB

TWO INCHES AT FULL SCALE IF NOT, SCALE ACCORDINGLY

KWB

CJB CJB

23445

UGC PLAN.DWG

CHECKED BY:

DRAWN BY:

DESIGNER:

G & O JOB NO.:

CIVIL

#### **BURIED UTILITIES IN AREA** CALL BEFORE YOU DIG 1-800-424-5555

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BY: TOWN OF YARROW POINT

DATE: JANUARY 2024

APPROVAL EXPIRES: <u>JANUARY 2025</u>

#### RIGHT-OF-WAY DISCLAIMER

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APPROVAL FOR CONSTRUCTION


Stand Schweder

DRAWING: 19 OF: 40

**JOINT UTILITY TRENCH** 

PLAN



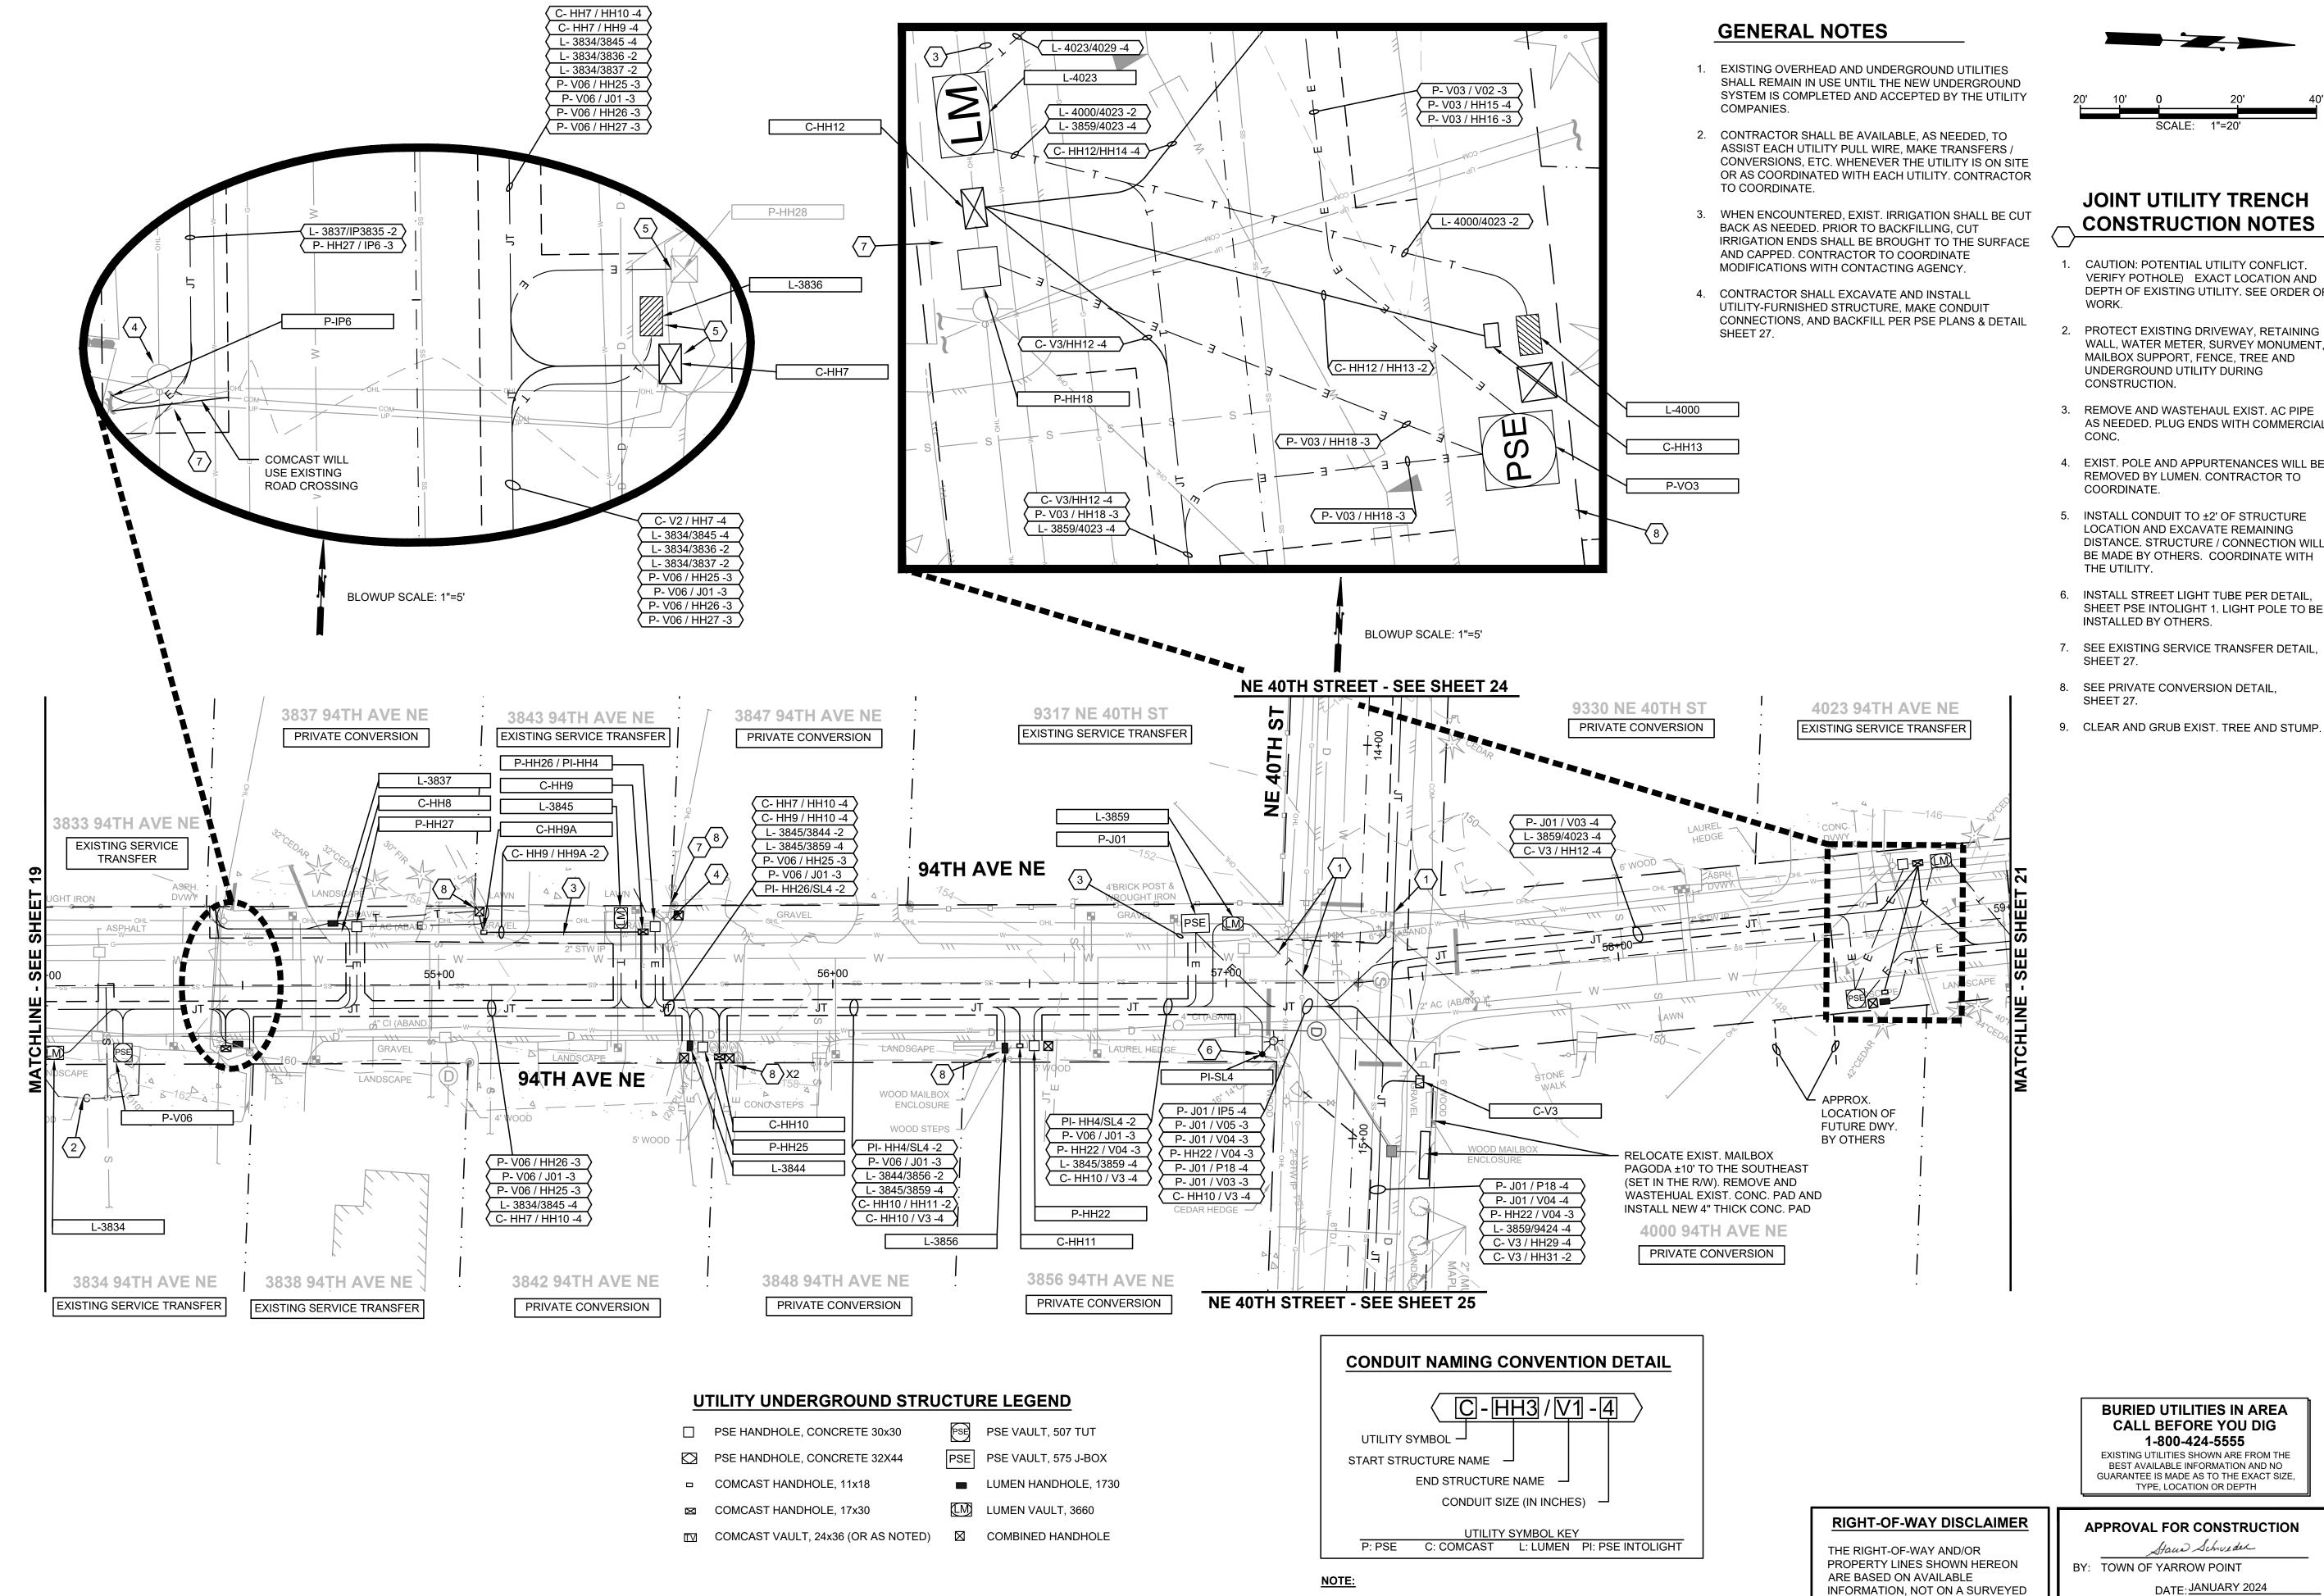

Gray & Osborne, Inc.

> 3710 168TH STREET NORTHEAST BUILDING B, SUITE 210 ARLINGTON, WA 98223 (360) 454-5490



1. CAUTION: POTENTIAL UTILITY CONFLICT. VERIFY POTHOLE) EXACT LOCATION AND DEPTH OF EXISTING UTILITY. SEE ORDER OF

- 2. PROTECT EXISTING DRIVEWAY, RETAINING WALL, WATER METER, SURVEY MONUMENT MAILBOX SUPPORT, FENCE, TREE AND UNDERGROUND UTILITY DURING
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- REMOVED BY LUMEN. CONTRACTOR TO
- LOCATION AND EXCAVATE REMAINING DISTANCE. STRUCTURE / CONNECTION WILL BE MADE BY OTHERS. COORDINATE WITH
- SHEET PSE INTOLIGHT 1. LIGHT POLE TO BE
- 9. CLEAR AND GRUB EXIST. TREE AND STUMP.







**TOWN OF** YARROW POINT

**TOWN WIDE STORMWATER AND UGC PROJECT** 

No.	DATE	REVISION
ISSUE	D FOR:	
		BID PLAN SET

BID PLAN SET ISSUE DATE: JAN 2024 APPROVED BY:

CHECKED BY: KWB DRAWN BY: CJB CJB DESIGNER: G & O JOB NO.: 23445 UGC PLAN.DWG

TWO INCHES AT FULL SCALE IF NOT, SCALE ACCORDINGLY

CIVIL

**JOINT UTILITY TRENCH** 

PLAN

DRAWING: 20 OF: 40

PSE INTOLIGHT HANDHOLES ARE THE SAME STRUCTURE AS PSE HANDHOLES, BUT LABELED DIFFERENTLY ON THE UTILITY'S PLANS (SEE SHEETS PSE 1 & PSE INTOLIGHT 1).

LOCATION AND ARE ONLY APPROXIMATE.

APPROVAL EXPIRES: <u>JANUARY 2025</u>

- ☐ PSE HANDHOLE, CONCRETE 30x30
- PSE VAULT, 507 TUT
- PSE HANDHOLE, CONCRETE 32X44
- PSE PSE VAULT, 575 J-BOX □ COMCAST HANDHOLE, 11x18
- □ COMCAST HANDHOLE, 17x30
- LUMEN HANDHOLE, 1730

**4025 94TH AVE NE** 

EXISTING SERVICE TRANSFER

P- V03 / HH16 -3

P- V03 / HH15 -4

P- V03 / V02 -3

L- 4023/4029 -4 C- HH12 / HH14 -4

**4020 94TH AVE NE** 

EXISTING SERVICE TRANSFER

- LUMEN VAULT, 3660

## **CONDUIT NAMING CONVENTION DETAIL** C-HH3/V1-4 UTILITY SYMBOL -START STRUCTURE NAME END STRUCTURE NAME CONDUIT SIZE (IN INCHES) -UTILITY SYMBOL KEY P: PSE C: COMCAST L: LUMEN PI: PSE INTOLIGHT

**4031 94TH AVE NE** 

L-4029

C-HH14

P-HH16

8 (INCLUDES ROAD CROSSING)

**4024 94TH AVE NE** 

PRIVATE CONVERSION

P-IP4

EXISTING SERVICE TRANSFER

**794TH AVENUE NE** 

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**4205 94TH AVE NE** 

CONC. - PAVER

WALK

62+00

P-HH15

C-V4

L-4205

4208 94TH AVE NE

EXISTING SERVICE TRANSFER

EXISTING SERVICE TRANSFER

P- V03 / HH15 -4

P- V03 / V02 -3


L- 4029/4220 -4 C- HH14 / V4 -4


**4200 94TH AVE NE** 

EXISTING SERVICE TRANSFER

#### **GENERAL NOTES**

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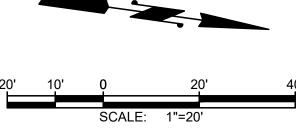


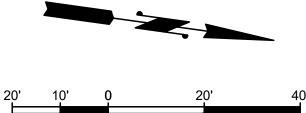
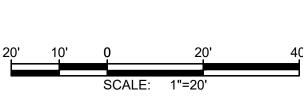
#### JOINT UTILITY TRENCH **CONSTRUCTION NOTES**

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- 8. SEE PRIVATE CONVERSION DETAIL, SHEET 27.
- 9. CLEAR AND GRUB EXIST. TREE AND STUMP.





6

Gray & Osborne, Inc.

3710 168TH STREET NORTHEAST

BUILDING B, SUITE 210

ARLINGTON, WA 98223

(360) 454-5490





**TOWN OF** YARROW POINT

**TOWN WIDE** STORMWATER AND **UGC PROJECT** 

No.	DATE	REVISION
ISSUE	D FOR:	
		BID PLAN SET

	BID PLAN SET
ISSUE DATE:	JAN 2024
APPROVED BY:	KWB
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TWO INCHES AT FULL SCALE IF NOT, SCALE ACCORDINGLY

CIVIL

JOINT UTILITY TRENCH

**PLAN** 

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Stand Schweder BY: TOWN OF YARROW POINT

DATE: JANUARY 2024

APPROVAL EXPIRES: JANUARY 2025

#### RIGHT-OF-WAY DISCLAIMER

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**APPROVAL FOR CONSTRUCTION** 

DRAWING: **21** OF: **40** 

CONC.

- PAVER WALK

- ☐ PSE HANDHOLE, CONCRETE 30x30
- PSE VAULT, 507 TUT PSE PSE VAULT, 575 J-BOX PSE HANDHOLE, CONCRETE 32X44
- □ COMCAST HANDHOLE, 11x18

**4225 94TH AVE NE** 

EXISTING SERVICE TRANSFER

LANDSCAPE

C- HH17 / HH20 -4

L- 4220/4402 -4

L- 4220/4230 -2

P- V03 / V02 -3

L-4220

C-HH17

P-HH13

**4222 94TH AVE NE** 

EXISTING SERVICE TRANSFER

P- HH12 / V02 -3

**4215 94TH AVE NE** EXISTING SERVICE TRANSFER

P-HH12 / PI-HH3

C-HH16

L-4219

P- V03 / V02 -3

L- 4029/4220 -4

L- 4205/4220 -2

C- V4 / HH17 -4

**4218 94TH AVE NE** 

EXISTING SERVICE TRANSFER

PI-SL3

WOOD MATER

ENCLOSU

LANDSC

P- V03 / V02 -3

P- HH12 / V02 -3

P- HH12 / HH13 -3

L- 4029/4220 -4

L- 4205/4220 -2

L- 4219/4220 -2

C- V4 / HH17 -4

C- HH16 / HH17 -2

- LUMEN HANDHOLE, 1730
- LUMEN VAULT, 3660

**4233 94TH AVE NE** 

P-HH9

C-HH19

L-4237

**EXISTING SERVICE TRANSFER** 

P- V03 / V02 -3

P- HH12 / V02 -3

P- HH11 / V02 -3

L- 4220/4402 -4

C- HH17 / HH20 -4

C- HH18 / HH20 -2

**▲4236 94TH AVE NE** 

EXISTING SERVICE TRANSFER

/ PRIVATE CONVERSION

## **CONDUIT NAMING CONVENTION DETAIL** C-HH3/V1-4 UTILITY SYMBOL -START STRUCTURE NAME END STRUCTURE NAME CONDUIT SIZE (IN INCHES) UTILITY SYMBOL KEY P: PSE C: COMCAST L: LUMEN PI: PSE INTOLIGHT

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4405 94TH AVE NE

EXISTING SERVICE TRANSFER

EXISTING SERVICE TRANSFER

EXISTING SERVICE TRANSFER

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## JOINT UTILITY TRENCH

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- 7. SEE EXISTING SERVICE TRANSFER DETAIL, SHEET 27.
- 8. SEE PRIVATE CONVERSION DETAIL, SHEET 27.


4425 94TH AVE NE

EXISTING SERVICE TRANSFER

9. CLEAR AND GRUB EXIST. TREE AND STUMP.





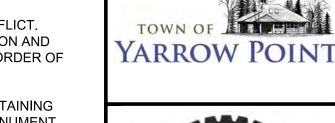

Gray & Osborne, Inc.

3710 168TH STREET NORTHEAST

BUILDING B, SUITE 210

ARLINGTON, WA 98223

(360) 454-5490





TOWN OF YARROW POINT

TOWN WIDE STORMWATER AND **UGC PROJECT** 

REVISION No. DATE ISSUED FOR:

**BID PLAN SET** ISSUE DATE: JAN 2024 APPROVED BY: KWB CHECKED BY: KWB

DRAWN BY: CJB CJB DESIGNER: G & O JOB NO.: 23445 UGC PLAN.DWG

TWO INCHES AT FULL SCALE IF NOT, SCALE ACCORDINGLY

CIVIL

JOINT UTILITY TRENCH PLAN

DRAWING: **22** OF: **40** 

RIGHT-OF-WAY DISCLAIMER

EXISTING SERVICE TRANSFER

THE RIGHT-OF-WAY AND/OR PROPERTY LINES SHOWN HEREON ARE BASED ON AVAILABLE INFORMATION, NOT ON A SURVEYED LOCATION AND ARE ONLY APPROXIMATE.

**APPROVAL FOR CONSTRUCTION** Stand Schweder BY: TOWN OF YARROW POINT DATE: JANUARY 2024

EXISTING SERVICE TRANSFER

APPROVAL EXPIRES: <u>JANUARY 2025</u>

**BURIED UTILITIES IN AREA CALL BEFORE YOU DIG** 1-800-424-5555 EXISTING UTILITIES SHOWN ARE FROM THE BEST AVAILABLE INFORMATION AND NO GUARANTEE IS MADE AS TO THE EXACT SIZE TYPE, LOCATION OR DEPTH

P-HH11

C-HH18

L-4230

**4230 94TH AVE NE** 

PRIVATE CONVERSION

L-4425 C-HH21 C-HH22 P- V02 / V01 -3 P- V02 / HH6 -3 P-HH6 L- 4402/4425 -2 L- 4402/4438 -4 C- HH20 / V5 -4 94TH AVENUE NE C- HH21 / V5 -2 \68+00 ASPHALT  $\langle 7 \rangle_{X2}$ P- V03 / V02 -3 **BRICK WALK** P- HH12 / V02 -3 C-V5 P-HH7 P- V02 / V01 -3 L-4402 P- HH11 / V02 -3 P- V02 / HH6 -3 L-4410 P- V02 / V01 -3 P- HH9 / V02 -3 L-4416 P-V02 P- V02 / HH6 -3 P- V02 / HH8 -3 L- 4237/4402 -2 P-HH8 C-HH20 L- 4402/4410 -2 L- 4402/4425 -2 P- V02 / V01 -3 L- 4220/4402 -4 C- HH17 / HH20 -4 L- 4402/4425 -2 L- 4402/4438 -4 P- HH6 / HH7 -3 (COMCAST AND L- 4402/4438 -4 L- 4402/4438 -4 C- V5 / HH22 -4  $\binom{8}{2}$  LUMEN ONLY) C- HH18 / HH20 -2 L- 4425/4416 -2 C- HH19 / HH20 -4 C- HH20 / V5 -4 C- V5 / HH23 -4 C- V5 / HH23 -4 4416 94TH AVE NE 4424 94TH AVE NE 4408 94TH AVE NE 4412 94TH AVE NE 4402 94TH AVE NE

EXISTING SERVICE TRANSFER

4415 94TH AVE NE

(NO ACTIVE SERVICES)

PSE VAULT, 507 TUT

- ☐ PSE HANDHOLE, CONCRETE 30x30
- PSE PSE VAULT, 575 J-BOX PSE HANDHOLE, CONCRETE 32X44

4439 94TH AVE NE

PRIVATE CONVERSION

4433 94TH AVE NE

**EXISTING SERVICE TRANSFER** 

4437 94TH AVE NE

EXISTING SERVICE TRANSFER

- □ COMCAST HANDHOLE, 11x18 LUMEN HANDHOLE, 1730
- LM LUMEN VAULT, 3660

## **CONDUIT NAMING CONVENTION DETAIL** C-HH3/V1-4 UTILITY SYMBOL -START STRUCTURE NAME END STRUCTURE NAME CONDUIT SIZE (IN INCHES) -UTILITY SYMBOL KEY P: PSE C: COMCAST L: LUMEN PI: PSE INTOLIGHT

PSE INTOLIGHT HANDHOLES ARE THE SAME STRUCTURE AS PSE HANDHOLES, BUT LABELED DIFFERENTLY ON THE UTILITY'S PLANS (SEE SHEETS PSE 1 & PSE INTOLIGHT 1).

#### **GENERAL NOTES**

- 1. EXISTING OVERHEAD AND UNDERGROUND UTILITIES SHALL REMAIN IN USE UNTIL THE NEW UNDERGROUND SYSTEM IS COMPLETED AND ACCEPTED BY THE UTILITY COMPANIES.
- 2. CONTRACTOR SHALL BE AVAILABLE, AS NEEDED, TO ASSIST EACH UTILITY PULL WIRE, MAKE TRANSFERS / CONVERSIONS, ETC. WHENEVER THE UTILITY IS ON SITE OR AS COORDINATED WITH EACH UTILITY. CONTRACTOR TO COORDINATE.
- 3. WHEN ENCOUNTERED, EXIST. IRRIGATION SHALL BE CUT BACK AS NEEDED. PRIOR TO BACKFILLING, CUT IRRIGATION ENDS SHALL BE BROUGHT TO THE SURFACE AND CAPPED. CONTRACTOR TO COORDINATE MODIFICATIONS WITH CONTACTING AGENCY.

APPROXIMATE.


4. CONTRACTOR SHALL EXCAVATE AND INSTALL UTILITY-FURNISHED STRUCTURE, MAKE CONDUIT CONNECTIONS, AND BACKFILL PER PSE PLANS & DETAIL SHEET 27.

### JOINT UTILITY TRENCH **CONSTRUCTION NOTES**

- CAUTION: POTENTIAL UTILITY CONFLICT. VERIFY POTHOLE) EXACT LOCATION AND DEPTH OF EXISTING UTILITY. SEE ORDER OF WORK.
- 2. PROTECT EXISTING DRIVEWAY, RETAINING WALL, WATER METER, SURVEY MONUMENT, MAILBOX SUPPORT, FENCE, TREE AND UNDERGROUND UTILITY DURING CONSTRUCTION.
- 3. REMOVE AND WASTEHAUL EXIST. AC PIPE AS NEEDED. PLUG ENDS WITH COMMERCIAL CONC.
- 4. EXIST. POLE AND APPURTENANCES WILL BE REMOVED BY LUMEN. CONTRACTOR TO COORDINATE.
- 5. INSTALL CONDUIT TO ±2' OF STRUCTURE LOCATION AND EXCAVATE REMAINING DISTANCE. STRUCTURE / CONNECTION WILL BE MADE BY OTHERS. COORDINATE WITH THE UTILITY.
- 6. INSTALL STREET LIGHT TUBE PER DETAIL, SHEET PSE INTOLIGHT 1. LIGHT POLE TO BE INSTALLED BY OTHERS.
- 7. SEE EXISTING SERVICE TRANSFER DETAIL, SHEET 27.
- 8. SEE PRIVATE CONVERSION DETAIL, SHEET 27.

APPROVAL EXPIRES: <u>JANUARY 2025</u>

9. CLEAR AND GRUB EXIST. TREE AND STUMP.

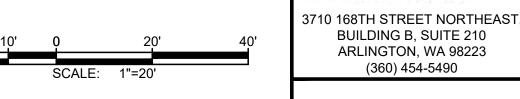



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Gray & Osborne, Inc.


CONSULTING ENGINEERS





**TOWN OF** YARROW POINT

**TOWN WIDE STORMWATER AND UGC PROJECT** 

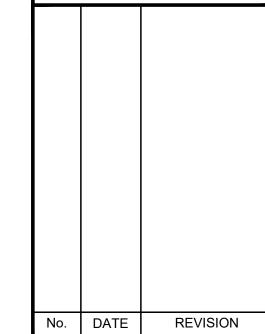

ISSUED FOR: **BID PLAN SET** 

ISSUE DATE: JAN 2024 APPROVED BY: KWB CHECKED BY: KWB DRAWN BY: CJB CJB DESIGNER: G & O JOB NO.: 23445


TWO INCHES AT FULL SCALE IF NOT, SCALE ACCORDINGLY

UGC PLAN.DWG

CIVIL

JOINT UTILITY TRENCH PLAN

DRAWING: **23** OF: **40** 

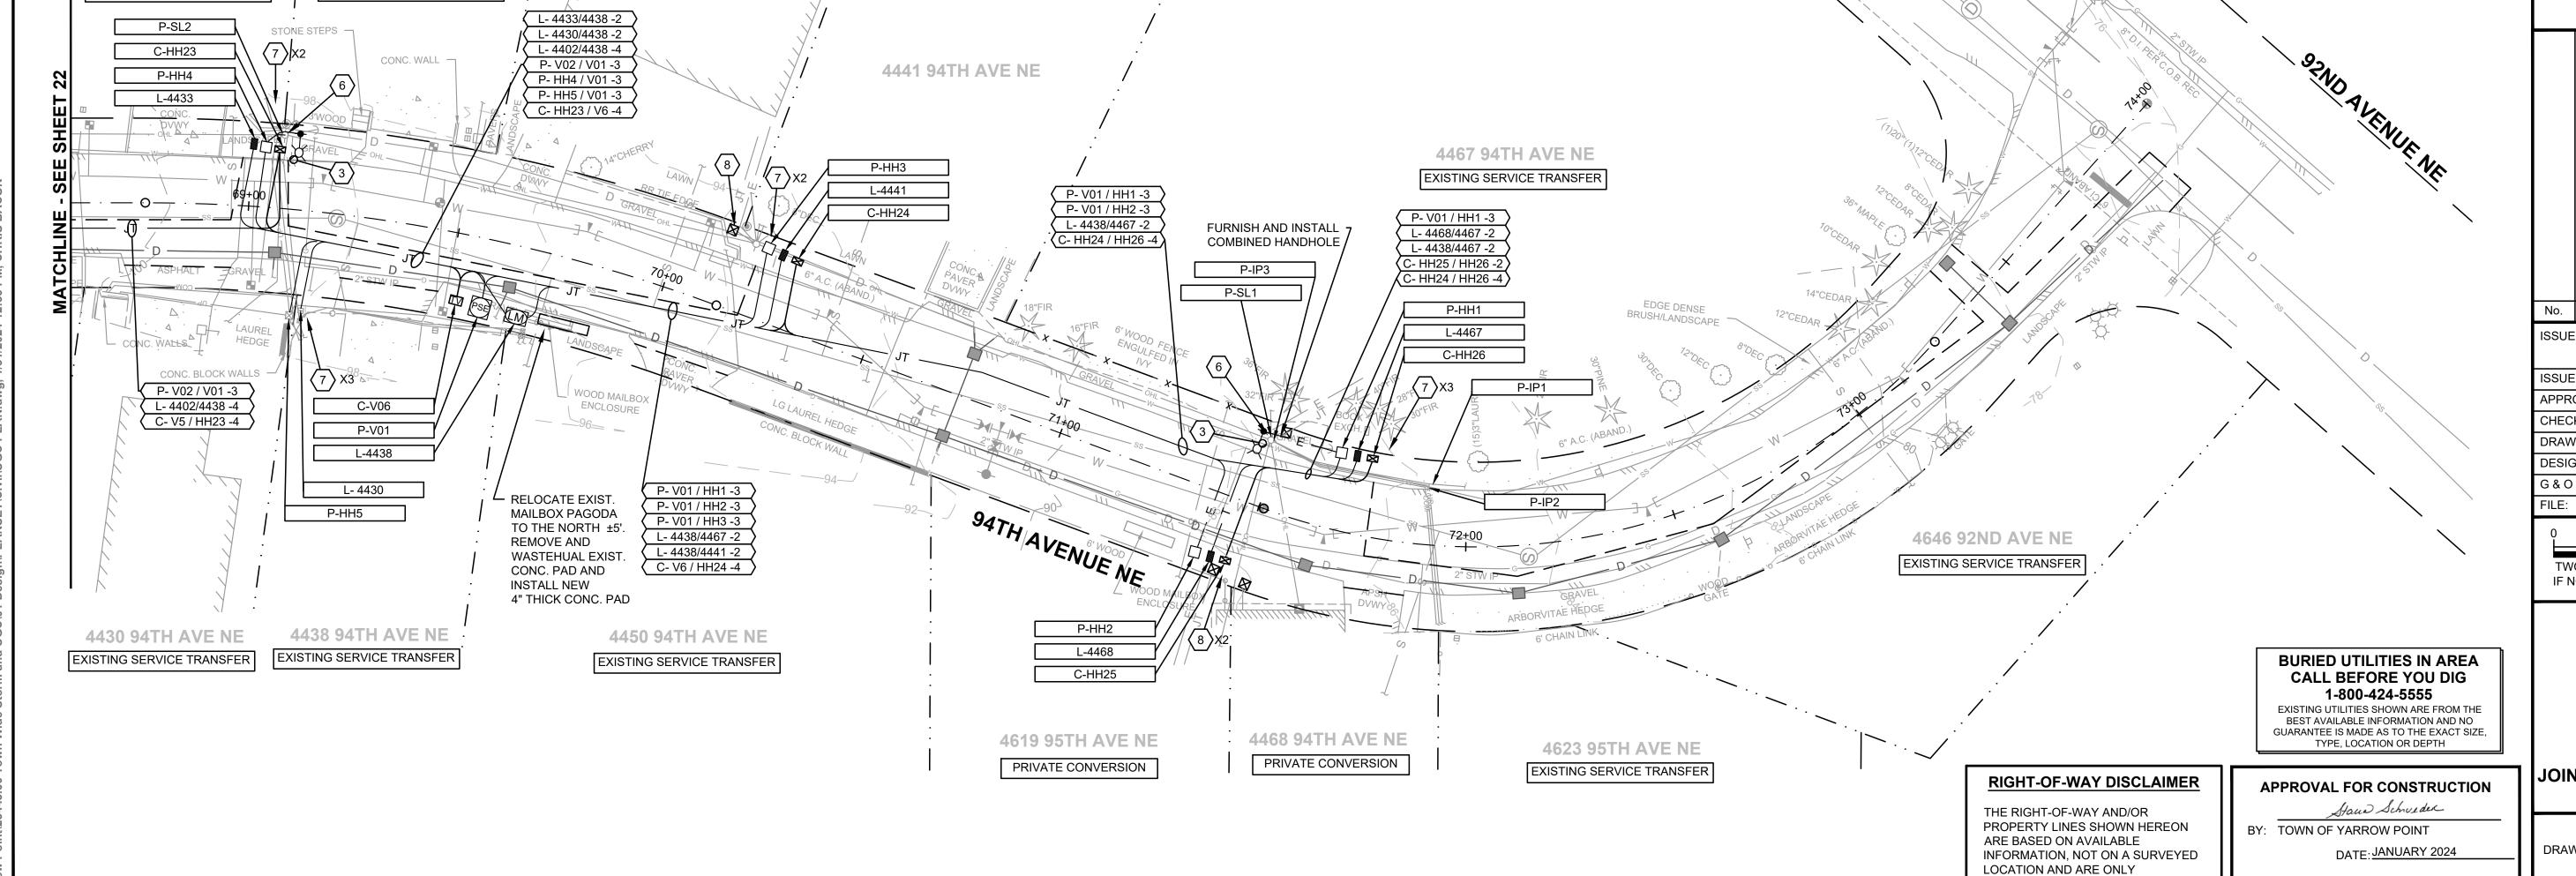

PSE VAULT, 507 TUT ☐ PSE HANDHOLE, CONCRETE 30x30

PSE PSE VAULT, 575 J-BOX PSE HANDHOLE, CONCRETE 32X44

□ COMCAST HANDHOLE, 11x18

LUMEN HANDHOLE, 1730

LUMEN VAULT, 3660 ™ COMCAST VAULT, 24x36 (OR AS NOTED) ☐ COMBINED HANDHOLE

UTILITY SYMBOL -START STRUCTURE NAME END STRUCTURE NAME -CONDUIT SIZE (IN INCHES) UTILITY SYMBOL KEY

**CONDUIT NAMING CONVENTION DETAIL** 

C-HH3/V1-4

P-IP5

9211 NE 40TH ST

EXISTING SERVICE TRANSFER

L-9229

P-HH21

C-V7

PSE INTOLIGHT HANDHOLES ARE THE SAME STRUCTURE AS PSE HANDHOLES, BUT LABELED DIFFERENTLY ON THE UTILITY'S PLANS (SEE SHEETS PSE 1 & PSE INTOLIGHT 1).

4000 92ND AVE NE

EXISTING SERVICE TRANSFER

P-V05

P- IP5 / J01 -4

P- HH21 / V05 -3

L- 9229/9306 -4

C- V7 / HH27 -4

TERRACE WALLS

9229 NE 40TH ST

EXISTING SERVICE TRANSFER

P- V05 / HH19 -3

P- V05 / HH20 -3 P- V05 / J01 -4

P- IP5 / J01 -4

L- 9229/9306 -4

C- V7 / HH27 -4

P: PSE C: COMCAST L: LUMEN PI: PSE INTOLIGHT

#### **GENERAL NOTES**

- 1. EXISTING OVERHEAD AND UNDERGROUND UTILITIES SHALL REMAIN IN USE UNTIL THE NEW UNDERGROUND SYSTEM IS COMPLETED AND ACCEPTED BY THE UTILITY COMPANIES.
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- 3. WHEN ENCOUNTERED, EXIST. IRRIGATION SHALL BE CUT BACK AS NEEDED. PRIOR TO BACKFILLING, CUT IRRIGATION ENDS SHALL BE BROUGHT TO THE SURFACE AND CAPPED. CONTRACTOR TO COORDINATE MODIFICATIONS WITH CONTACTING AGENCY.
- 4. CONTRACTOR SHALL EXCAVATE AND INSTALL UTILITY-FURNISHED STRUCTURE, MAKE CONDUIT CONNECTIONS, AND BACKFILL PER PSE PLANS & DETAIL SHEET 27.

9306 NE 40TH ST

PRIVATE CONVERSION

HEDGE

P- V05 / HH20 -3

L- 9306/9309 -2

C- HH27 / HH28 -2

(PSE

ONLY)

9309 NE 40TH ST

PRIVATE CONVERSION

P-HH19

C-HH27

L-9306

**NE 40TH STREET** 

P-HH20

C-HH28

L-9309

#### JOINT UTILITY TRENCH **CONSTRUCTION NOTES**

- 1. CAUTION: POTENTIAL UTILITY CONFLICT. VERIFY POTHOLE) EXACT LOCATION AND DEPTH OF EXISTING UTILITY. SEE ORDER OF WORK.
- 2. PROTECT EXISTING DRIVEWAY, RETAINING WALL, WATER METER, SURVEY MONUMENT, MAILBOX SUPPORT, FENCE, TREE AND UNDERGROUND UTILITY DURING CONSTRUCTION.
- 3. REMOVE AND WASTEHAUL EXIST. AC PIPE AS NEEDED. PLUG ENDS WITH COMMERCIAL
- 4. EXIST. POLE AND APPURTENANCES WILL BE REMOVED BY LUMEN. CONTRACTOR TO COORDINATE.
- 5. INSTALL CONDUIT TO ±2' OF STRUCTURE LOCATION AND EXCAVATE REMAINING DISTANCE. STRUCTURE / CONNECTION WILL BE MADE BY OTHERS. COORDINATE WITH THE UTILITY.
- 6. INSTALL STREET LIGHT TUBE PER DETAIL, SHEET PSE INTOLIGHT 1. LIGHT POLE TO BE INSTALLED BY OTHERS.
- 7. SEE EXISTING SERVICE TRANSFER DETAIL, SHEET 27.
- 8. SEE PRIVATE CONVERSION DETAIL, SHEET 27.

9330 NE 40TH ST

PRIVATE CONVERSION

P- V05 / J01 -3

P- IP5 / J01 -4

L- 9306/3859 -4

C- HH27 / V3 -4

4'BRICK POST & WROUGHT IRON

9317 NE 40TH ST

EXISTING SERVICE TRANSFER

/ PRIVATE CONVERSION

(COMCAST AND LUMEN ONLY)


9. CLEAR AND GRUB EXIST, TREE AND STUMP.


L-3859

P-J01

94TH AVENUE NE - SEE SHEET 20

94TH AVENUE NE - SEE SHEET 20

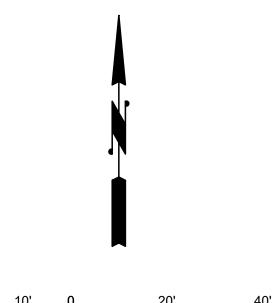


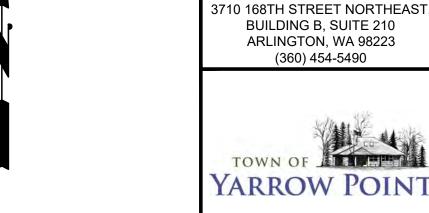




6

Gray & Osborne, Inc.

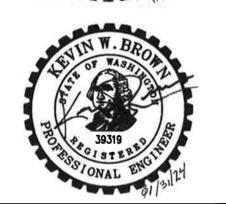

#### **TOWN OF** YARROW POINT

**TOWN WIDE** STORMWATER AND **UGC PROJECT** 

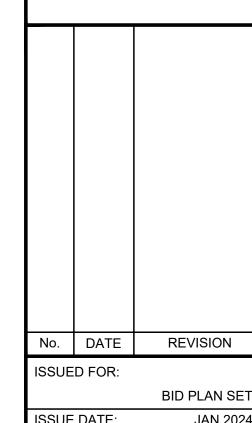

**BID PLAN SET** ISSUE DATE: JAN 2024 APPROVED BY: KWB CHECKED BY: KWB DRAWN BY: CJB CJB DESIGNER: G & O JOB NO.: 23445

UGC PLAN.DWG

TWO INCHES AT FULL SCALE IF NOT, SCALE ACCORDINGLY

CIVIL

JOINT UTILITY TRENCH

PLAN

**BURIED UTILITIES IN AREA CALL BEFORE YOU DIG** 1-800-424-5555

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C-V3

SEE SHEET 20

FOR ADDITIONAL

JUT INFORMATION

#### RIGHT-OF-WAY DISCLAIMER

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#### APPROVAL FOR CONSTRUCTION Stand Schweder

BY: TOWN OF YARROW POINT

DATE: JANUARY 2024

DRAWING: **24** OF: **40** 

APPROXIMATE.

APPROVAL EXPIRES: <u>JANUARY 2025</u>

- ☐ PSE HANDHOLE, CONCRETE 30x30
- PSE VAULT, 507 TUT PSE PSE VAULT, 575 J-BOX

LUMEN HANDHOLE, 1730

- PSE HANDHOLE, CONCRETE 32X44
- □ COMCAST HANDHOLE, 11x18
- LM LUMEN VAULT, 3660
  - UTILITY SYMBOL KEY

UTILITY SYMBOL -

START STRUCTURE NAME

PSE INTOLIGHT HANDHOLES ARE THE SAME STRUCTURE AS PSE HANDHOLES, BUT LABELED DIFFERENTLY ON THE UTILITY'S PLANS (SEE SHEETS PSE 1 & PSE INTOLIGHT 1).

END STRUCTURE NAME

**CONDUIT NAMING CONVENTION DETAIL** 


C-HH3/V1-4

CONDUIT SIZE (IN INCHES) -

P: PSE C: COMCAST L: LUMEN PI: PSE INTOLIGHT


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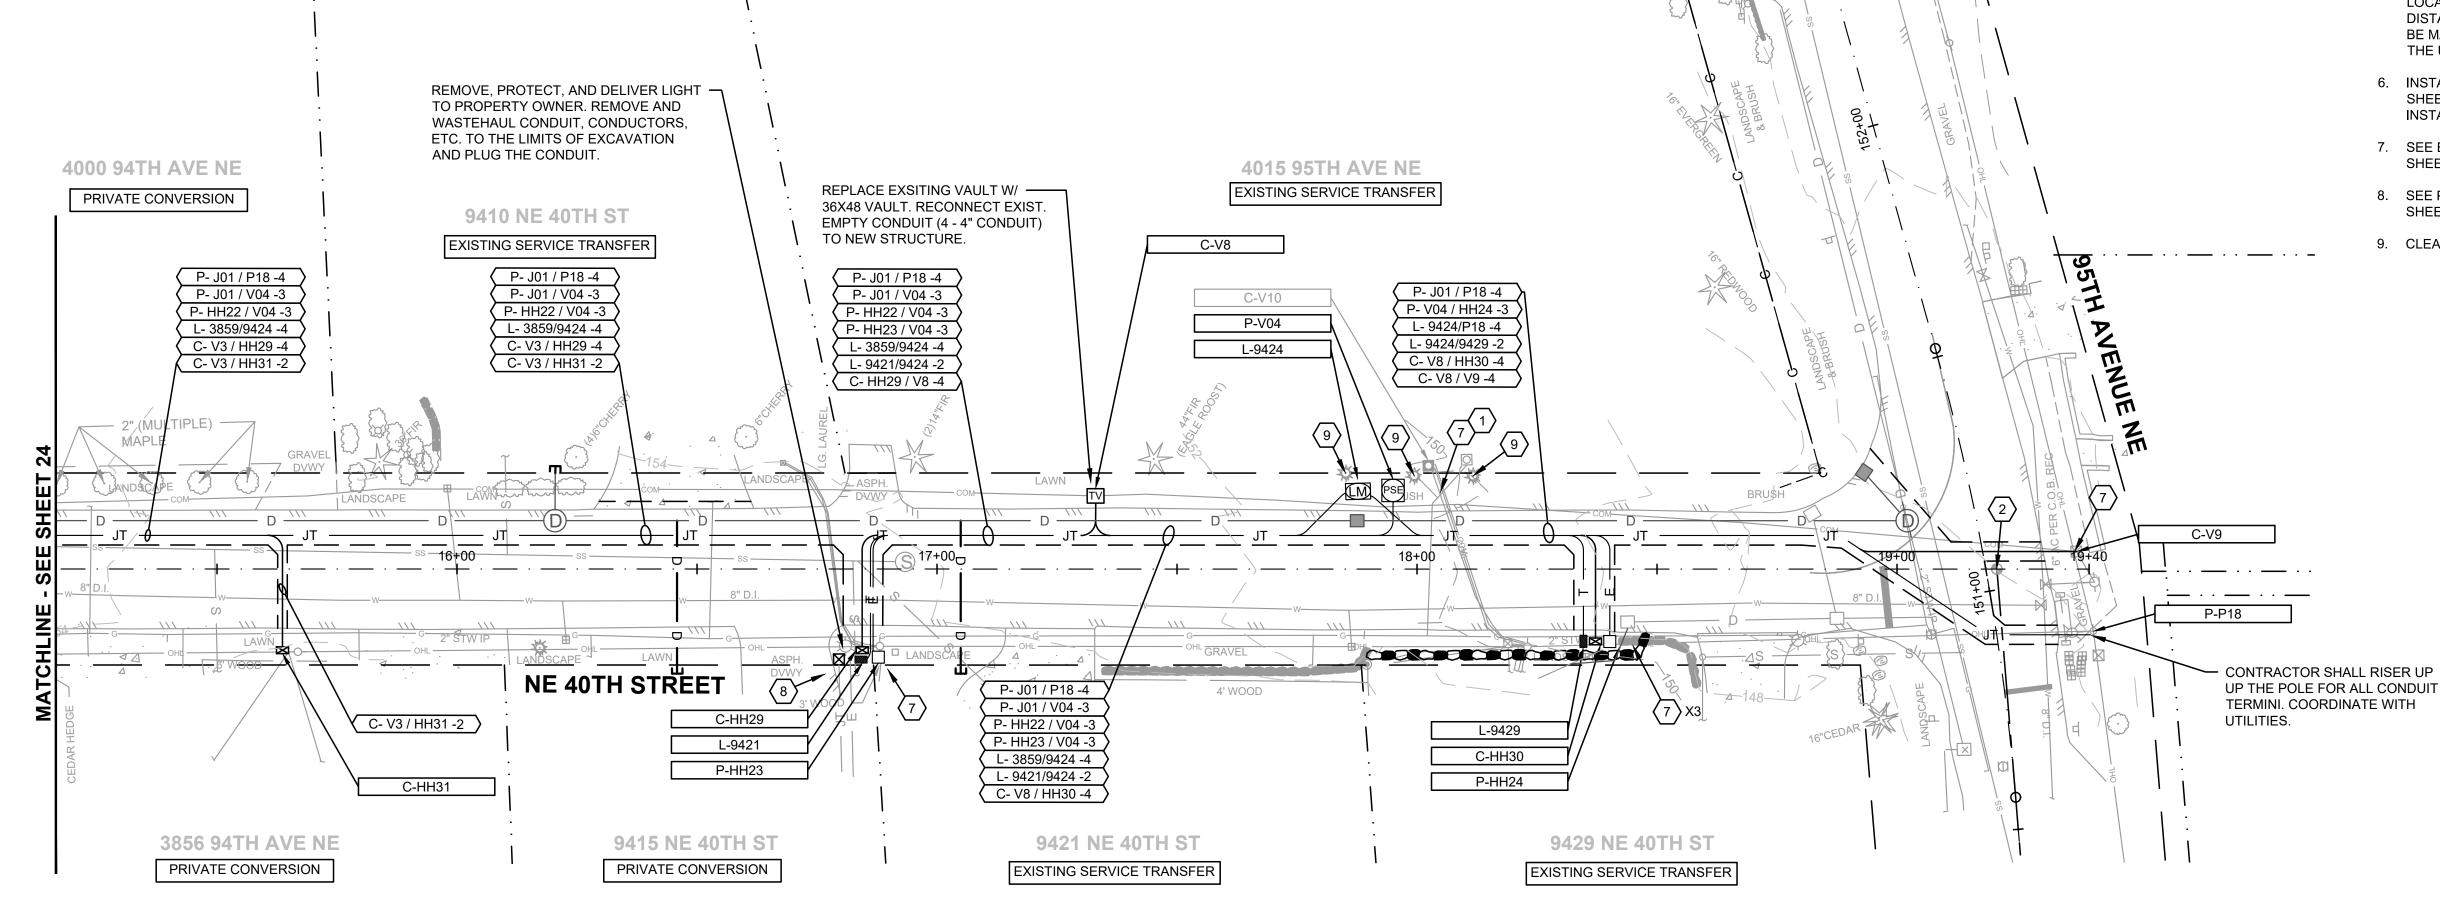


### JOINT UTILITY TRENCH **CONSTRUCTION NOTES**

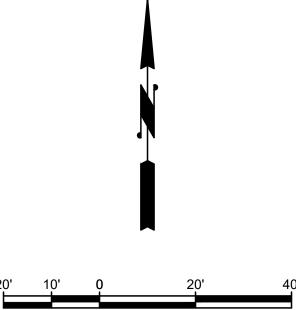- 1. CAUTION: POTENTIAL UTILITY CONFLICT. VERIFY POTHOLE) EXACT LOCATION AND DEPTH OF EXISTING UTILITY. SEE ORDER OF WORK.
- MAILBOX SUPPORT, FENCE, TREE AND UNDERGROUND UTILITY DURING CONSTRUCTION.
- REMOVED BY LUMEN. CONTRACTOR TO COORDINATE.
- 5. INSTALL CONDUIT TO ±2' OF STRUCTURE LOCATION AND EXCAVATE REMAINING DISTANCE. STRUCTURE / CONNECTION WILL BE MADE BY OTHERS. COORDINATE WITH
- 7. SEE EXISTING SERVICE TRANSFER DETAIL,
- CLEAR AND GRUB EXIST. TREE AND STUMP.



- 2. PROTECT EXISTING DRIVEWAY, RETAINING WALL, WATER METER, SURVEY MONUMENT,
- 3. REMOVE AND WASTEHAUL EXIST, AC PIPE AS NEEDED. PLUG ENDS WITH COMMERCIAL
- 4. EXIST. POLE AND APPURTENANCES WILL BE
- THE UTILITY.
- 6. INSTALL STREET LIGHT TUBE PER DETAIL, SHEET PSE INTOLIGHT 1. LIGHT POLE TO BE INSTALLED BY OTHERS.
- SHEET 27.
- 8. SEE PRIVATE CONVERSION DETAIL, SHEET 27.

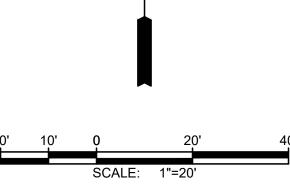

## **BURIED UTILITIES IN AREA CALL BEFORE YOU DIG** 1-800-424-5555

EXISTING UTILITIES SHOWN ARE FROM THE BEST AVAILABLE INFORMATION AND NO GUARANTEE IS MADE AS TO THE EXACT SIZE, TYPE, LOCATION OR DEPTH

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#### APPROVAL FOR CONSTRUCTION

Stand Schweder BY: TOWN OF YARROW POINT

DATE: JANUARY 2024

APPROVAL EXPIRES: <u>JANUARY 2025</u>

Gray & Osborne, Inc. 3710 168TH STREET NORTHEAST. BUILDING B, SUITE 210 ARLINGTON, WA 98223 (360) 454-5490

6







#### **TOWN OF** YARROW POINT

**TOWN WIDE STORMWATER AND UGC PROJECT** 

No. DATE REVISION ISSUED FOR:

**BID PLAN SET** ISSUE DATE: JAN 2024 APPROVED BY: KWB CHECKED BY: KWB DRAWN BY: CJB CJB DESIGNER: G & O JOB NO.: 23445 UGC PLAN.DWG

TWO INCHES AT FULL SCALE IF NOT, SCALE ACCORDINGLY

CIVIL

JOINT UTILITY TRENCH PLAN

DRAWING: **25** OF: **40** 

#### NOTES:


- 1. THE TRENCH SECTION SHOWN IS FOR THE PAYMENT LIMITS FOR BANK RUN GRAVEL FOR TRENCH BACKFILL.
- 2. NUMBER AND SIZE OF CONDUITS AND THE TRENCH WIDTH AND DEPTH VARIES.
- 3. EACH UTILITY WILL MAKE ALL CONNECTIONS TO EXISTING/NEW FACILITIES. THE CONTRACTOR SHALL COORDINATE THIS WORK.
- 4. WORK SHALL BE SEQUENCED TO ALLOW CONTINUAL OPERATION OF ALL EXISTING UNDERGROUND AND AERIAL UTILITIES UNTIL CONVERSIONS ARE COMPLETE.

#### JOINT UTILITY TRENCH SECTION

NOT TO SCALE

#### CONDUIT CALLOUTS

- (1.) CONDUIT(S) FOR PSE. CONDUIT AND SWEEPS WILL BE FURNISHED BY PSE AND INSTALLED BY THE CONTRACTOR.
- 2. CONDUIT(S) FOR LUMEN. CONDUIT AND SWEEPS WILL BE FURNISHED BY LUMEN AND INSTALLED BY THE CONTRACTOR.
- 3. CONDUIT(S) FOR COMCAST. CONDUIT AND SWEEPS WILLL BE FURNISHED BY COMCAST AND INSTALLED BY THE CONTRACTOR.
- 4. CONDUIT FOR PSE INTOLIGHT. CONDUIT AND SWEEPS WILL BE FURNISHED AND INSTALLED BY THE CONTRACTOR.
- 5. 2 INCH LATH FOR SEPARATION. SPACING AS NEEDED. LATH WILL BE FURNISHED BY LUMEN AND INSTALLED BY THE CONTRACTOR.

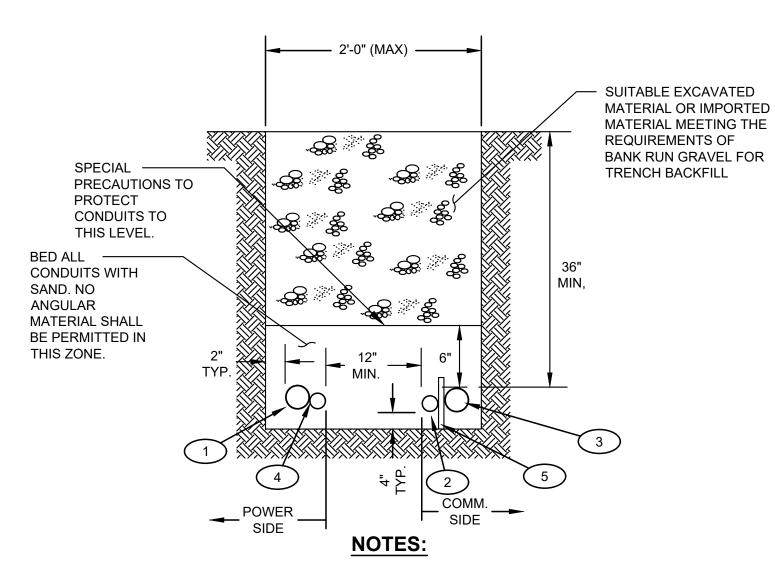

- 1. THE TRENCH SECTION SHOWN IS FOR THE PAYMENT LIMITS FOR BANK RUN GRAVEL FOR TRENCH BACKFILL.
- 2. EACH UTILITY WILL MAKE ALL ACTIVE CONNECTIONS TO EXISTING/NEW FACILITIES, SEE CONNECTION DETAILS, SHEET 27. THE CONTRACTOR SHALL COORDINATE THIS WORK.
- 3. WORK SHALL BE SEQUENCED TO ALLOW CONTINUAL OPERATION OF ALL EXISTING UNDERGROUND AND AERIAL UTILITIES UNTIL CONVERSIONS ARE COMPLETE.
- 4. NUMBER AND SIZE OF CONDUITS, NUMBER OF UTILITY OWNERS, AND TRENCH WIDTH, AND DEPTH VARIES.


#### JOINT SERVICE TRENCH SECTION


NOT TO SCALE



3710 168TH STREET NORTHEAST BUILDING B, SUITE 210 ARLINGTON, WA 98223 (360) 454-5490



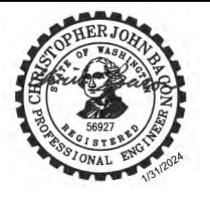

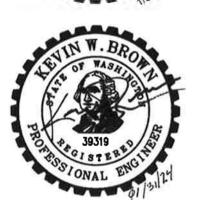

TOWN OF YARROW POINT

TOWN WIDE STORMWATER AND UGC PROJECT

No. DATE REVISION

ISSUED FOR:

BID PLAN SET

ISSUE DATE:

APPROVED BY:

KWB

CHECKED BY:

KEVIOION

KEVIOION

KEVIOION

DRAWN BY: CJB
DESIGNER: CJB
G & O JOB NO.: 23445
FILE: DETAILS.DWG

TWO INCHES AT FULL SCALE.
IF NOT, SCALE ACCORDINGLY

CIVIL

JOINT TRENCH DETAILS

DRAWING: **26** OF: **40** 

APPROVAL FOR CONSTRUCTION
Stand Schweder


BY: TOWN OF YARROW POINT


DATE: JANUARY 2024

APPROVAL EXPIRES: <u>JANUARY 2025</u>

TANKIADY 2025

row Point\23445.00 Town Wide Storm and UGC\01 Design\PLANSET\Civil\DET

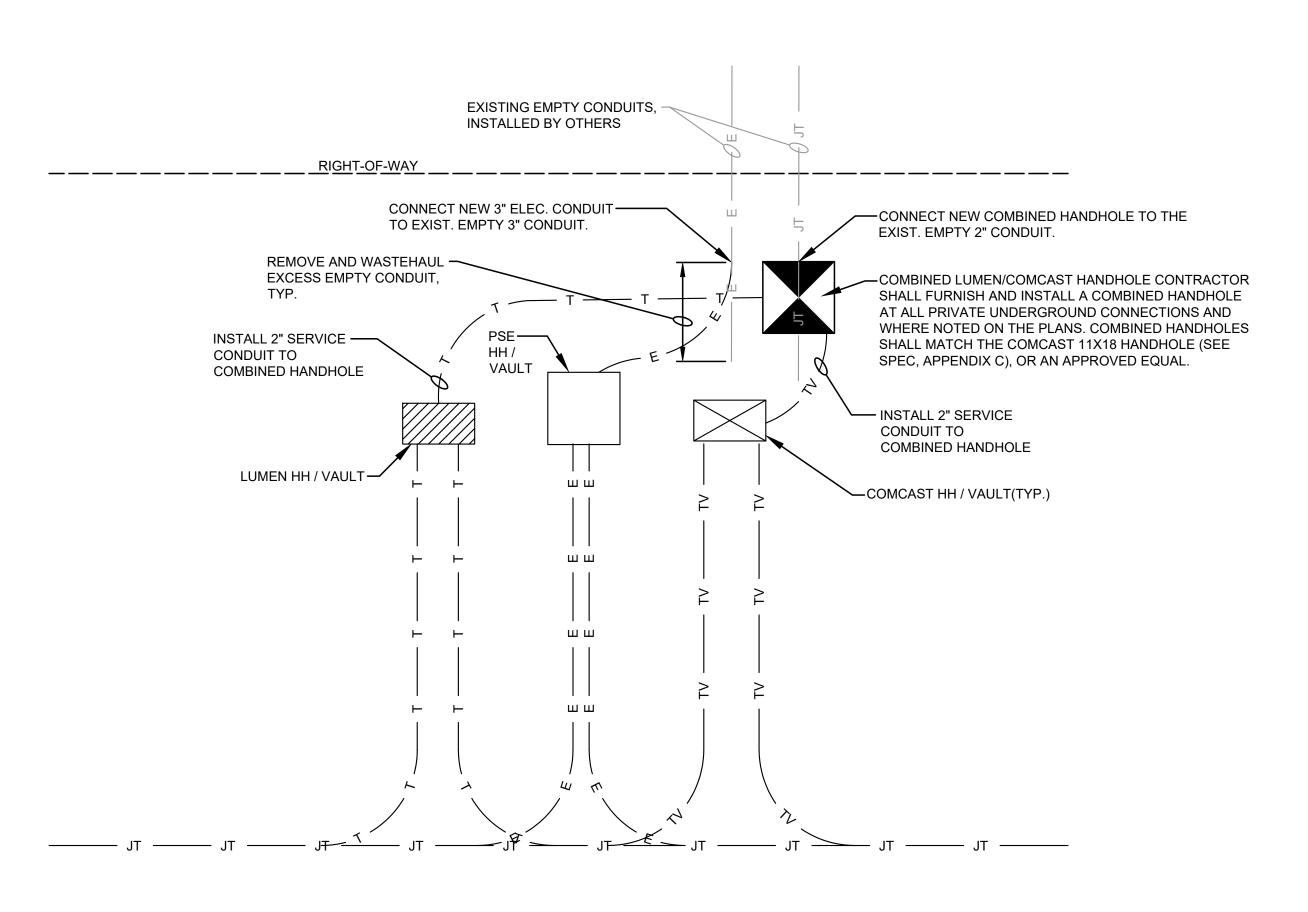

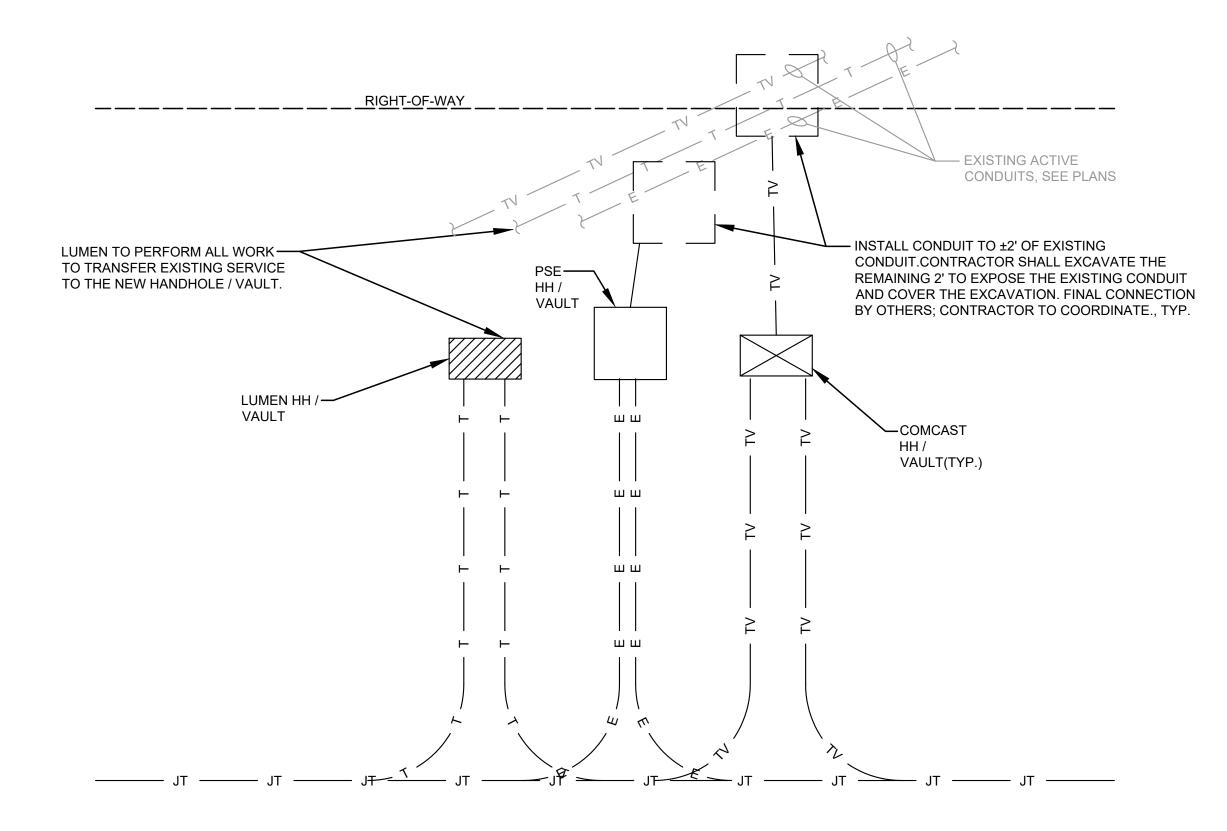

#### NOTES:

- 1. STRUCTURE TYPE AND CONFIGURATION VARIES, SEE PLANS.
- 2. ALL CONDUIT, BOXES AND TRENCHING SHALL BE MEASURED AND PAID FOR UNDER UNIT BID PRICES.

#### PRIVATE CONVERSION DETAIL


NOT TO SCALE

### NOTES:

1. STRUCTURE TYPE AND CONFIGURATION VARIES, SEE PLANS.

### **EXISTING SERVICE TRANSFER DETAIL**

NOT TO SCALE

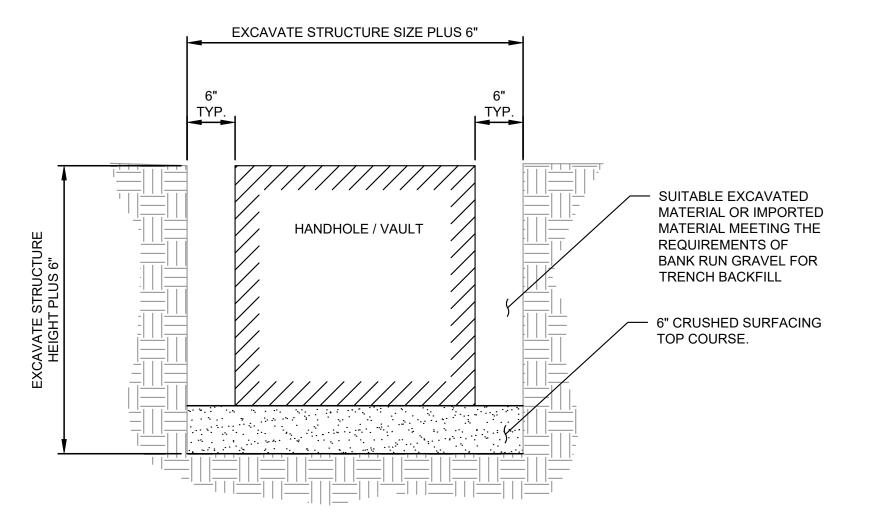

UTILITY STRUCTURE EXCAVATION DETAIL
(LUMEN, COMCAST AND COMBINED STRUCTURES)

NOT TO SCALE

APPROVAL FOR CONSTRUCTION

Staud Schweder
BY: TOWN OF YARROW POINT


DATE: JANUARY 2024


APPROVAL EXPIRES: <u>JANUARY 2025</u>

Gray & Osborne, Inc.

3710 168TH STREET NORTHEAST BUILDING B, SUITE 210 ARLINGTON, WA 98223 (360) 454-5490



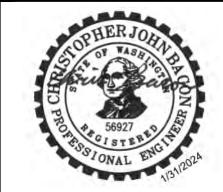

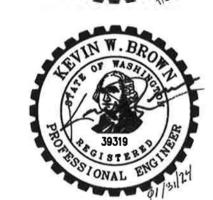

TOWN OF YARROW POINT

TOWN WIDE
STORMWATER AND
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TWO INCHES AT FULL SCALE.
IF NOT, SCALE ACCORDINGLY

CIVIL

JOINT TRENCH DETAILS

DRAWING: **27** OF: **40** 

UTILITY S' (LUMEN, COM

- 1. ALL PLASTIC PAVEMENT MARKINGS SHALL BE TYPE D-1 MMA UNLESS INDICATED OTHERWISE.
- 2. FURNISH AND INSTALL TEMPORARY PAVEMENT MARKINGS IMMEDIATELY FOLLOWING PAVING.
- 3. SEED, MULCH, AND FERTILIZE (HYDROSEED) OVER 4" COMPACTED DEPTH TOPSOIL IN ALL DISTURBED AREAS, EXCEPT AS NOTED ON THESE SHEETS OR AS DIRECTED BY THE CONTRACTING AGENCY.

#### **CHANNELIZATION AND SIGNING NOTES:**

9218 NE 38TH ST

NE 38TH STREET

9222 NE 37TH PL

TERRACE/WALLS

6' WOOD ON

9228 NE 37TH PL

1. FURNISH AND INSTALL PLASTIC STOP LINE.

CONC. LANDSCAPE

GRAVEL PARKING LOT

TERRACE/WALLS

3800 92ND AVE NE

9207 NE 38TH ST

} 10" BIRCH

LANDSCAPE


- 2. INSTALL NEW SIGN(S) AND POST(S) PER DETAIL, SHEET 38.
- 3. RELOCATE EXISTING SIGN. FURNISH AND INSTALL NEW POST(S) AND HARDWARE. WASTEHAUL EXISTING POST(S) AND FOUNDATION.

#### RESTORATION NOTES:

- 1. INSTALL SINGLE TIMBER EDGING PER DETAIL, SHEET 37.
- INSTALL STACKED TIMBER EDGING PER DETAIL, SHEET 37. MAX HEIGHT AS NOTED.
- REMOVE AND WASTEHAUL PAVEMENT. FINAL LOCATIONS SHALL BE DETERMINED IN THE FIELD BY THE CONTRACTING AGENCY.
- REMOVE AND WASTEHAUL EXISTING FENCE, INSTALL NEW 6' WOOD FENCE PER DETAIL, SHEET.

**3805 94TH AVE NE** 


5. INSTALL CATCH BASIN BERM PER DETAIL, SHEET 38.

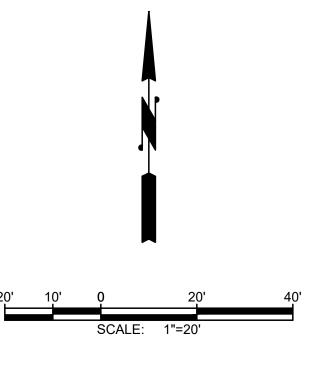



BUILDING B, SUITE 210 ARLINGTON, WA 98223 (360) 454-5490



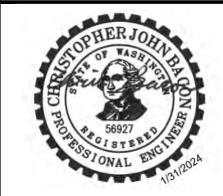




## **TOWN OF** YARROW POINT


**TOWN WIDE** STORMWATER AND **UGC PROJECT** 

#### LEGEND:

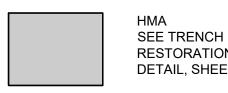

RESTORATION DETAIL, SHEET 38



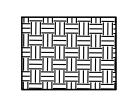

2" BARK MULCH **OVER 4" TOPSOIL** 



2" CSTC

No. DATE REVISION

ISSUED FOR: **BID PLAN SET** ISSUE DATE: JAN 2024 APPROVED BY: KWB

CHECKED BY: KWB CJB DRAWN BY: CJB DESIGNER: 23445 G & O JOB NO.: FILE: RESTORATION PLAN.DWG

> TWO INCHES AT FULL SCALE IF NOT, SCALE ACCORDINGLY

> > CIVIL

**RESTORATION PLAN** 

**BURIED UTILITIES IN AREA CALL BEFORE YOU DIG** 1-800-424-5555 EXISTING UTILITIES SHOWN ARE FROM THE BEST AVAILABLE INFORMATION AND NO GUARANTEE IS MADE AS TO THE EXACT SIZE, TYPE, LOCATION OR DEPTH

LAWN


9240 NE 37TH PL

#### **APPROVAL FOR CONSTRUCTION** Stand Schweder

BY: TOWN OF YARROW POINT

DATE: JANUARY 2024

DRAWING: 28 OF: 40

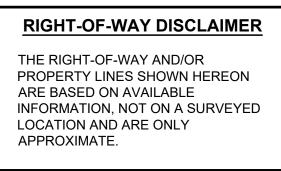

CONTRACTOR SHALL VERIFY THAT —

RUNOFF FROM ROADWAY DOES NOT

ENTER PRIVATE PROPERTY AFTER THE WEDGE CURB IS INSTALLED.

LAWN \_\_/

(NO ADDRESS)

100+00

APPROVAL EXPIRES: <u>JANUARY 2025</u>

- 1. ALL PLASTIC PAVEMENT MARKINGS SHALL BE TYPE D-1 MMA UNLESS INDICATED OTHERWISE.
- 2. FURNISH AND INSTALL TEMPORARY PAVEMENT MARKINGS IMMEDIATELY FOLLOWING PAVING.
- 3. SEED, MULCH, AND FERTILIZE (HYDROSEED) OVER 4" COMPACTED DEPTH TOPSOIL IN ALL DISTURBED AREAS, EXCEPT AS NOTED ON THESE SHEETS OR AS DIRECTED BY THE CONTRACTING AGENCY.

#### **CHANNELIZATION AND SIGNING NOTES:**

**3813 94TH AVE NE** 

REMAINS OF

CONC. STEPS

E 94TH AVENE

**3812 94TH AVE NE** 

1. FURNISH AND INSTALL PLASTIC STOP LINE.

NE 38TH STREET - SEE SHEET 28

9240 NE 37TH PL

CONC. STEPS/WALK -

**3798 94TH AVE NE** 

3805 94TH AVE NE

LAUREL HEDGE

PSE

3802 94TH AVE NE

- 2. INSTALL NEW SIGN(S) AND POST(S) PER DETAIL, SHEET 38.
- 3. RELOCATE EXISTING SIGN. FURNISH AND INSTALL NEW POST(S) AND HARDWARE. WASTEHAUL EXISTING POST(S) AND FOUNDATION.

#### RESTORATION NOTES:


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- REMOVE AND WASTEHAUL EXISTING FENCE, INSTALL NEW 6' WOOD FENCE PER DETAIL, SHEET.
- 5. INSTALL CATCH BASIN BERM PER DETAIL, SHEET 38.

**3823 94TH AVE NE** 

WOOD MAILBOX

**3824 94TH AVE NE** 

ENCLOSURE

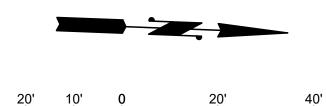




Gray & Osborne, Inc.


3710 168TH STREET NORTHEAST

BUILDING B, SUITE 210

ARLINGTON, WA 98223

(360) 454-5490

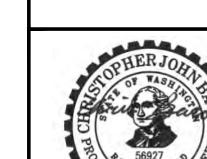


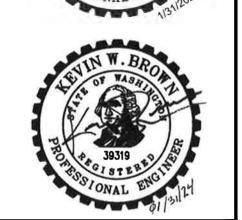


#### **TOWN OF** YARROW POINT

**TOWN WIDE** STORMWATER AND **UGC PROJECT** 


#### **LEGEND**:

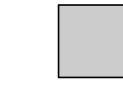


SEE TRENCH RESTORATION DETAIL, SHEET 38

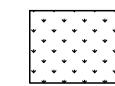

SOD OVER 4" TOPSOIL

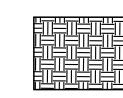


2" BARK MULCH **OVER 4" TOPSOIL** 

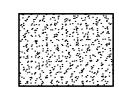

2" CSTC

No.	DATE	REVISION
ISSUED FOR:		

	BID PLAN SET
ISSUE DATE:	JAN 2024
APPROVED BY:	KWB
CHECKED BY:	KWB
DRAWN BY:	CJB
DESIGNER:	CJB

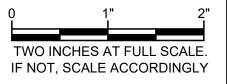

FILE: RESTORATION PLAN.DWG

CIVIL

#### **BURIED UTILITIES IN AREA CALL BEFORE YOU DIG** 1-800-424-5555

EXISTING UTILITIES SHOWN ARE FROM THE BEST AVAILABLE INFORMATION AND NO GUARANTEE IS MADE AS TO THE EXACT SIZE, TYPE, LOCATION OR DEPTH

#### RIGHT-OF-WAY DISCLAIMER APPROVAL FOR CONSTRUCTION

Stand Schweder BY: TOWN OF YARROW POINT

DATE: JANUARY 2024

## **RESTORATION PLAN**

G & O JOB NO.:

DRAWING: **29** OF: **40** 



THE RIGHT-OF-WAY AND/OR PROPERTY LINES SHOWN HEREON

ARE BASED ON AVAILABLE INFORMATION, NOT ON A SURVEYED

LOCATION AND ARE ONLY APPROXIMATE.

APPROVAL EXPIRES: <u>JANUARY 2025</u>

- 1. ALL PLASTIC PAVEMENT MARKINGS SHALL BE TYPE D-1 MMA UNLESS INDICATED OTHERWISE.
- 2. FURNISH AND INSTALL TEMPORARY PAVEMENT MARKINGS IMMEDIATELY FOLLOWING PAVING.
- 3. SEED, MULCH, AND FERTILIZE (HYDROSEED) OVER 4" COMPACTED DEPTH TOPSOIL IN ALL DISTURBED AREAS, EXCEPT AS NOTED ON THESE SHEETS OR AS DIRECTED BY THE CONTRACTING AGENCY.

#### **CHANNELIZATION AND SIGNING NOTES:**

1. FURNISH AND INSTALL PLASTIC STOP LINE.


**3847 94TH AVE NE** 


- 2. INSTALL NEW SIGN(S) AND POST(S) PER DETAIL, SHEET 38.
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- 5. INSTALL CATCH BASIN BERM PER DETAIL, SHEET 38.

**NE 40TH STREET - SEE SHEET 34** 



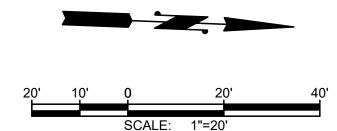

Gray & Osborne, Inc.

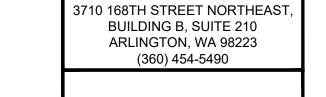






#### **TOWN OF** YARROW POINT

**TOWN WIDE** STORMWATER AND **UGC PROJECT** 

#### **LEGEND**:

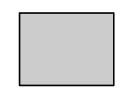

SEE TRENCH RESTORATION DETAIL, SHEET 38







2" CSTC

**OVER 4" TOPSOIL** 

No. DATE REVISION

ISSUED FOR: **BID PLAN SET** ISSUE DATE: JAN 2024 APPROVED BY: KWB

CHECKED BY: CJB DRAWN BY: CJB DESIGNER: G & O JOB NO.: 23445 FILE: RESTORATION PLAN.DWG

> TWO INCHES AT FULL SCALE IF NOT, SCALE ACCORDINGLY

CIVIL

## **RESTORATION PLAN**

DRAWING: **30** OF: **40** 

RIGHT-OF-WAY DISCLAIMER

THE RIGHT-OF-WAY AND/OR PROPERTY LINES SHOWN HEREON ARE BASED ON AVAILABLE INFORMATION, NOT ON A SURVEYED LOCATION AND ARE ONLY

APPROXIMATE.

Stand Schweder BY: TOWN OF YARROW POINT

APPROVAL EXPIRES: <u>JANUARY 2025</u>

**BURIED UTILITIES IN AREA CALL BEFORE YOU DIG** 1-800-424-5555 EXISTING UTILITIES SHOWN ARE FROM THE BEST AVAILABLE INFORMATION AND NO GUARANTEE IS MADE AS TO THE EXACT SIZE, TYPE, LOCATION OR DEPTH

**APPROVAL FOR CONSTRUCTION** 

DATE: JANUARY 2024

**3843 94TH AVE NE** 

3833 94TH AVE NE

**3837 94TH AVE NE** 

LANDSCAPE. 94TH AVE NE WOOD MAILBOX \_ CONONSTERS -ENCLOSURE WOOD STEPS 5' WOOD · \_ WOOD MAILBOX ENCLOSURE CEDAR HEDGE -4000 94TH AVE NE ☐ PROTECT WOOD FENCE **3848 94TH AVE NE 3856 94TH AVE NE** 3838 94TH AVE NE **3842 94TH AVE NE** 3834 94TH AVE NE **NE 40TH STREET - SEE SHEET 35** 

9317 NE 40TH ST


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#### **CHANNELIZATION AND SIGNING NOTES:**

- 1. FURNISH AND INSTALL PLASTIC STOP LINE.
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3710 168TH STREET NORTHEAST BUILDING B, SUITE 210 ARLINGTON, WA 98223 (360) 454-5490






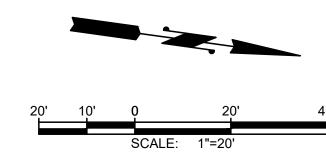


### **TOWN OF** YARROW POINT

**TOWN WIDE** STORMWATER AND **UGC PROJECT** 


#### **LEGEND**:

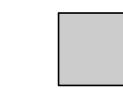

SEE TRENCH RESTORATION DETAIL, SHEET 38

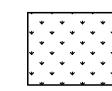

SOD OVER 4" TOPSOIL

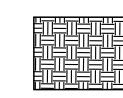


2" BARK MULCH **OVER 4" TOPSOIL** 



2" CSTC

No.	DATE	REVISION
ISSUED FOR:		

	BID PLAN SET
ISSUE DATE:	JAN 2024
APPROVED BY:	KWB
CHECKED BY:	KWB
DRAWN BY:	CJB
DESIGNER:	CJB
G & O JOB NO.:	23445

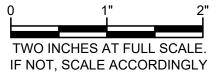

FILE: RESTORATION PLAN.DWG

CIVIL

#### **BURIED UTILITIES IN AREA** CALL BEFORE YOU DIG 1-800-424-5555

EXISTING UTILITIES SHOWN ARE FROM THE BEST AVAILABLE INFORMATION AND NO GUARANTEE IS MADE AS TO THE EXACT SIZE, TYPE, LOCATION OR DEPTH

#### APPROVAL FOR CONSTRUCTION


BY: TOWN OF YARROW POINT

DATE: JANUARY 2024

APPROVAL EXPIRES: <u>JANUARY 2025</u>

**RESTORATION PLAN** 

DRAWING: 31 OF: 40

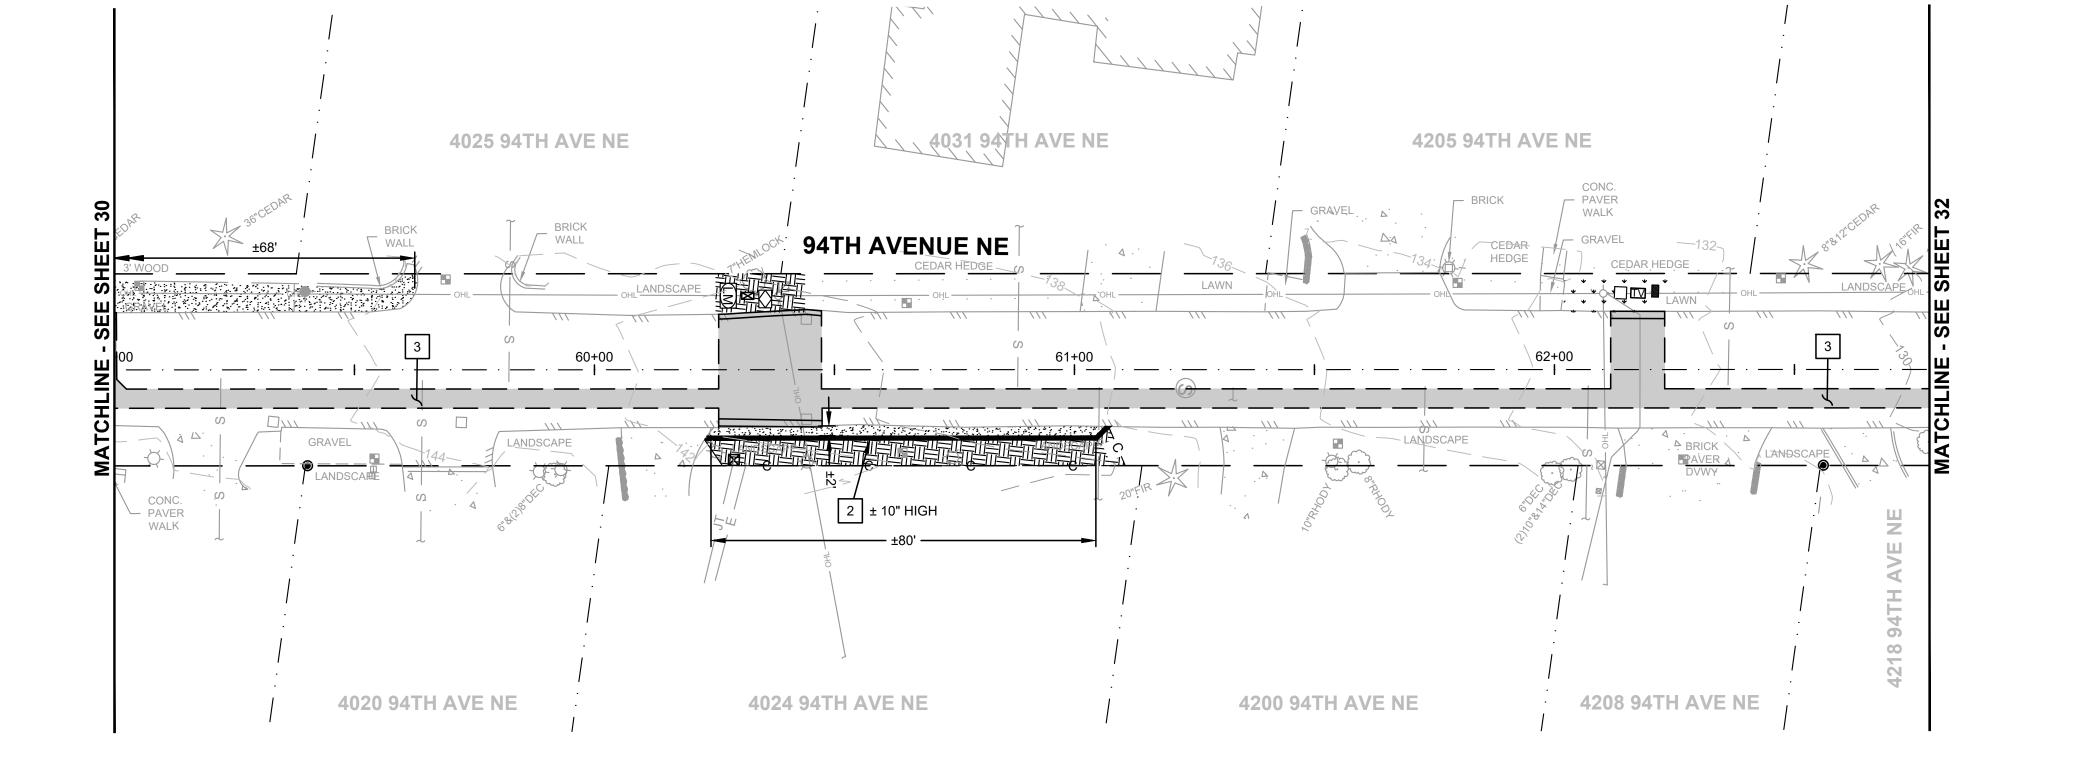

#### RIGHT-OF-WAY DISCLAIMER

THE RIGHT-OF-WAY AND/OR PROPERTY LINES SHOWN HEREON ARE BASED ON AVAILABLE INFORMATION, NOT ON A SURVEYED LOCATION AND ARE ONLY APPROXIMATE.

- 1. ALL PLASTIC PAVEMENT MARKINGS SHALL BE TYPE D-1 MMA UNLESS INDICATED OTHERWISE.
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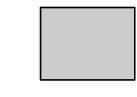


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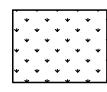


(360) 454-5490


#### **LEGEND**:




SEE TRENCH RESTORATION DETAIL, SHEET 38



SOD OVER 4" TOPSOIL

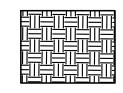

2" BARK MULCH **OVER 4" TOPSOIL** 

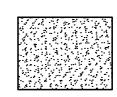

2" CSTC



**TOWN OF** YARROW POINT

**TOWN WIDE** STORMWATER AND **UGC PROJECT** 

No. DATE REVISION

ISSUED FOR: **BID PLAN SET** 

ISSUE DATE: JAN 2024 APPROVED BY: KWB KWB CHECKED BY: CJB DRAWN BY: CJB DESIGNER: G & O JOB NO.: 23445

TWO INCHES AT FULL SCALE IF NOT, SCALE ACCORDINGLY

FILE: RESTORATION PLAN.DWG

CIVIL

BEST AVAILABLE INFORMATION AND NO GUARANTEE IS MADE AS TO THE EXACT SIZE, TYPE, LOCATION OR DEPTH

**BURIED UTILITIES IN AREA CALL BEFORE YOU DIG** 1-800-424-5555 EXISTING UTILITIES SHOWN ARE FROM THE

#### APPROVAL FOR CONSTRUCTION

Stand Schweder

DATE: JANUARY 2024

APPROVAL EXPIRES: <u>JANUARY 2025</u>

## RIGHT-OF-WAY DISCLAIMER

THE RIGHT-OF-WAY AND/OR

ARE BASED ON AVAILABLE

LOCATION AND ARE ONLY

APPROXIMATE.


PROPERTY LINES SHOWN HEREON

INFORMATION, NOT ON A SURVEYED

BY: TOWN OF YARROW POINT

**RESTORATION PLAN** 

DRAWING: **32** OF: **40** 

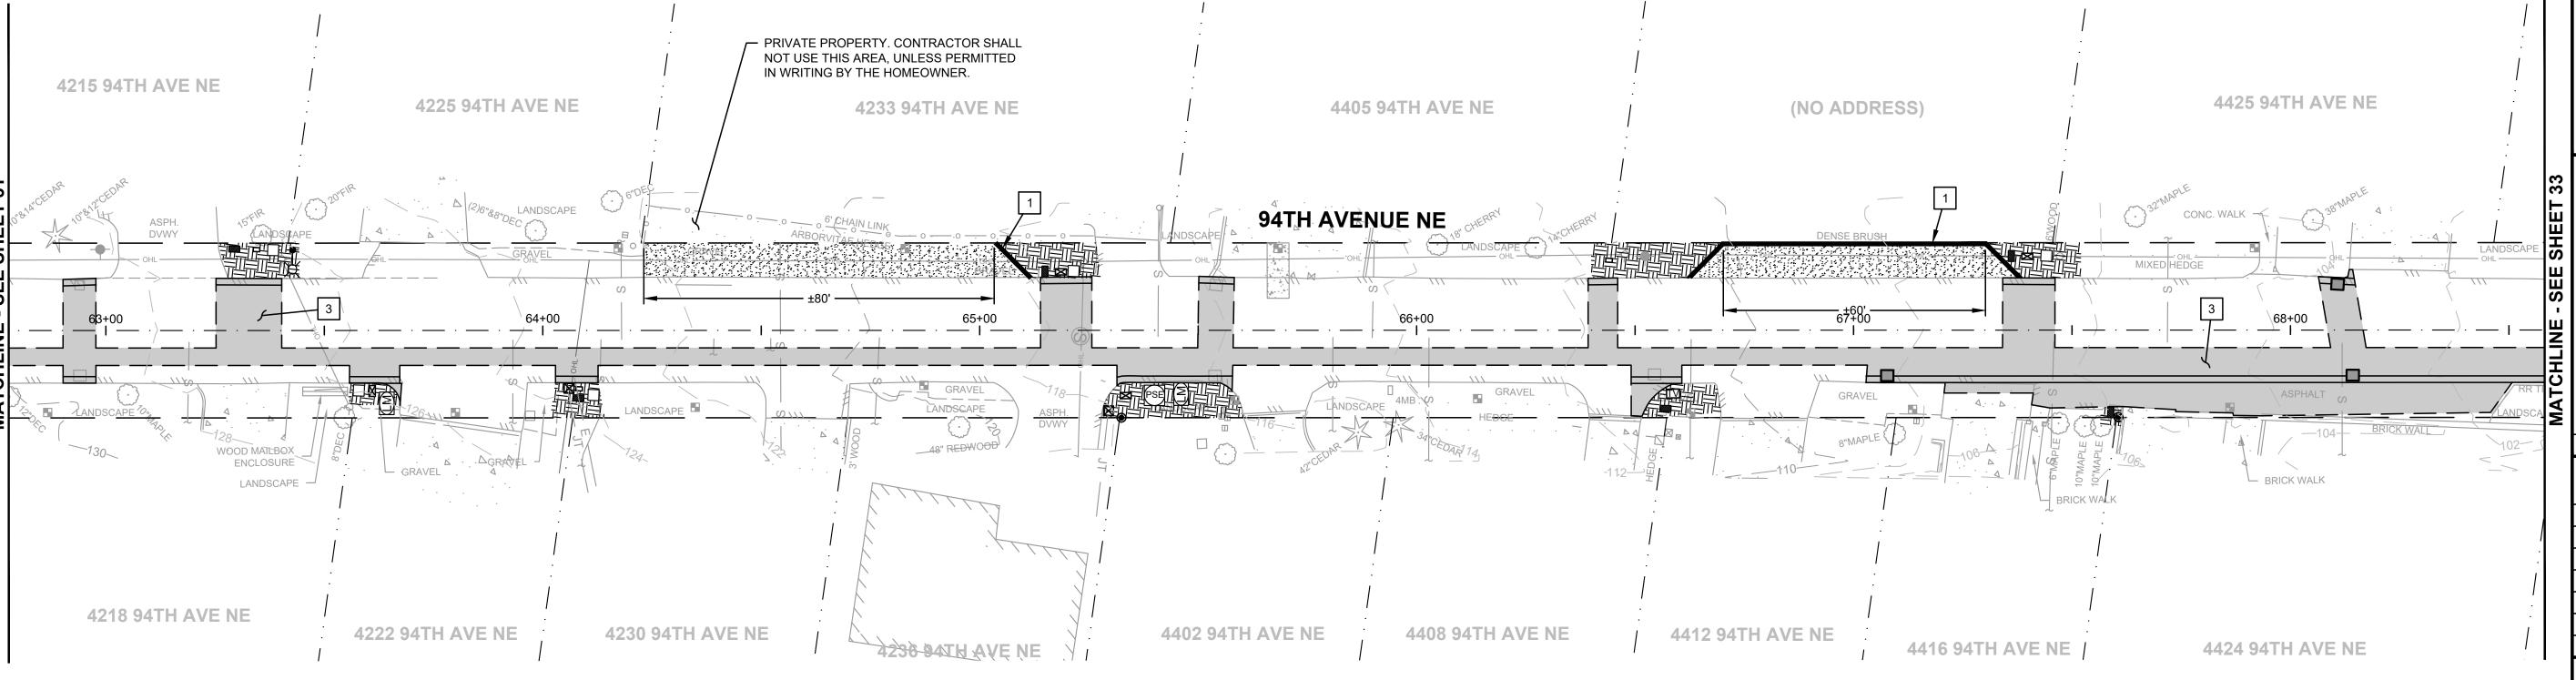

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#### CHANNELIZATION AND SIGNING NOTES:


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#### **¬ RESTORATION NOTES:**


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- 5. INSTALL CATCH BASIN BERM PER DETAIL, SHEET 38.

# 20' 10' 0 20'


## LEGEND:

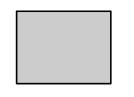

SEE TRENCH RESTORATION DETAIL, SHEET 38

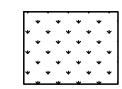

SOD OVER 4" TOPSOIL

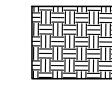

RIGHT-OF-WAY DISCLAIMER

PROPERTY LINES SHOWN HEREON

INFORMATION, NOT ON A SURVEYED


THE RIGHT-OF-WAY AND/OR

ARE BASED ON AVAILABLE

LOCATION AND ARE ONLY

APPROXIMATE.

2" BARK MULCH OVER 4" TOPSOIL

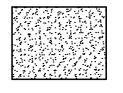

2" CSTC


**APPROVAL FOR CONSTRUCTION** 

BY: TOWN OF YARROW POINT

APPROVAL EXPIRES: <u>JANUARY 2025</u>

Stand Schweder

DATE: JANUARY 2024

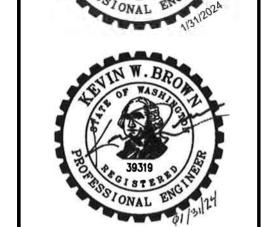

Gray & Osborne, Inc.

3710 168TH STREET NORTHEAST


BUILDING B, SUITE 210 ARLINGTON, WA 98223

(360) 454-5490

YARROW POINT

## TOWN OF YARROW POINT

TOWN WIDE
STORMWATER AND
UGC PROJECT

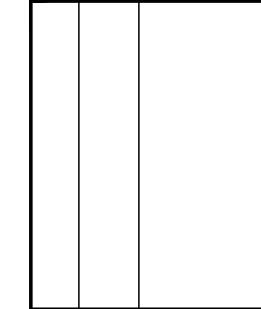

No. DATE REVISION
ISSUED FOR:

BID PLAN SET

ISSUE DATE: JAN 2024

APPROVED BY: KWB

CHECKED BY: KWB

DRAWN BY: CJB


DESIGNER: CJB
G & O JOB NO.: 23445
FILE: RESTORATION PLAN.DWG

TWO INCHES AT FULL SCALE.
IF NOT, SCALE ACCORDINGLY

CIVIL

RESTORATION PLAN

DRAWING: **33** OF: **40** 

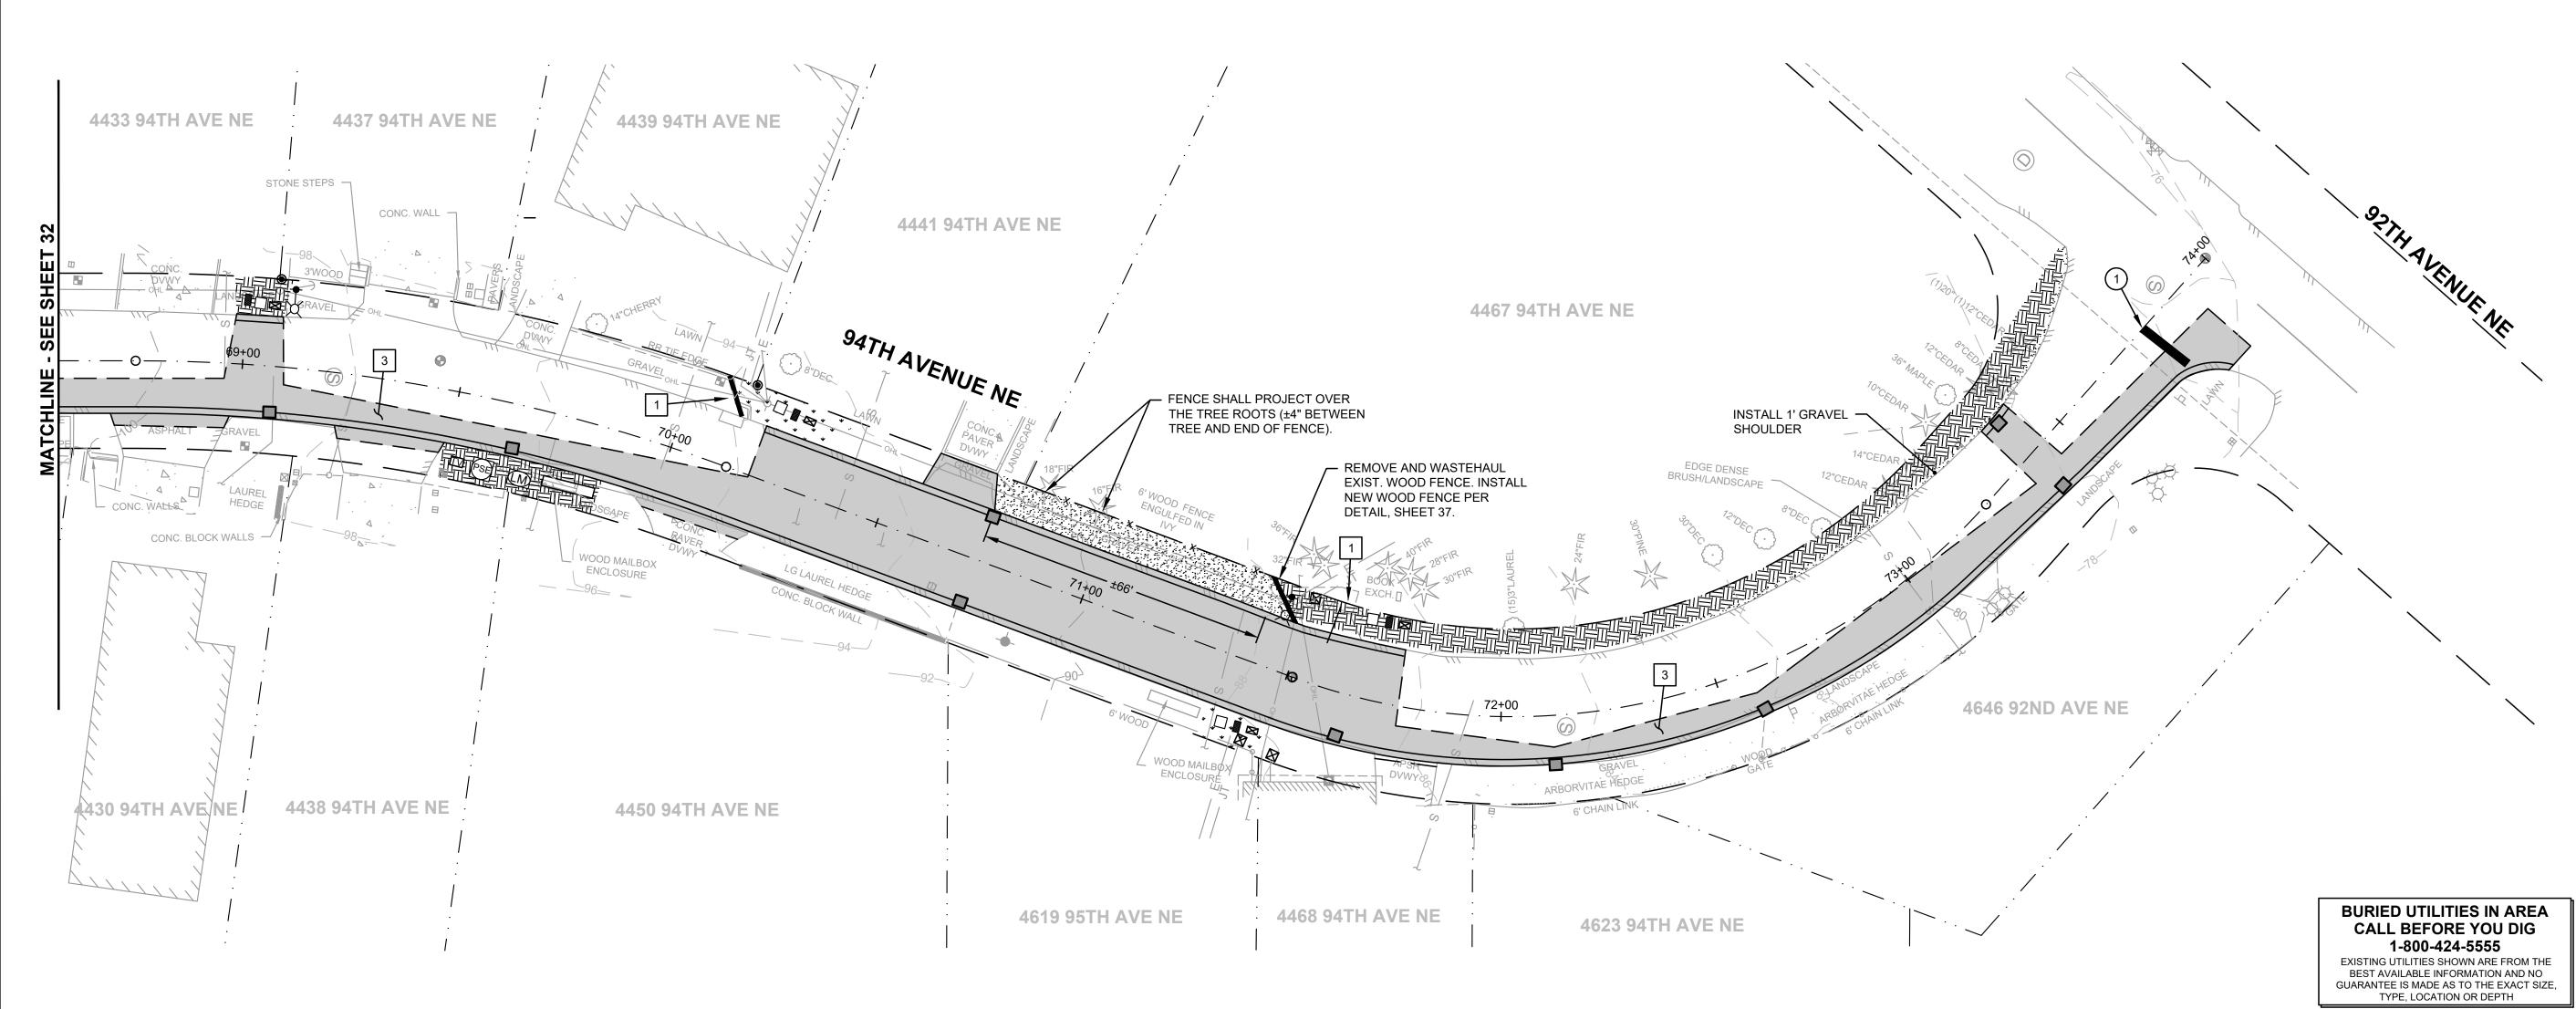

- 1. ALL PLASTIC PAVEMENT MARKINGS SHALL BE TYPE D-1 MMA UNLESS INDICATED OTHERWISE.
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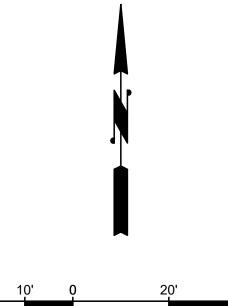
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6" SEPARATION MIN.

BLOWUP SCALE: 1" = 5'

- REMOVE AND WASTEHAUL EXISTING FENCE, INSTALL NEW 6' WOOD FENCE PER DETAIL, SHEET.
- 5. INSTALL CATCH BASIN BERM PER DETAIL, SHEET 38.





6

Gray & Osborne, Inc.

3710 168TH STREET NORTHEAST


BUILDING B, SUITE 210 ARLINGTON, WA 98223

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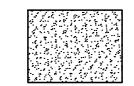
SEE TRENCH RESTORATION DETAIL, SHEET 38



SOD OVER 4" TOPSOIL

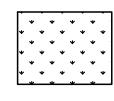

2" BARK MULCH **OVER 4" TOPSOIL** 



BY: TOWN OF YARROW POINT

APPROVAL EXPIRES: <u>JANUARY 2025</u>

DATE: JANUARY 2024


ARE BASED ON AVAILABLE

LOCATION AND ARE ONLY

APPROXIMATE.


INFORMATION, NOT ON A SURVEYED

2" CSTC

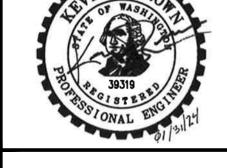

**TOWN OF** YARROW POINT

**TOWN WIDE** STORMWATER AND **UGC PROJECT** 

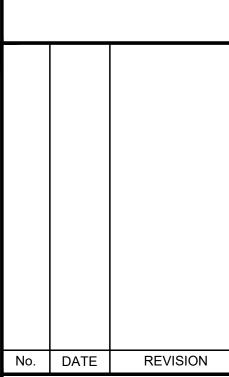

ISSUED FOR:

**BID PLAN SET** ISSUE DATE: JAN 2024 APPROVED BY: KWB KWB CHECKED BY: CJB DRAWN BY:

CJB

G & O JOB NO.: 23445 FILE: RESTORATION PLAN.DWG


DESIGNER:


TWO INCHES AT FULL SCALE IF NOT, SCALE ACCORDINGLY


CIVIL


**RESTORATION PLAN** 

DRAWING: **34** OF: **40** 

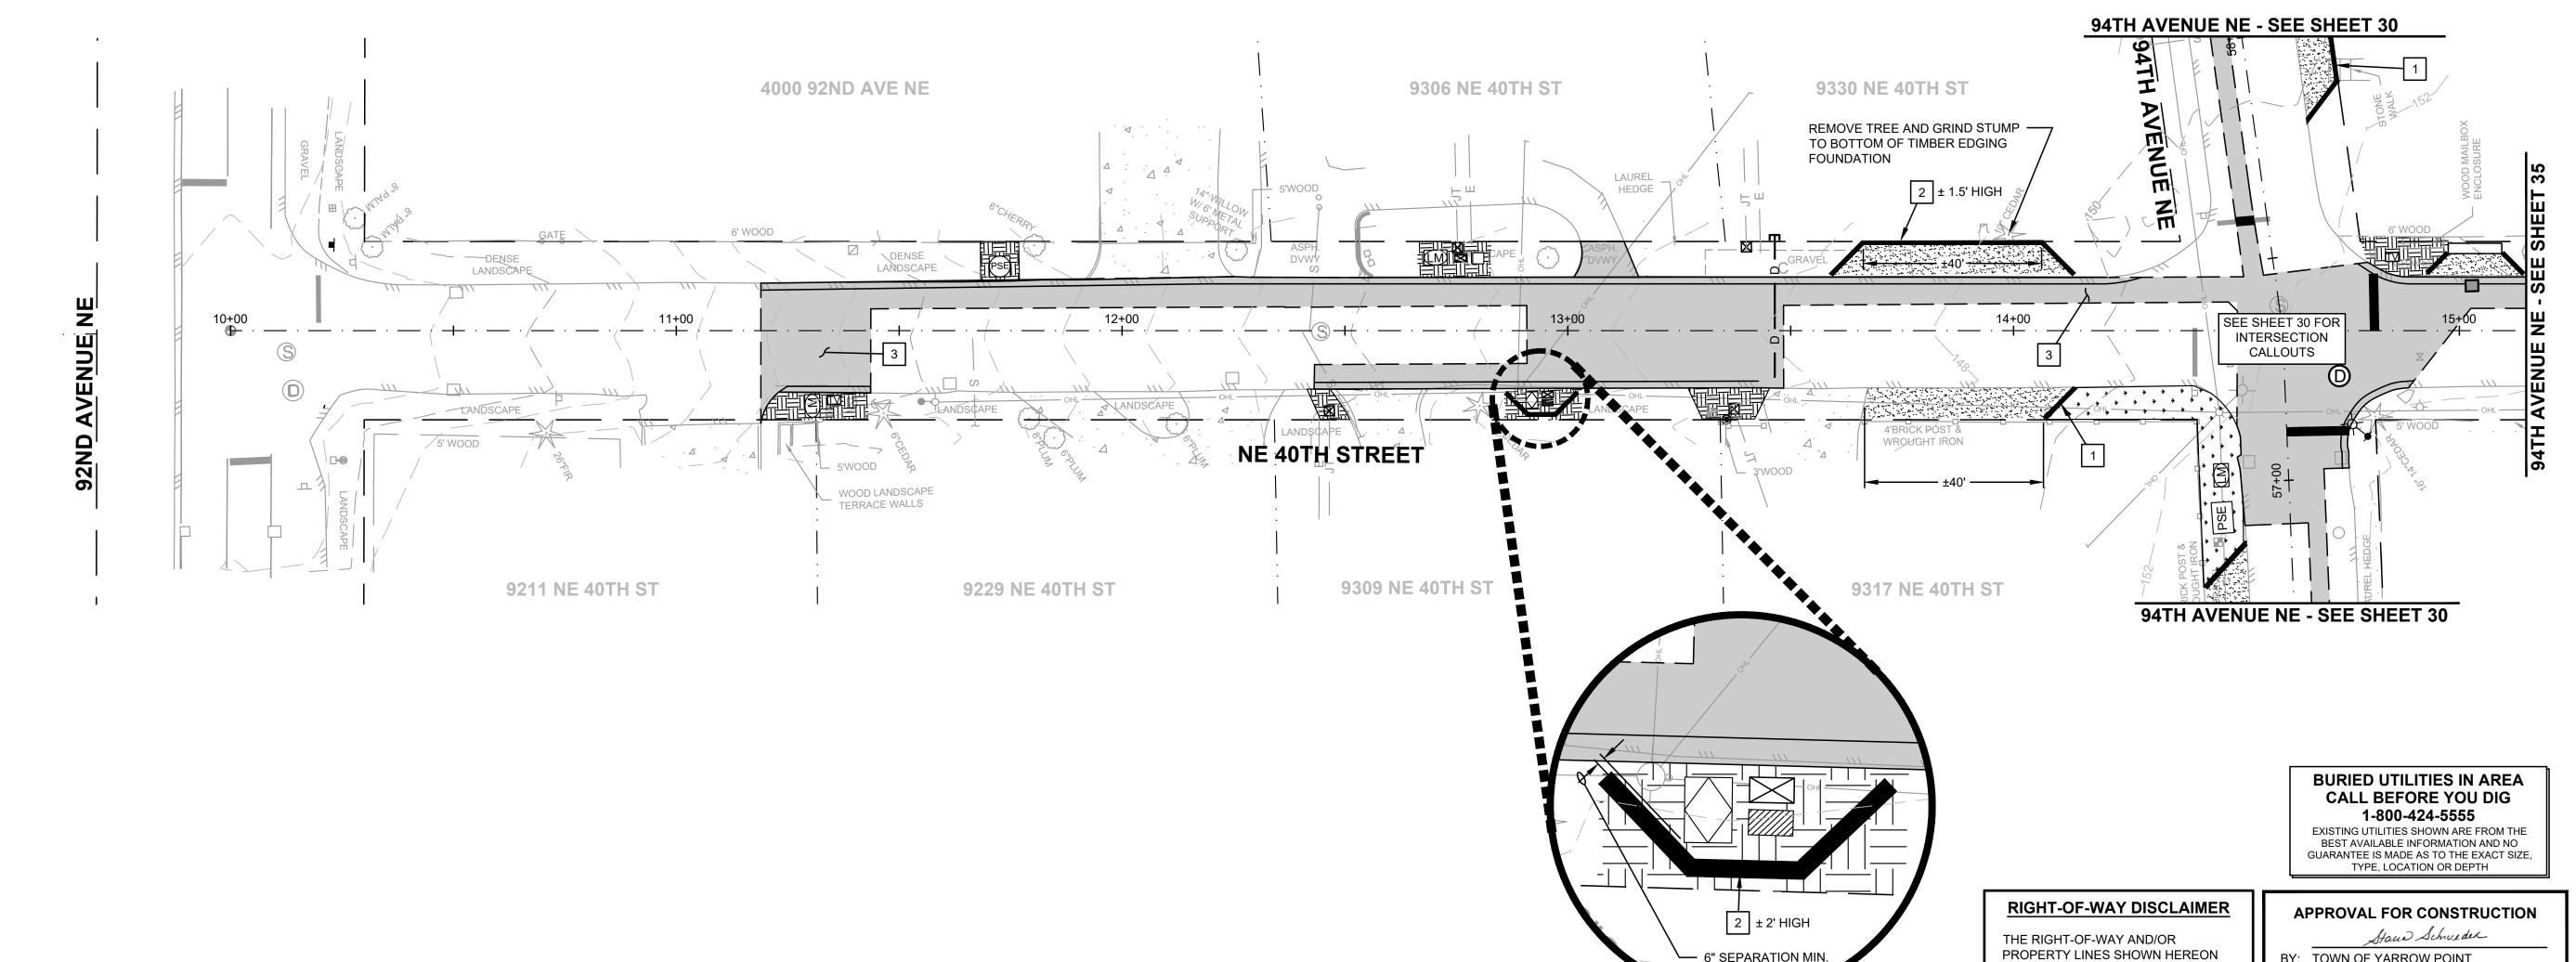

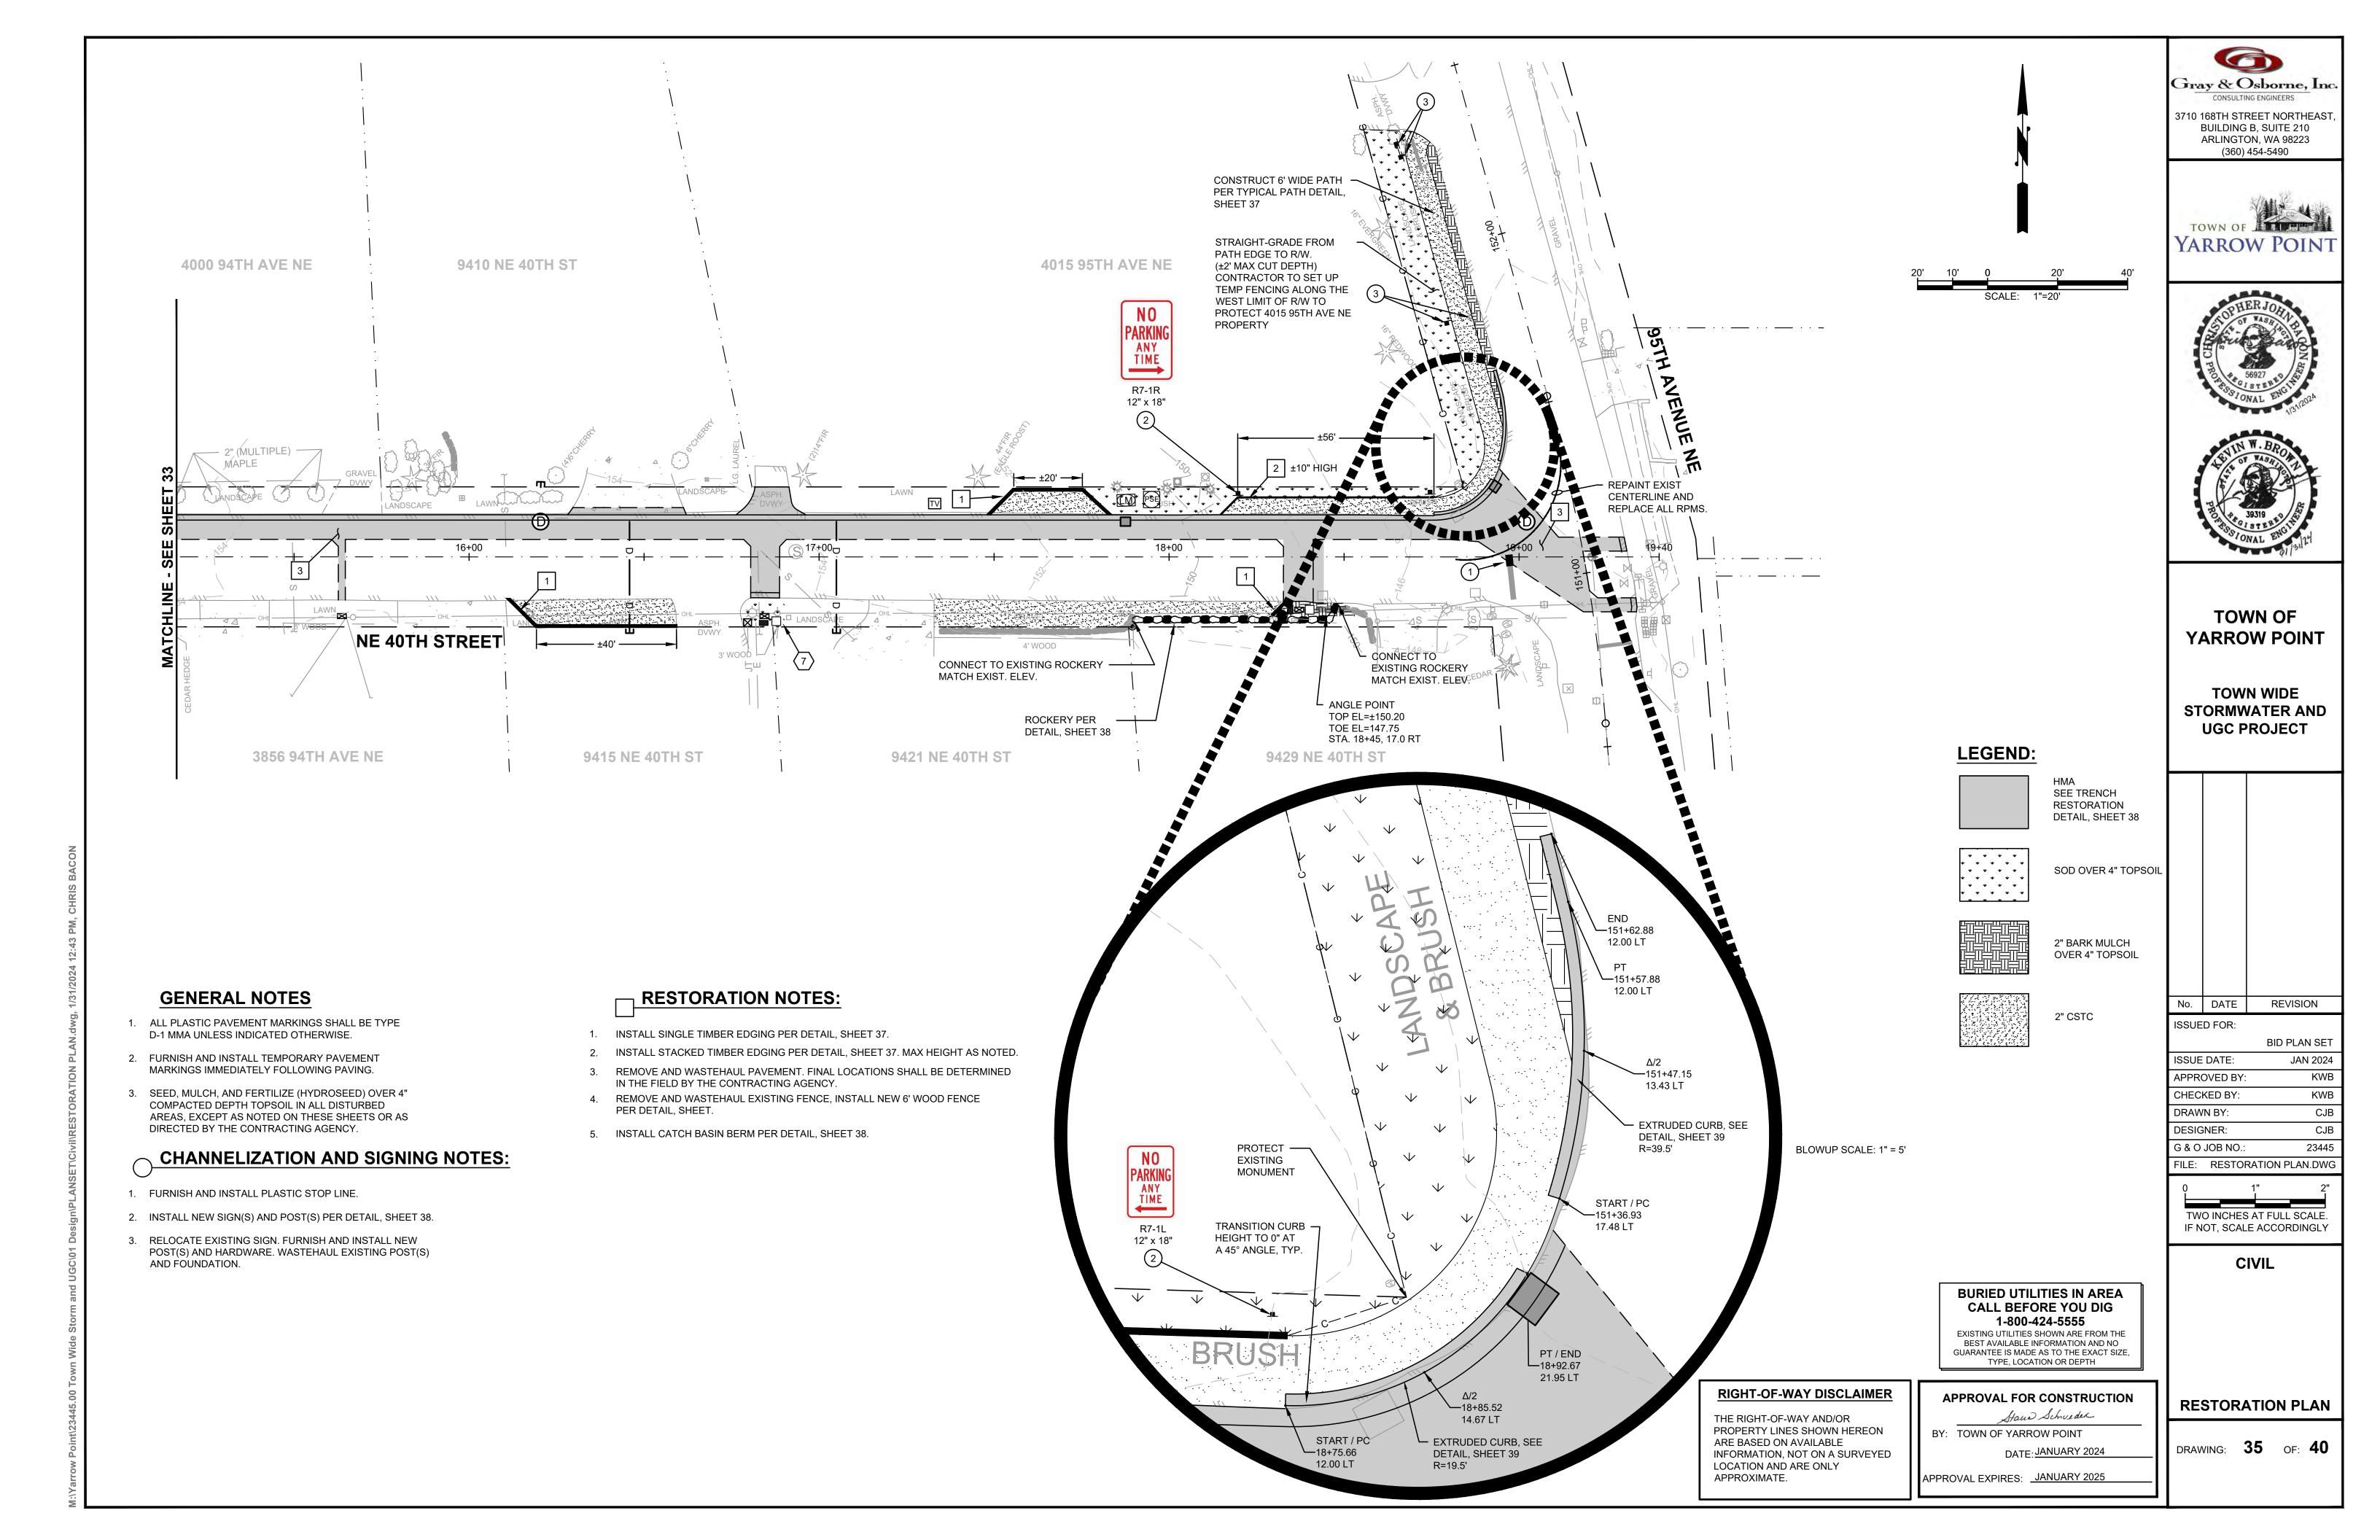

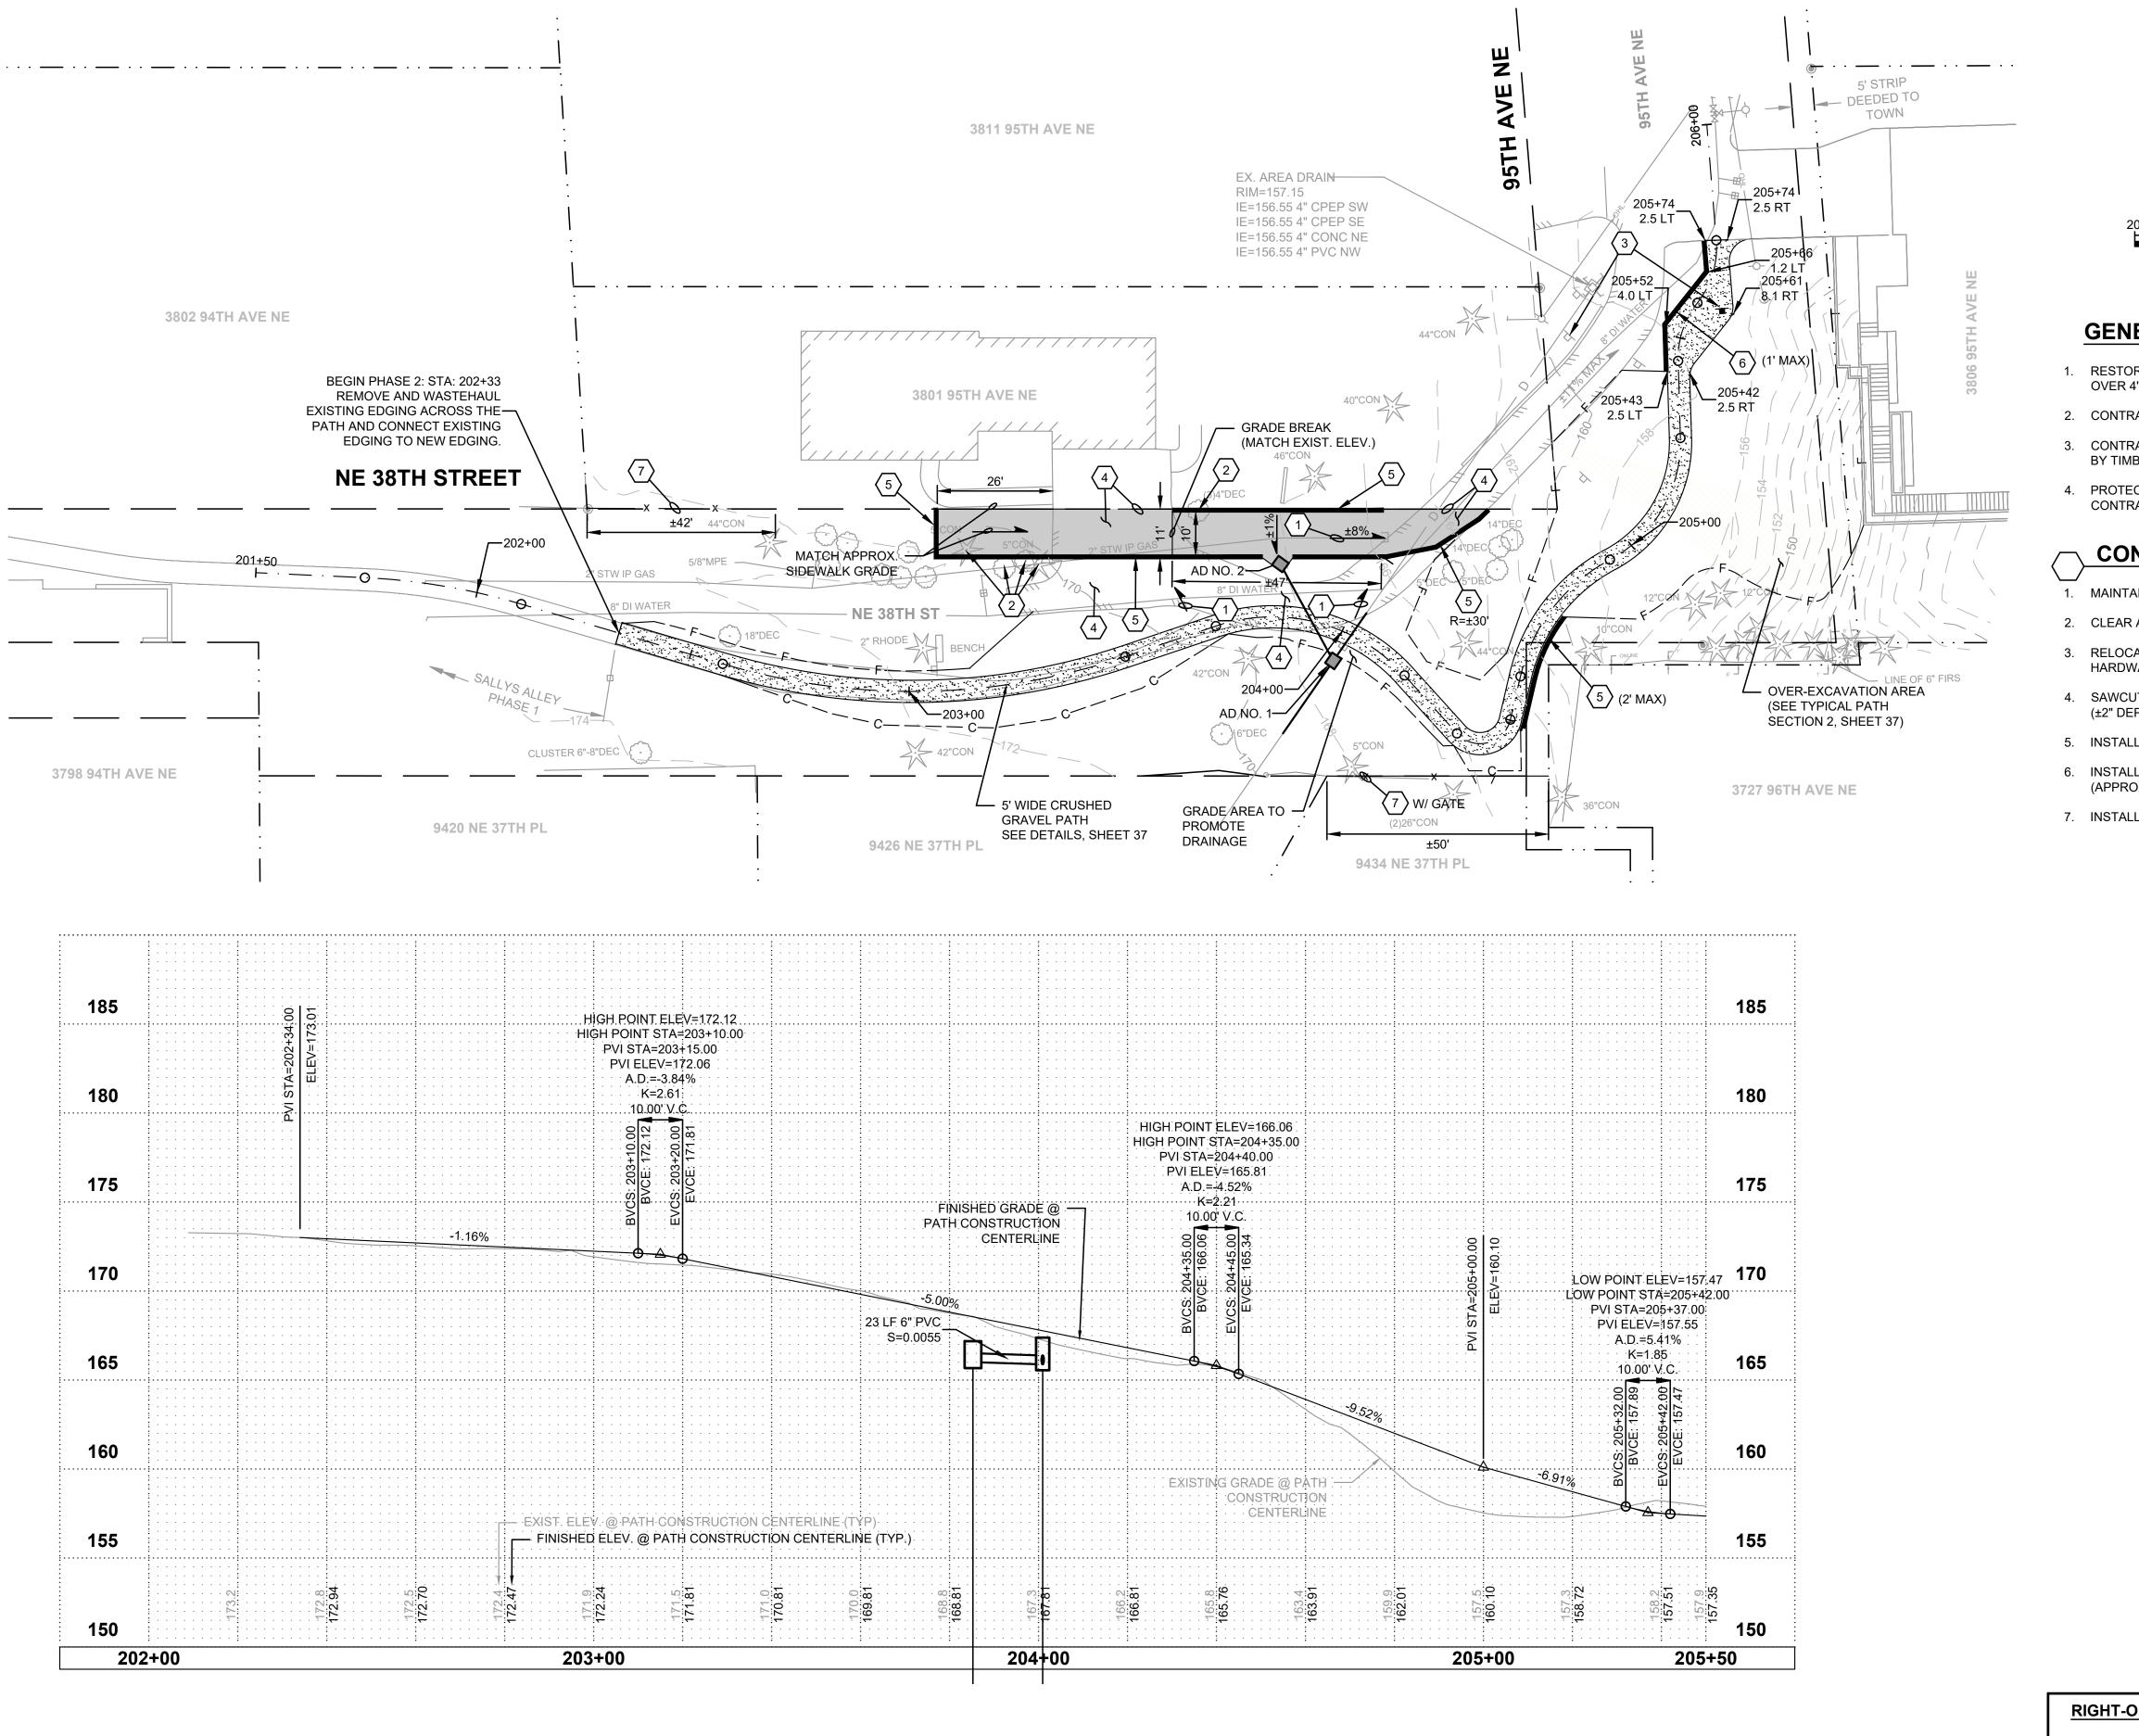

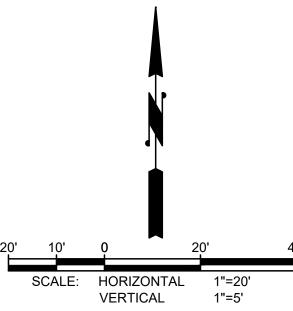

## **GENERAL NOTES**

- 1. RESTORE ALL DISTURBED SURFACES WITH SEEDING, FERTILIZING AND MULCHING OVER 4" SUITABLE NATIVE MATERIAL.
- 2. CONTRACTOR SHALL MAINTAIN ACCESS 3801 95TH AVE NE AT ALL TIMES.
- 3. CONTRACTOR SHALL <u>NOT</u> INSTALL STEEL EDGING WHERE THE TRAIL IS BORDERED BY TIMBER EDGING.
- 4. PROTECT ALL TREES EXCEPT AS NOTED. CONTRACTOR SHALL NOTIFY CONTRACTING AGENCY PRIOR TO CUTTING ROOTS GREATER THAN 2" IN DIAMETER

## CONSTRUCTION NOTES

- 1. MAINTAIN CONSTANT GRADE.
- 2. CLEAR AND GRUB EXSITING TREE.
- 3. RELOCATE EXIST. SIGN. FURNISH AND INSTALL NEW POST, FOUNDATION AND HARDWARE IN-KIND. WASTEHAUL EXISTING POST AND FOUNDATION.
- 4. SAWCUT AND REMOVE AND WASTEHAUL THE EXISTING ASPHALT (±2" DEPTH).
- 5. INSTALL SINGLE TIMBER EDGING AT LIMITS OF ASPHALT. SEE DETAIL, SHEET 37,
- 6. INSTALL STACKED TIMBER EDGING PER DETAIL, SHEET 37. (APPROX. HEIGHT NOTED.)
- 7. INSTALL 6' WOOD FENCE PER DETAIL, SHEET 38.



3710 168TH STREET NORTHEAST BUILDING B, SUITE 210 ARLINGTON, WA 98223 (360) 454-5490







TOWN OF YARROW POINT

TOWN WIDE STORMWATER AND UGC PROJECT

No.	DATE	REVISION
SSUE	D FOR:	
		BID PLAN SET
SSUE	DATE:	JAN 2024
PPR	OVED BY:	KWB

TWO INCHES AT FULL SCALE.
IF NOT, SCALE ACCORDINGLY

KWB

CJB

CJB

23445

STORM P&P.DWG

CHECKED BY:

DRAWN BY:

DESIGNER:

G & O JOB NO.:

CIVIL

BURIED UTILITIES IN AREA
CALL BEFORE YOU DIG
1-800-424-5555
EXISTING UTILITIES SHOWN ARE FROM THE
BEST AVAILABLE INFORMATION AND NO
GUARANTEE IS MADE AS TO THE EXACT SIZE,

## RIGHT-OF-WAY DISCLAIMER

THE RIGHT-OF-WAY AND/OR
PROPERTY LINES SHOWN HEREON
ARE BASED ON AVAILABLE
INFORMATION, NOT ON A SURVEYED
LOCATION AND ARE ONLY
APPROXIMATE.

## APPROVAL FOR CONSTRUCTION

TYPE, LOCATION OR DEPTH


BY: TOWN OF YARROW POINT

DATE: JANUARY 2024

APPROVAL EXPIRES: JANUARY 2025

BID ADDITIVE - SALLYS
ALLEY PHASE 2
PLAN & PROFILE

DRAWING: **36** OF: **40** 

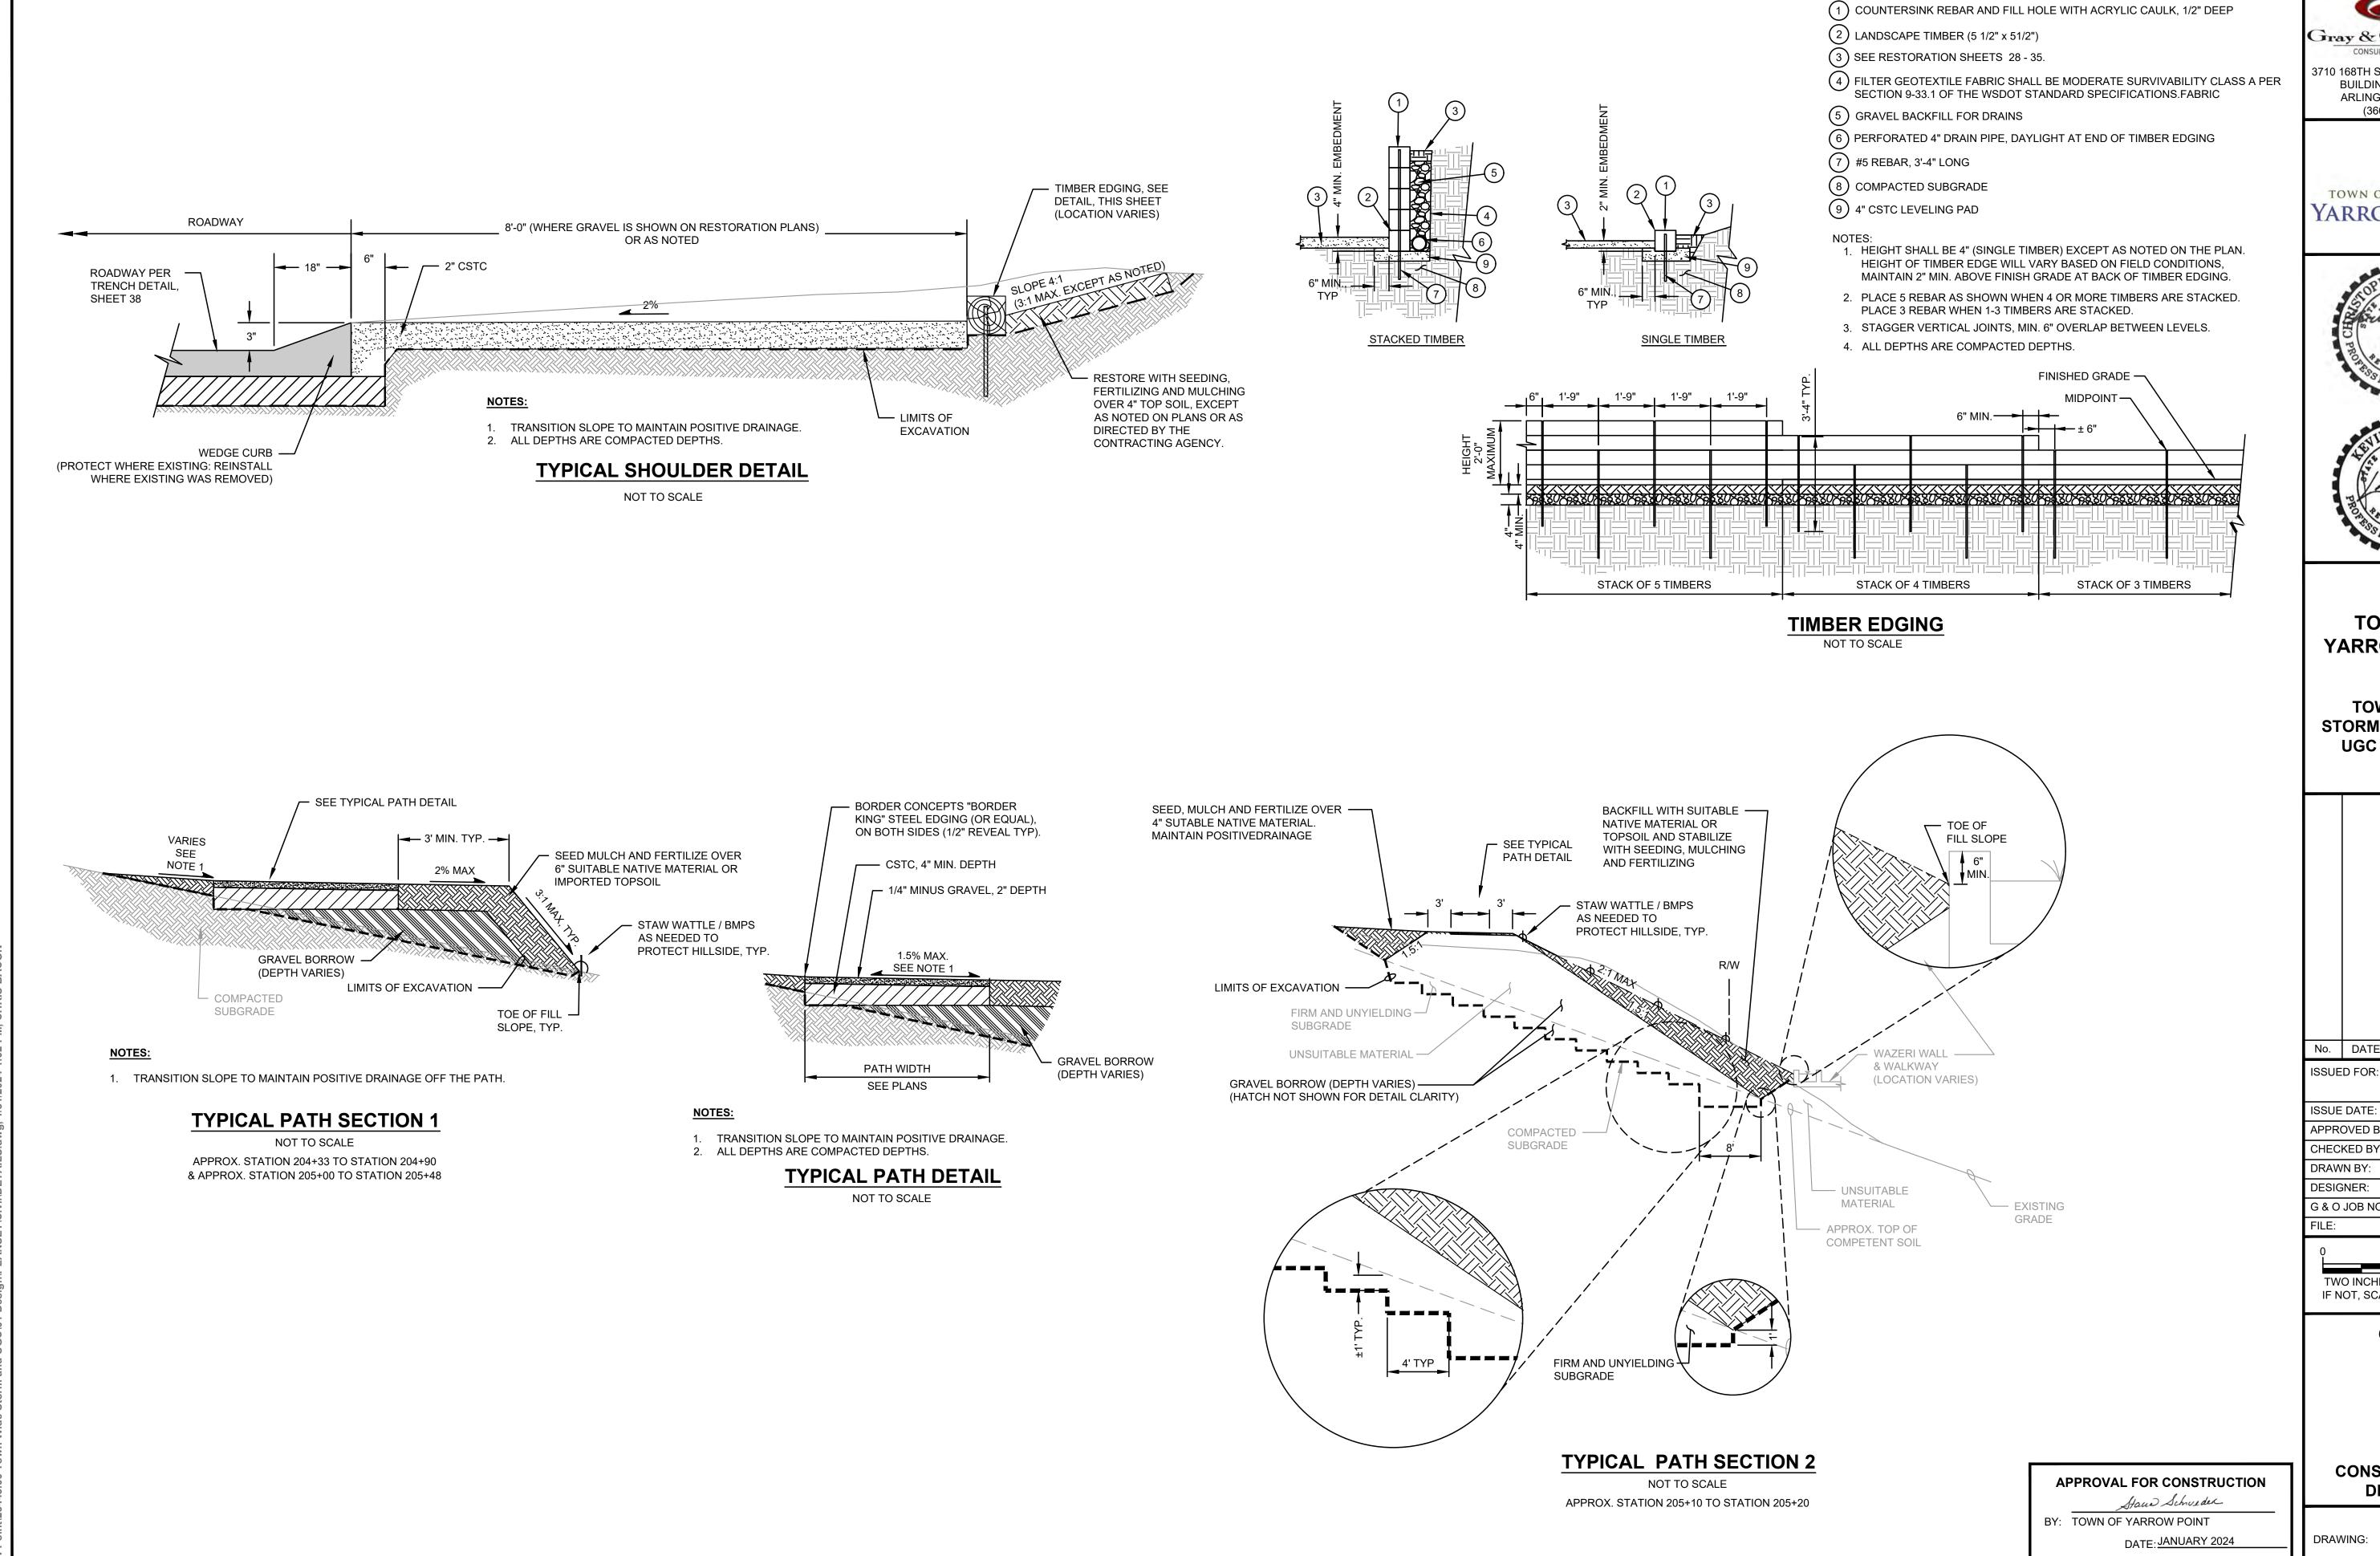


Gray & Osborne, Inc.

3710 168TH STREET NORTHEAST, BUILDING B, SUITE 210 ARLINGTON, WA 98223 (360) 454-5490





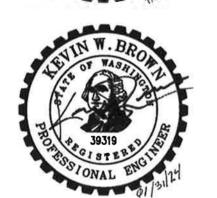

TOWN OF YARROW POINT

TOWN WIDE
STORMWATER AND
UGC PROJECT

No. DATE REVISION

ISSUED FOR:

BID PLAN SET

APPROVED BY: KWB

CHECKED BY: KWB

DRAWN BY: CJB

DESIGNER: CJB

G & O JOB NO.: 23445

FILE: DETAILS.DWG


TWO INCHES AT FULL SCALE.
IF NOT, SCALE ACCORDINGLY


CIVIL

CONSTRUCTION DETAILS

DRAWING: **37** OF: **40** 

APPROVAL EXPIRES: <u>JANUARY 2025</u>

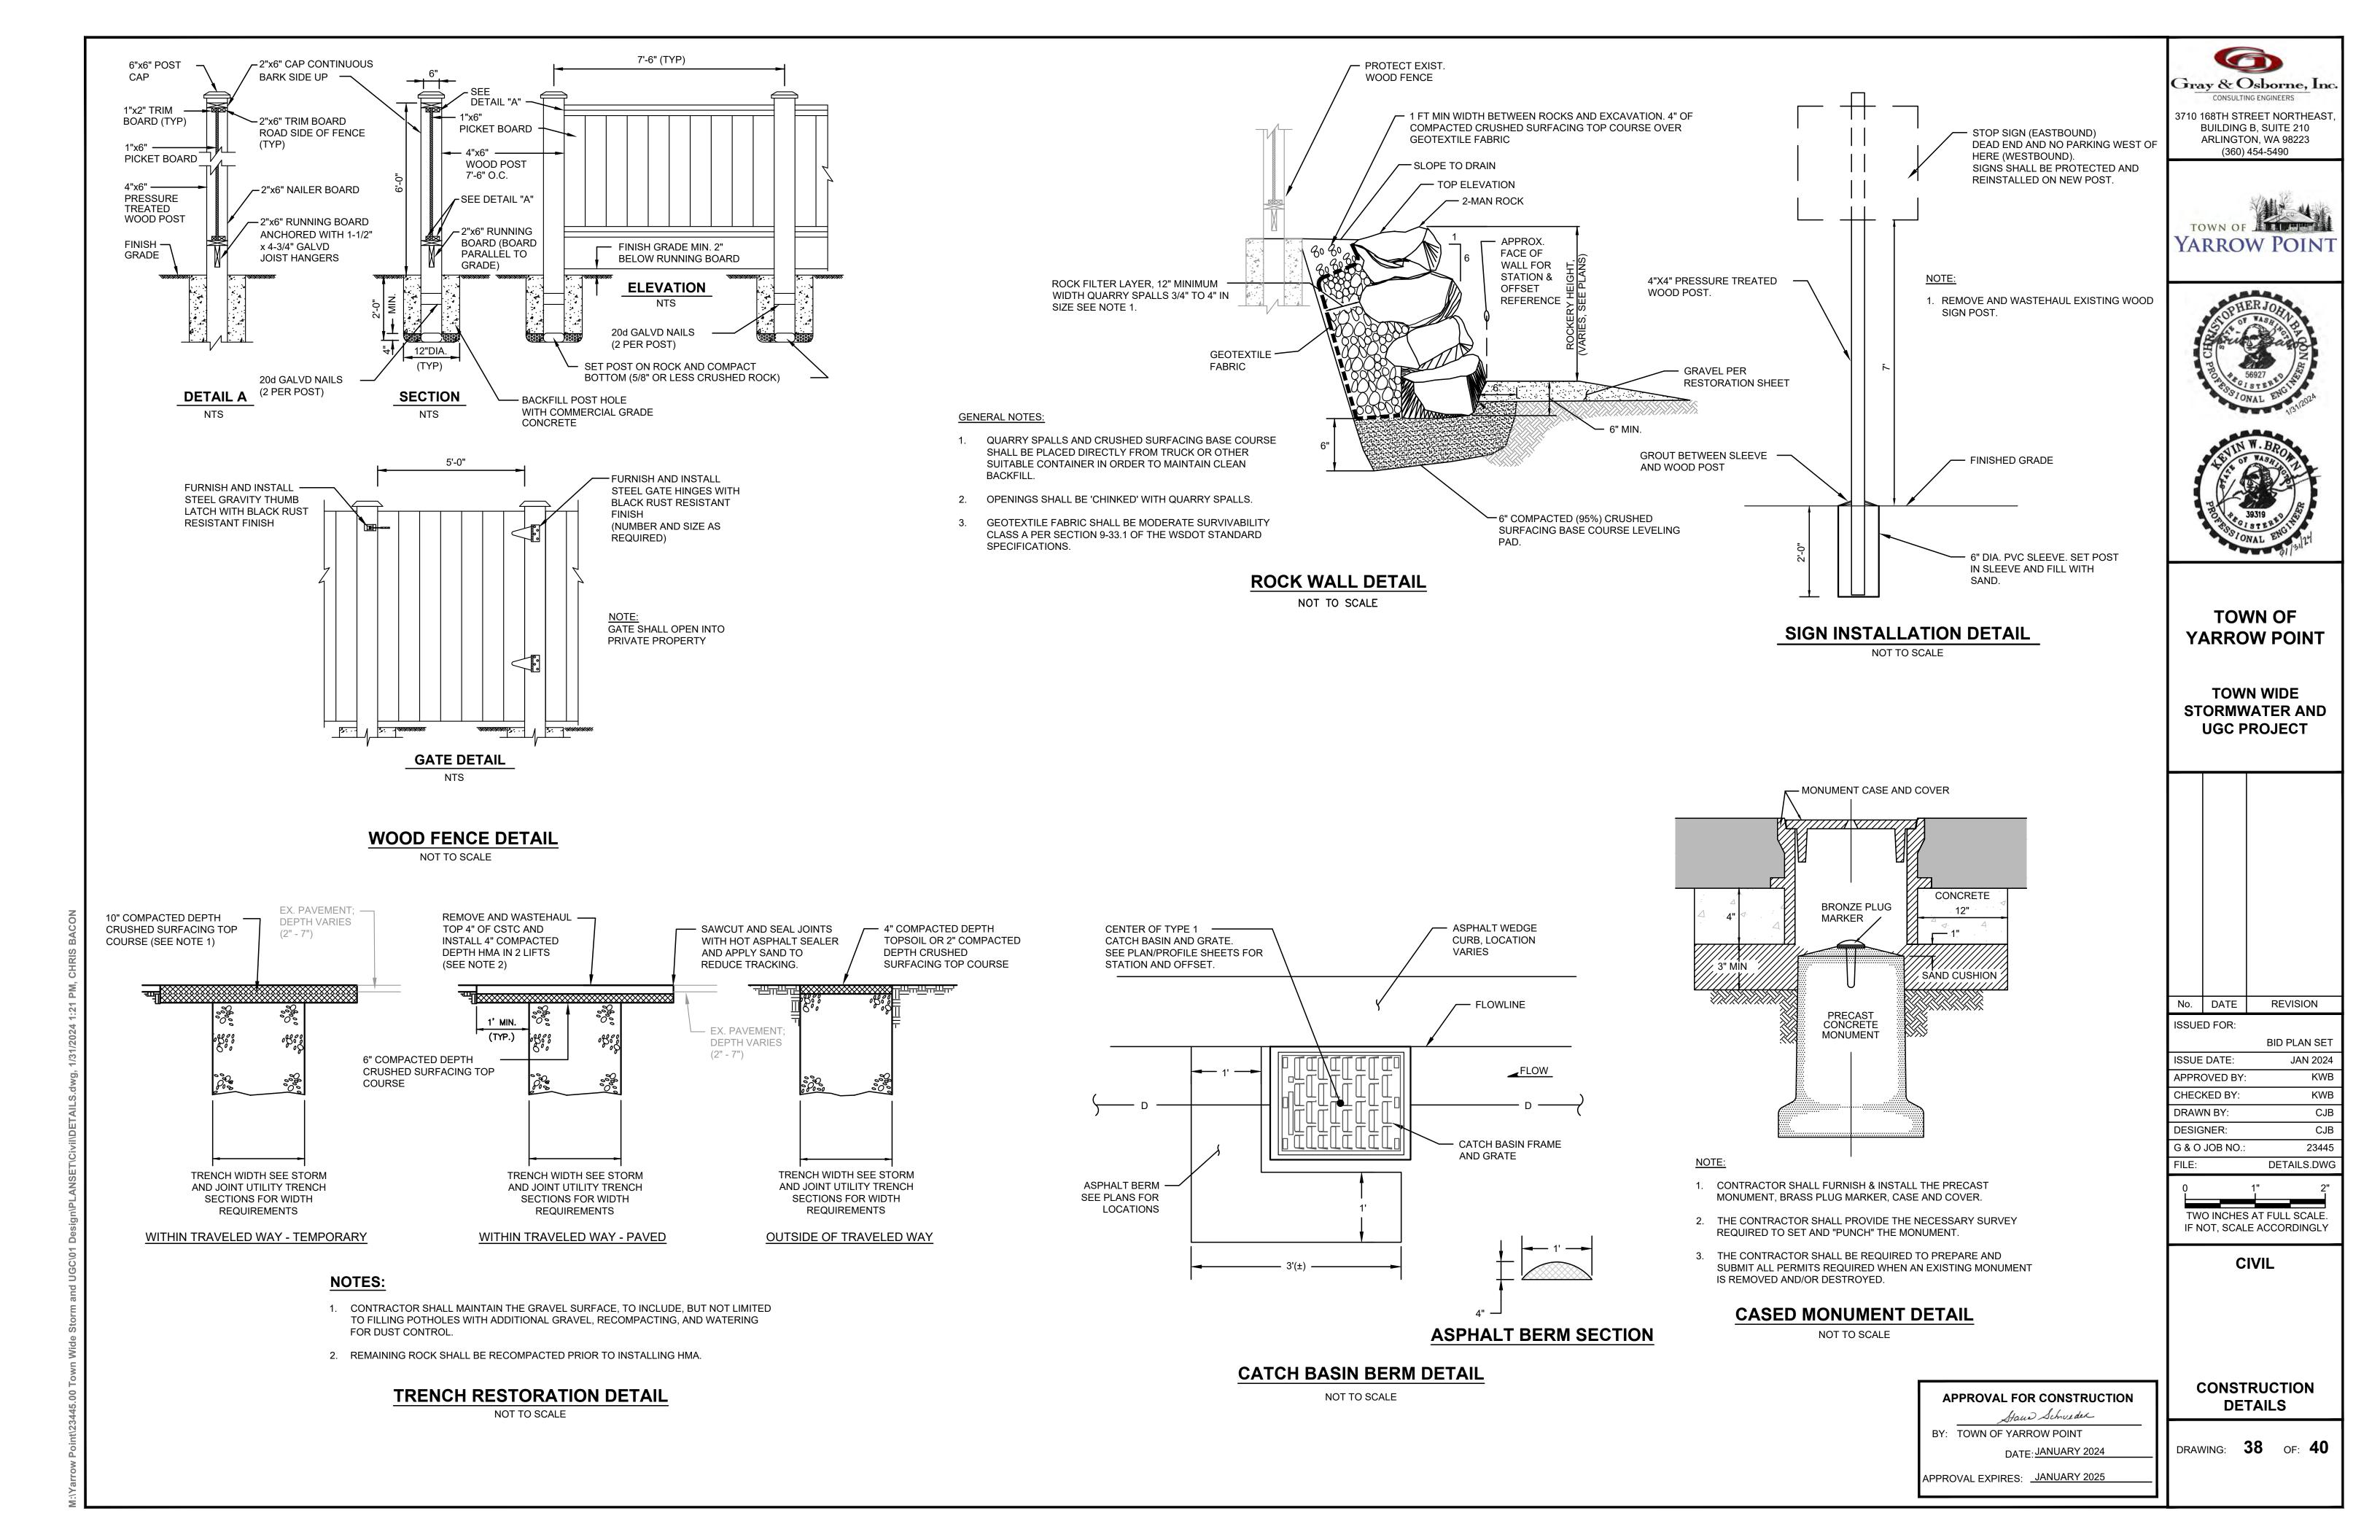

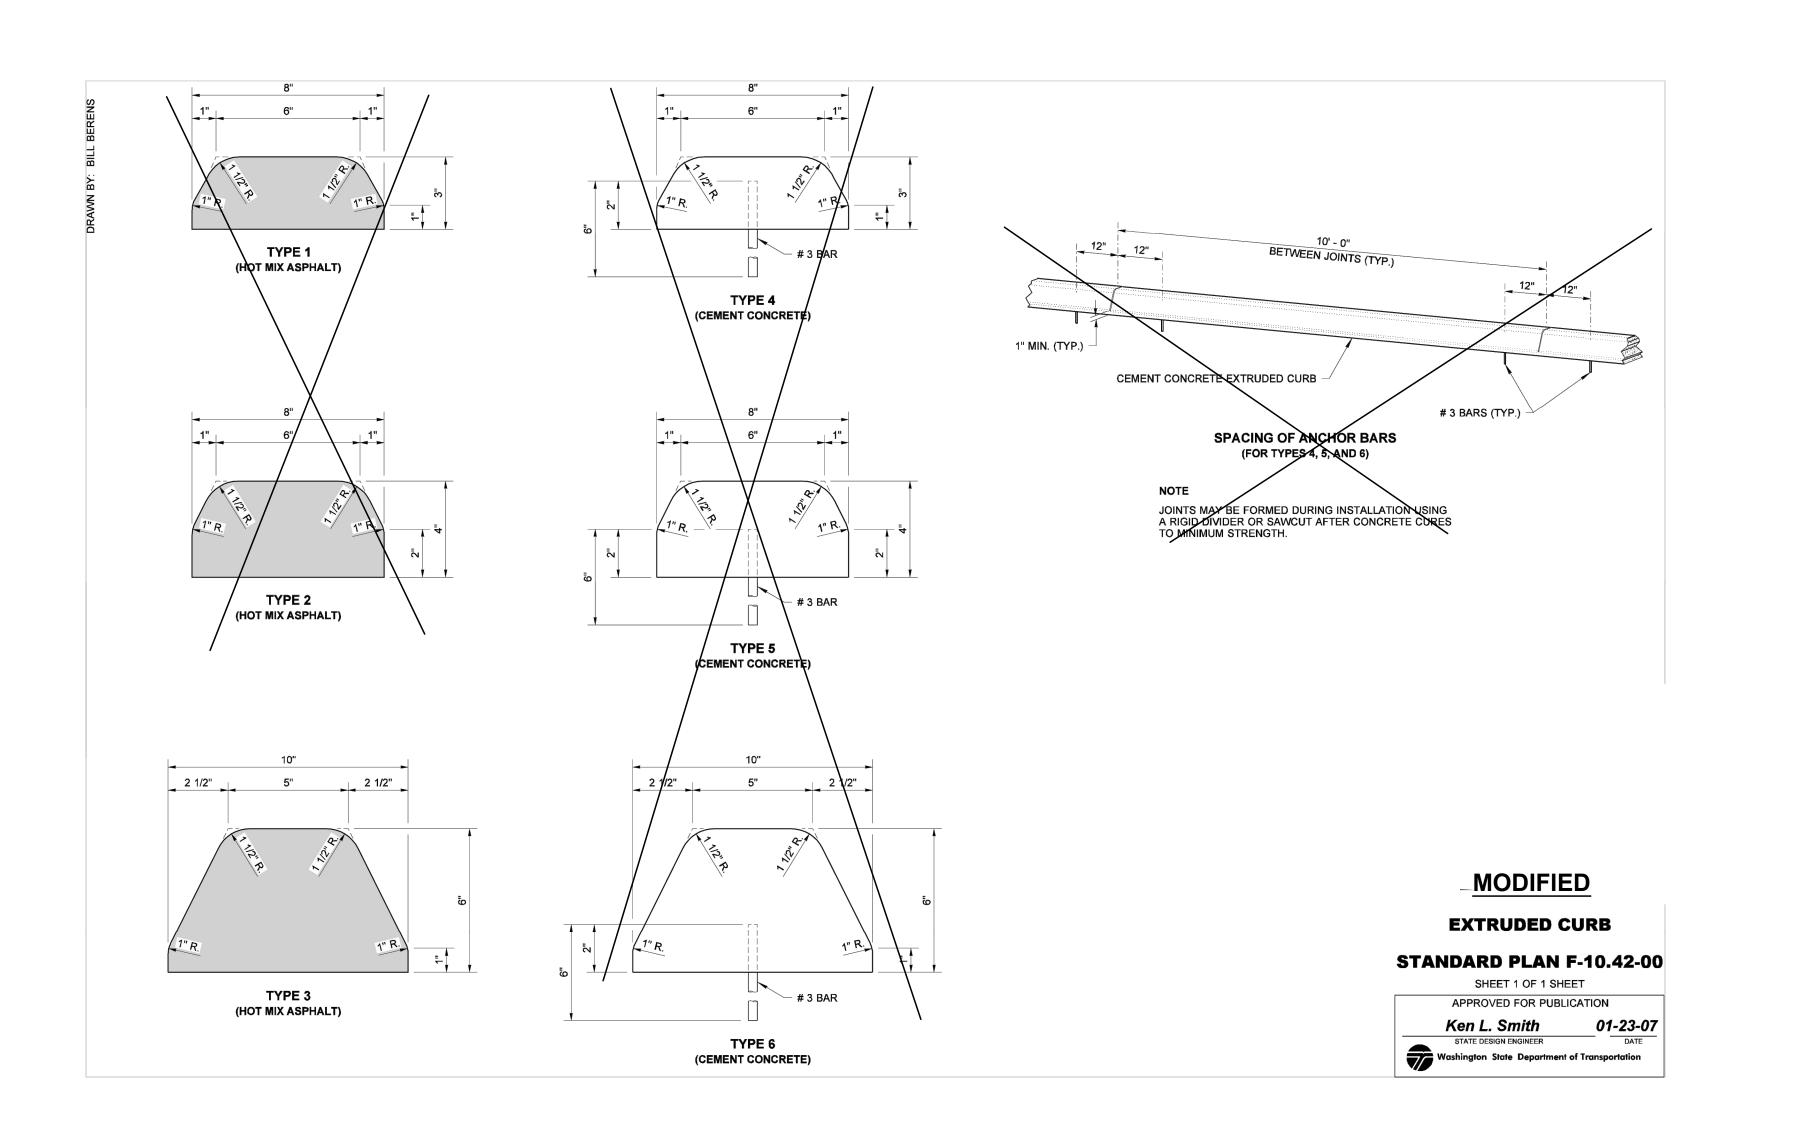



3710 168TH STREET NORTHEAST, BUILDING B, SUITE 210 ARLINGTON, WA 98223 (360) 454-5490







## TOWN OF YARROW POINT

TOWN WIDE
STORMWATER AND
UGC PROJECT

No.	DATE	REVISION

INO.	DATE	INEVISION
ISSUE	D FOR:	
		BID PLAN SET
ISSUE	DATE:	JAN 2024
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	NI DV:	CIB

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DESIGNE	R:		CJ	I
G & O JOE	3 NO.:		2344	ļ
FILE:		DET	AILS.DW	/
o O	1,"		2	"

IF NOT, SCALE ACCORDINGLY

TWO INCHES AT FULL SCALE.

CIVIL

CONSTRUCTION DETAILS

drawing: 39 of: 40

APPROVAL EXPIRES: JANUARY 2025


BY: TOWN OF YARROW POINT

APPROVAL FOR CONSTRUCTION

Stand Schweder

DATE: JANUARY 2024

arrow Point\23445.00 Town Wide Storm and UGC\01 Design\PLANSET\Civi\\DETAILS.dwg, 1/31/2024 10:30 AM, CHRIS BACON

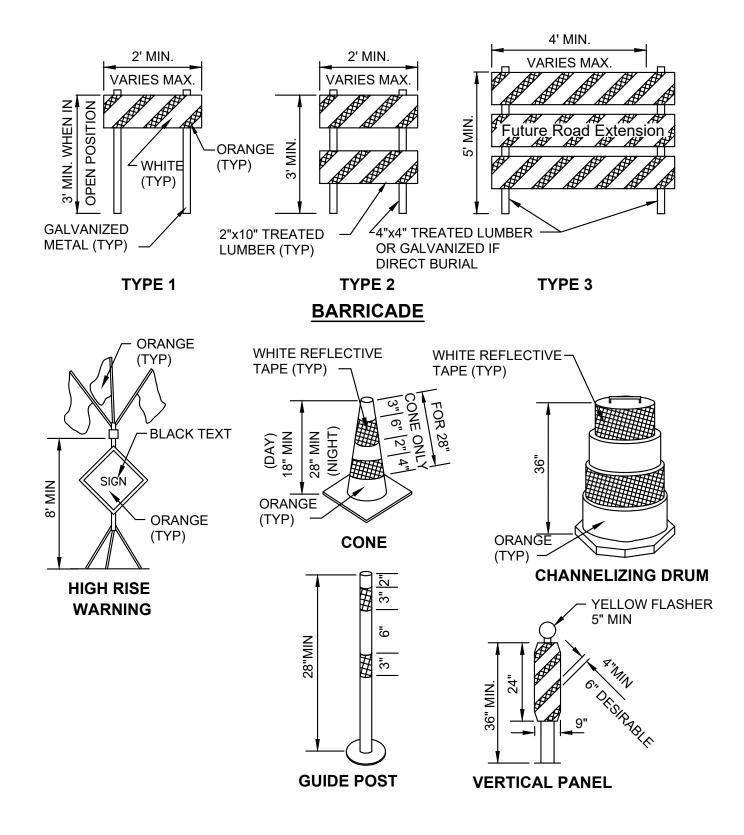

## TRAFFIC CONTROL DEVICES


## **GENERAL TRAFFIC CONTROL NOTES**

- 1. CONTRACTOR SHALL BE RESPONSIBLE FOR ALL TRAFFIC CONTROL, IN ACCORDANCE WITH MUTCD AND PRIOR TO DISRUPTION OF ANY TRAFFIC, TRAFFIC CONTROL PLANS SHALL BE PREPARED AND SUBMITTED TO THE CONTRACTING AGENCY FOR APPROVAL. NO WORK THAT DISRUPTS TRAFFIC SHALL COMMENCE UNTIL ALL APPROVED TRAFFIC CONTROL IS IN PLACE.
- 2. APPROPRIATE METHODS OF PEDESTRIAN AND VEHICULAR TRAFFIC CONTROL, INCLUDING FLAGGERS, SHALL BE EMPLOYED BY THE CONTRACTOR TO THE EXTENT DEEMED NECESSARY BY THE TRAFFIC CONTROL SUPERVISOR AND AS REQUIRED BY THE CONTRACTING AGENCY TO PROTECT WORKERS OR THIRD PARTIES.
- 3. CONTRACTOR SHALL MAINTAIN ACCESS AT ALL TIMES TO EACH BUSINESS/RESIDENCE. PEDESTRIAN ROUTES INCLUDING NECESSARY SIGNAGE AND DELINEATION SHALL BE NOTED ON DETAILED TRAFFIC CONTROL PLANS PREPARED BY CONTRACTOR.
- 4. CONTRACTOR SHALL COORDINATE ACCESS FOR SERVICES INCLUDING, BUT NOT LIMITED TO, MAIL DELIVERY, TRASH PICKUP, BUSINESS DELIVERIES/PICKUPS AND ANY SPECIAL TRANSPORTATION SERVICES. CONTRACTOR SHALL COORDINATE WITH BUSINESSES TO ENSURE ALL DELIVERIES AND GARBAGE PICK-UP IS MAINTAINED THROUGHOUT THE DURATION OF CONSTRUCTION.
- THE CONTRACTOR AND/OR HIS AGENTS SHALL NOT PARK IN ANY BUSINESS PARKING LOTS WITHOUT WRITTEN PERMISSION FROM THE PROPERTY OWNER.
- 6. THE CONTRACTOR SHALL MAINTAIN MIN. 10' WIDE DRIVEWAY ACCESS TO ALL PROPERTIES UNLESS APPROVED OTHERWISE. THE CONTRACTOR SHALL COORDINATE ALL TEMPORARY CLOSURES WITH THE CONTRACTING AGENCY AND AFFECTED PROPERTY/BUSINESS OWNER PRIOR TO IMPLEMENTING CLOSURE.
- 7. CONTRACTOR SHALL COVER OPEN TRENCHES WITH STEEL PLATES DURING NON-WORKING HOURS AS REQUIRED AND/OR DIRECTED.



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TOWN OF YARROW POINT

TOWN WIDE
STORMWATER AND
UGC PROJECT

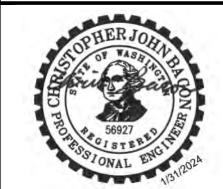No. DATE REVISION

ISSUED FOR:
BID PLAN SET

ISSUE DATE: JAN 2024

APPROVED BY: KWB

TWO INCHES AT FULL SCALE.
IF NOT, SCALE ACCORDINGLY

KWB

CJB

CJB

23445

DETAILS.DWG

CIVIL

CHECKED BY:

DRAWN BY:

DESIGNER:

G & O JOB NO.:

CONSTRUCTION DETAILS

DRAWING: 40 OF: 40

APPROVAL FOR CONSTRUCTION

DATE: JANUARY 2024

APPROVAL EXPIRES: <u>JANUARY 2025</u>

BY: TOWN OF YARROW POINT

## 94TH AVE NE YARROW POINT SCHEDULE 74 OH TO UG CONVERSION

## **GENERAL SPECIFICATIONS**

## Scope of Work

OH TO UG CONVERSION ALONG 94TH AVE NE IN YARROW POINT. REMOVE/REPLACE STORM SYSTEM.

### General

- All work is to be completed per PSE Standards & Practices. Copies of all PSE Standards are available upon request.
- Work sites shall be kept clear of debris and all construction materials; equipment and packing shall be removed daily.
- Return all unused and removed poles, transformers and hardware to PSE, storeroom. All copper shall be coiled and returned the day it is removed from the poles. Remove all unused pins and insulators.
- Return all streetlights, area lights and floodlights to Sumner yard.

## Preconstruction

- Notify appropriate city, County or DOT authorities 48 to 72 hours, or as required by permitting agency, in advance of starting work in Right-of-way involving a Permit.
- All system switching shall be approved by **System Operations (425-882-4652)** a minimum of 48 hours in advance.
- Notify customers of all outages 48 hours in advance.

## Work Drawings & Documents

- Field design changes shall be approved by PSE Project Manager or Engineer.
- Mark all field changes, equipment ID numbers and Underground cable information in red on Foreman's copy of worksketch.
- Return one Foreman's copy of worksketch to Project Manager at completion of job.
- When permits are required, a copy shall be available on work site at all times.

## Safety

- Refer to PSE standards 6275.3000 and 6275.6000 for system ground requirements.
- Refer to PSE standards 6275.9050 for personal protective grounding requirements.
- Refer to PSE standards 6275.9150 for vehicle grounding and barricading requirements.
- Proper line clearances shall be taken at the beginning, and released at the end, of each work day, or as otherwise instructed by the System Operator.
- Provide signs, barricades, and traffic control in conformance with permit regulations.
- Utilize flagging and other vehicle traffic control as necessary and in conformance with local traffic regulations.
- Maintain traffic flow as required by permitting agency.

## **Erosion & Sediment Control**

- Refer to PSE standards 0150.3200 for minimum requirements.
- Comply with all requirements of permitting agency.
- Installed erosion & sediment devices shall be maintained until vegetation has been re-established or disturbed soil has been otherwise permanently stabilized.

## **Joint Facilities**

- Coordinate with Communication Companies for transfers.

## OVERHEAD CONSTRUCTION

## Poles & Structures

- Poles are to be installed or relocated as staked. Unless otherwise noted, all pole location measurements are from the <u>center of the pole</u>.
- All new poles set shall be the class indicated on the sketch, or better. Do not set a lower class pole than specified.
- Install ground plate assembly on all new poles. Install Switch Ground Assembly per standard specification 6014.1000 at new gang operated switch locations.
- Install grid numbers on all new and REMOVE poles as shown on sketch.
- Straighten REMOVE poles as indicated or as necessary.
- Treat all field-drilled poles with copper napthenate wood preservative.
- Remove old poles after communication companies have transferred off and return to PSE storeroom. Fill and crown pole holes and restore area similar to adjacent landscaping.

## Conductors & Equipment

- Transfer all overhead and underground primary, secondary and service conductors and guys to new poles set, unless otherwise indicated on this sketch.
- Transfer REMOVE transformers to new poles unless otherwise indicated on this sketch.
- Use stirrups to connect all overhead and underground primary taps, and all transformers. Install at all sites being worked within the scope of the project where they are currently missing.
- Use 397 AAC and Ampact connectors for all bare conductor feeder jumpers and 600 amp switch jumpers. Install tree wire conductor for jumpers on all poles that are double deadended with tree wire.
- Apply grit inhibitor on all Ampact, stirrup, and dead-end connections.
- Connect primary taps and transformers to same phase as REMOVE unless otherwise shown on the drawing.
- All neutral connections to be made with solid compression connectors. Connect all pole grounds to common neutral.
- Use Load-interrupter cutouts (with arc shields) on all primary overhead and underground taps with fused protection <u>above</u> 40T.
- Install Wildlife Protectors on all transformers.

## **UNDERGROUND CONSTRUCTION**

## Excavation

- Trenching outside of the Right-of-way shall be of sufficient depth to provide a minimum of 36" of cover for primary conductors and 24" of cover for secondary conductors.
- Road crossings and all trenches within the Right-of-way shall be of sufficient depth to provide a minimum of 36" of cover for all conductors or as required by the
- All conductors/conduits shall have a minimum of 3" of bed and 3" of clean sand
- No rocks larger than 6" shall be included in backfill.
- Backfill in road crossings and within the Right-of-way shall be compacted to 95% density or as required by the permitting Agency.
- Restore all excavated areas to original condition
- If four or more six inch conduits are installed in a trench, fluidized thermal backfill (FTB) shall be installed around the conduits to a depth of six inches above and to the sides of the conduit, and two inches underneath, per PSE Standard 6790.0140.

## Vaults & Handholes

- Refer to PSE standard 6775.0040 "Vault and Handhole Installation"
- Vaults shall be placed level and 2" above final grade in landscaped areas and flush with final grade when placed in hard surface areas.


  A minimum 6" had of 5/8" or ushed rock shall be placed under all yoults.
- A minimum 6" bed of 5/8" crushed rock shall be placed under all vaults.
- All conduit entrances shall be grouted.

## Conductors & Conduit

- Refer to PSE standard 6800.6000 "PVC Conduit Installation".
- Unless splices are called for, or otherwise noted or approved, conduit risers shall be plumbed directly to road crossing conduits.
- Install insulating caps on all unused primary bushings.
- All "spare" conduits shall be capped at each end.

## **EROSION & SEDIMENT CONTROL REQUIREMENTS**

EROSION & SEDIMENT CONTROL SHALL BE PER PSE STANDARD PRACTICE 0150.3200 TECHNIQUES FOR TEMPORARY EROSION & SEDIMENT CONTROL & ANY ADDITIONAL LOCAL JURISDICTION REQUIREMENTS.
(LOCAL JURISDICTIONS MAY HAVE ADDITIONAL REQUIREMENTS INCLUDING NOTES DETAILING WHERE EROSION OR SEDIMENT CONTROL STRUCTURES ARE TO BE INSTALLED, CROSS SECTION DETAILS OF THE TYPICAL EROSION STRUCTURES, & SPECIAL REQUIREMENTS FOR WORK IN SENSITIVE AREAS.)

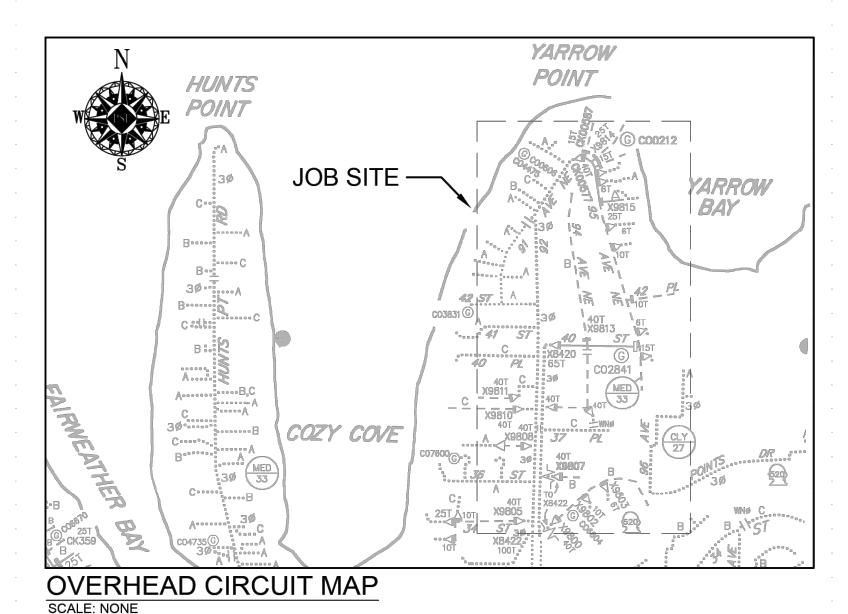


— NEW CONDUCTOR AND OR TRENCH LINE REMOVE CONDUCTOR TO BE REMOVED OR ABANDONED NEW POLE REMOVE POLE **→** OR DISCONNECT - FUSED ---- OR [ DISCONNECT - UNFUSED  $\wedge$ OVERHEAD JUMPER CONNECTION **OVERHEAD TRANSFORMER** D OR ▷ CONDUIT RISER STREET LIGHT DOWN GUY ENERGY CUSTOMER DEMAND POINT PULL VAULT OR SPLICE VAULT J JUNCTION VAULT/JUNCTION BOX  $\triangle$ PADMOUNT TRANSFORMER TOTAL UNDERGROUND TRANSFORMER  $\bigcirc$ SECONDARY HANDHOLE

**LEGEND** 

JOB SITE

UNDERGROUND CIRCUIT MAP SCALE: NONE

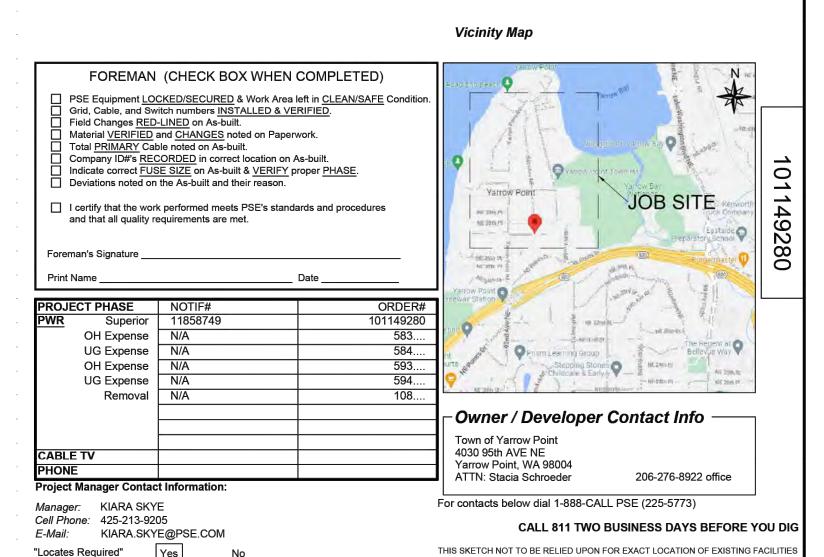

YARROW POINT FUNCTION CONTACT PHONE NO DATE PROJECT MGR KIARA SKYE 425-213-9205 10/13/23 FNGR - POWER KYLE HAYS 206-930-8544 10/13/23 ENGR - GAS RAWN BY HOLLY SOREM 253-208-8843 10/13/23 N/A CSPFEPI HECKED BY Kyle Hays (206) 930-8544 | 10/13/2:

REV# DATE BY DESCRIPTION PPROVED BY /4 SEC OP MAP PLAT MAP S18,19 25 05E FOREMAN #2 -MAP NO (POWER) OH CKT MAP UG CKT MAP CIRCUIT NO A2505E072,73 D2505E076 R2505E072,73 JOINT FACILITIES ARRANGEMENTS UTILITIE N/A CONTAC N/A



'Outages Required"


"Flagging Required"


94TH AVE NE YARROW POINT SCHEDULE 74


4467 94TH AVE NE YARROW POINT, 98004 DRAWING: PSE 1 INCIDENT MAOP
N/A N/A

Gas Order Elect Order
N/A 101149280

SCALE PAGE
AS NOTED 1 / 18

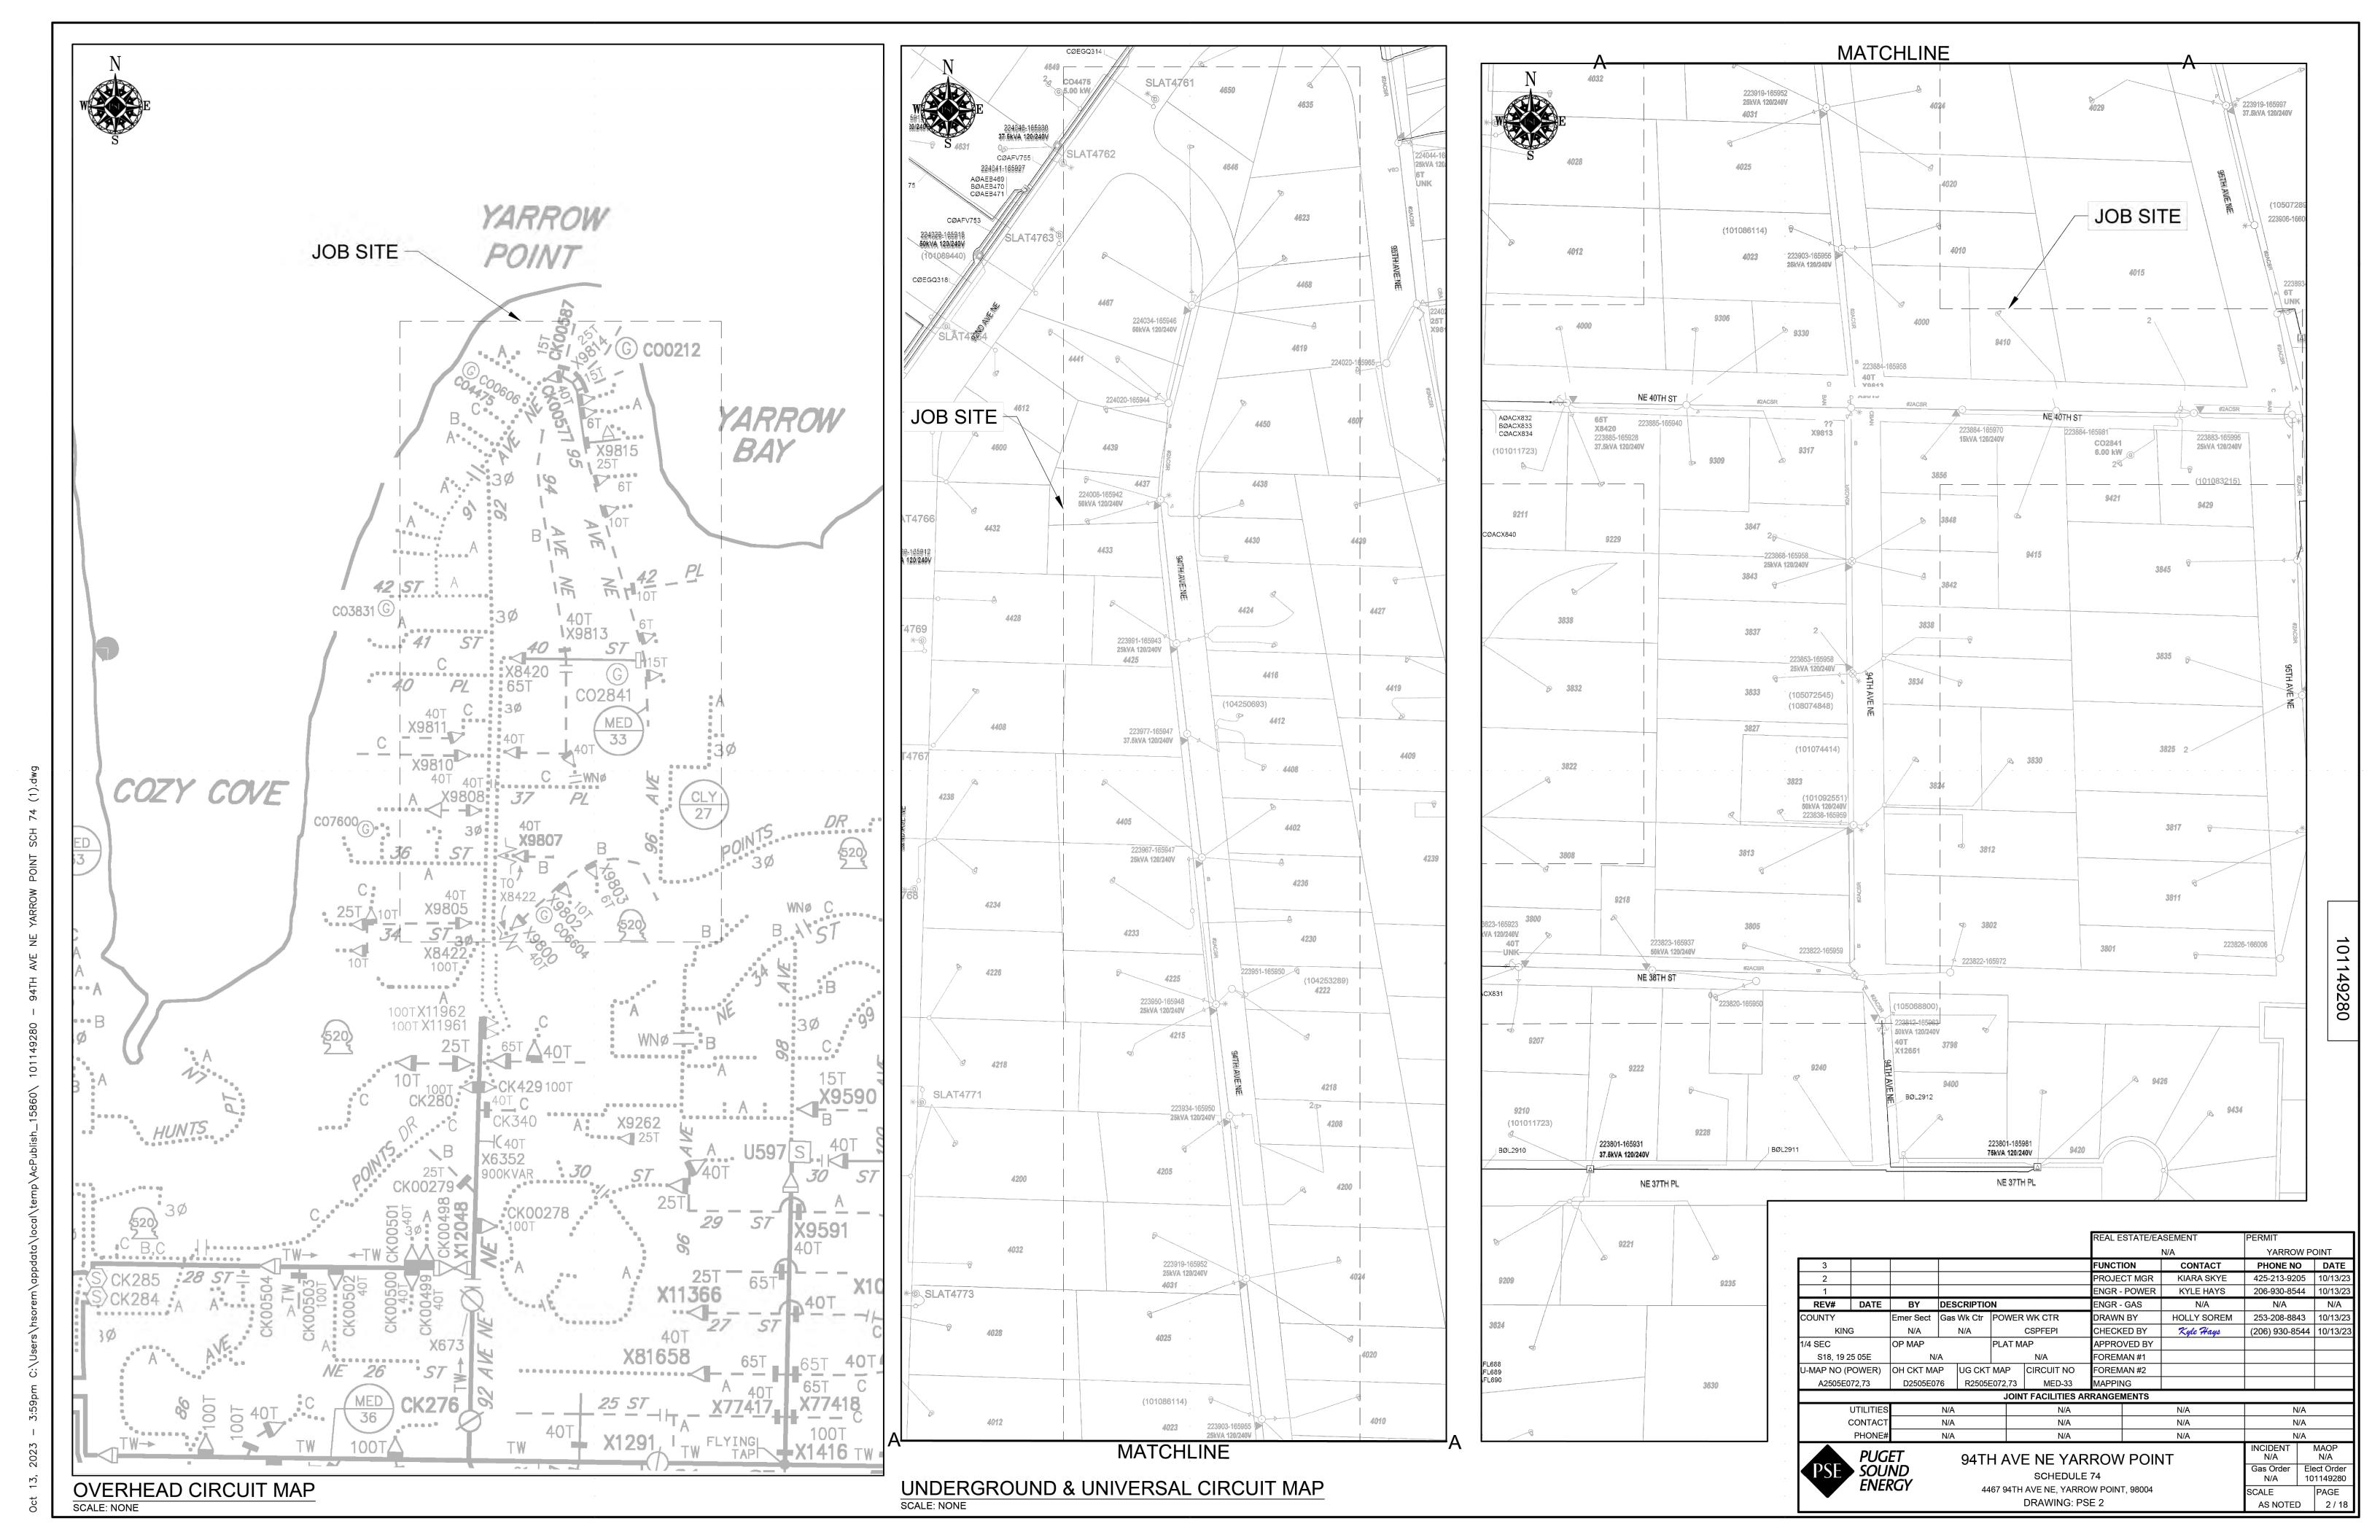

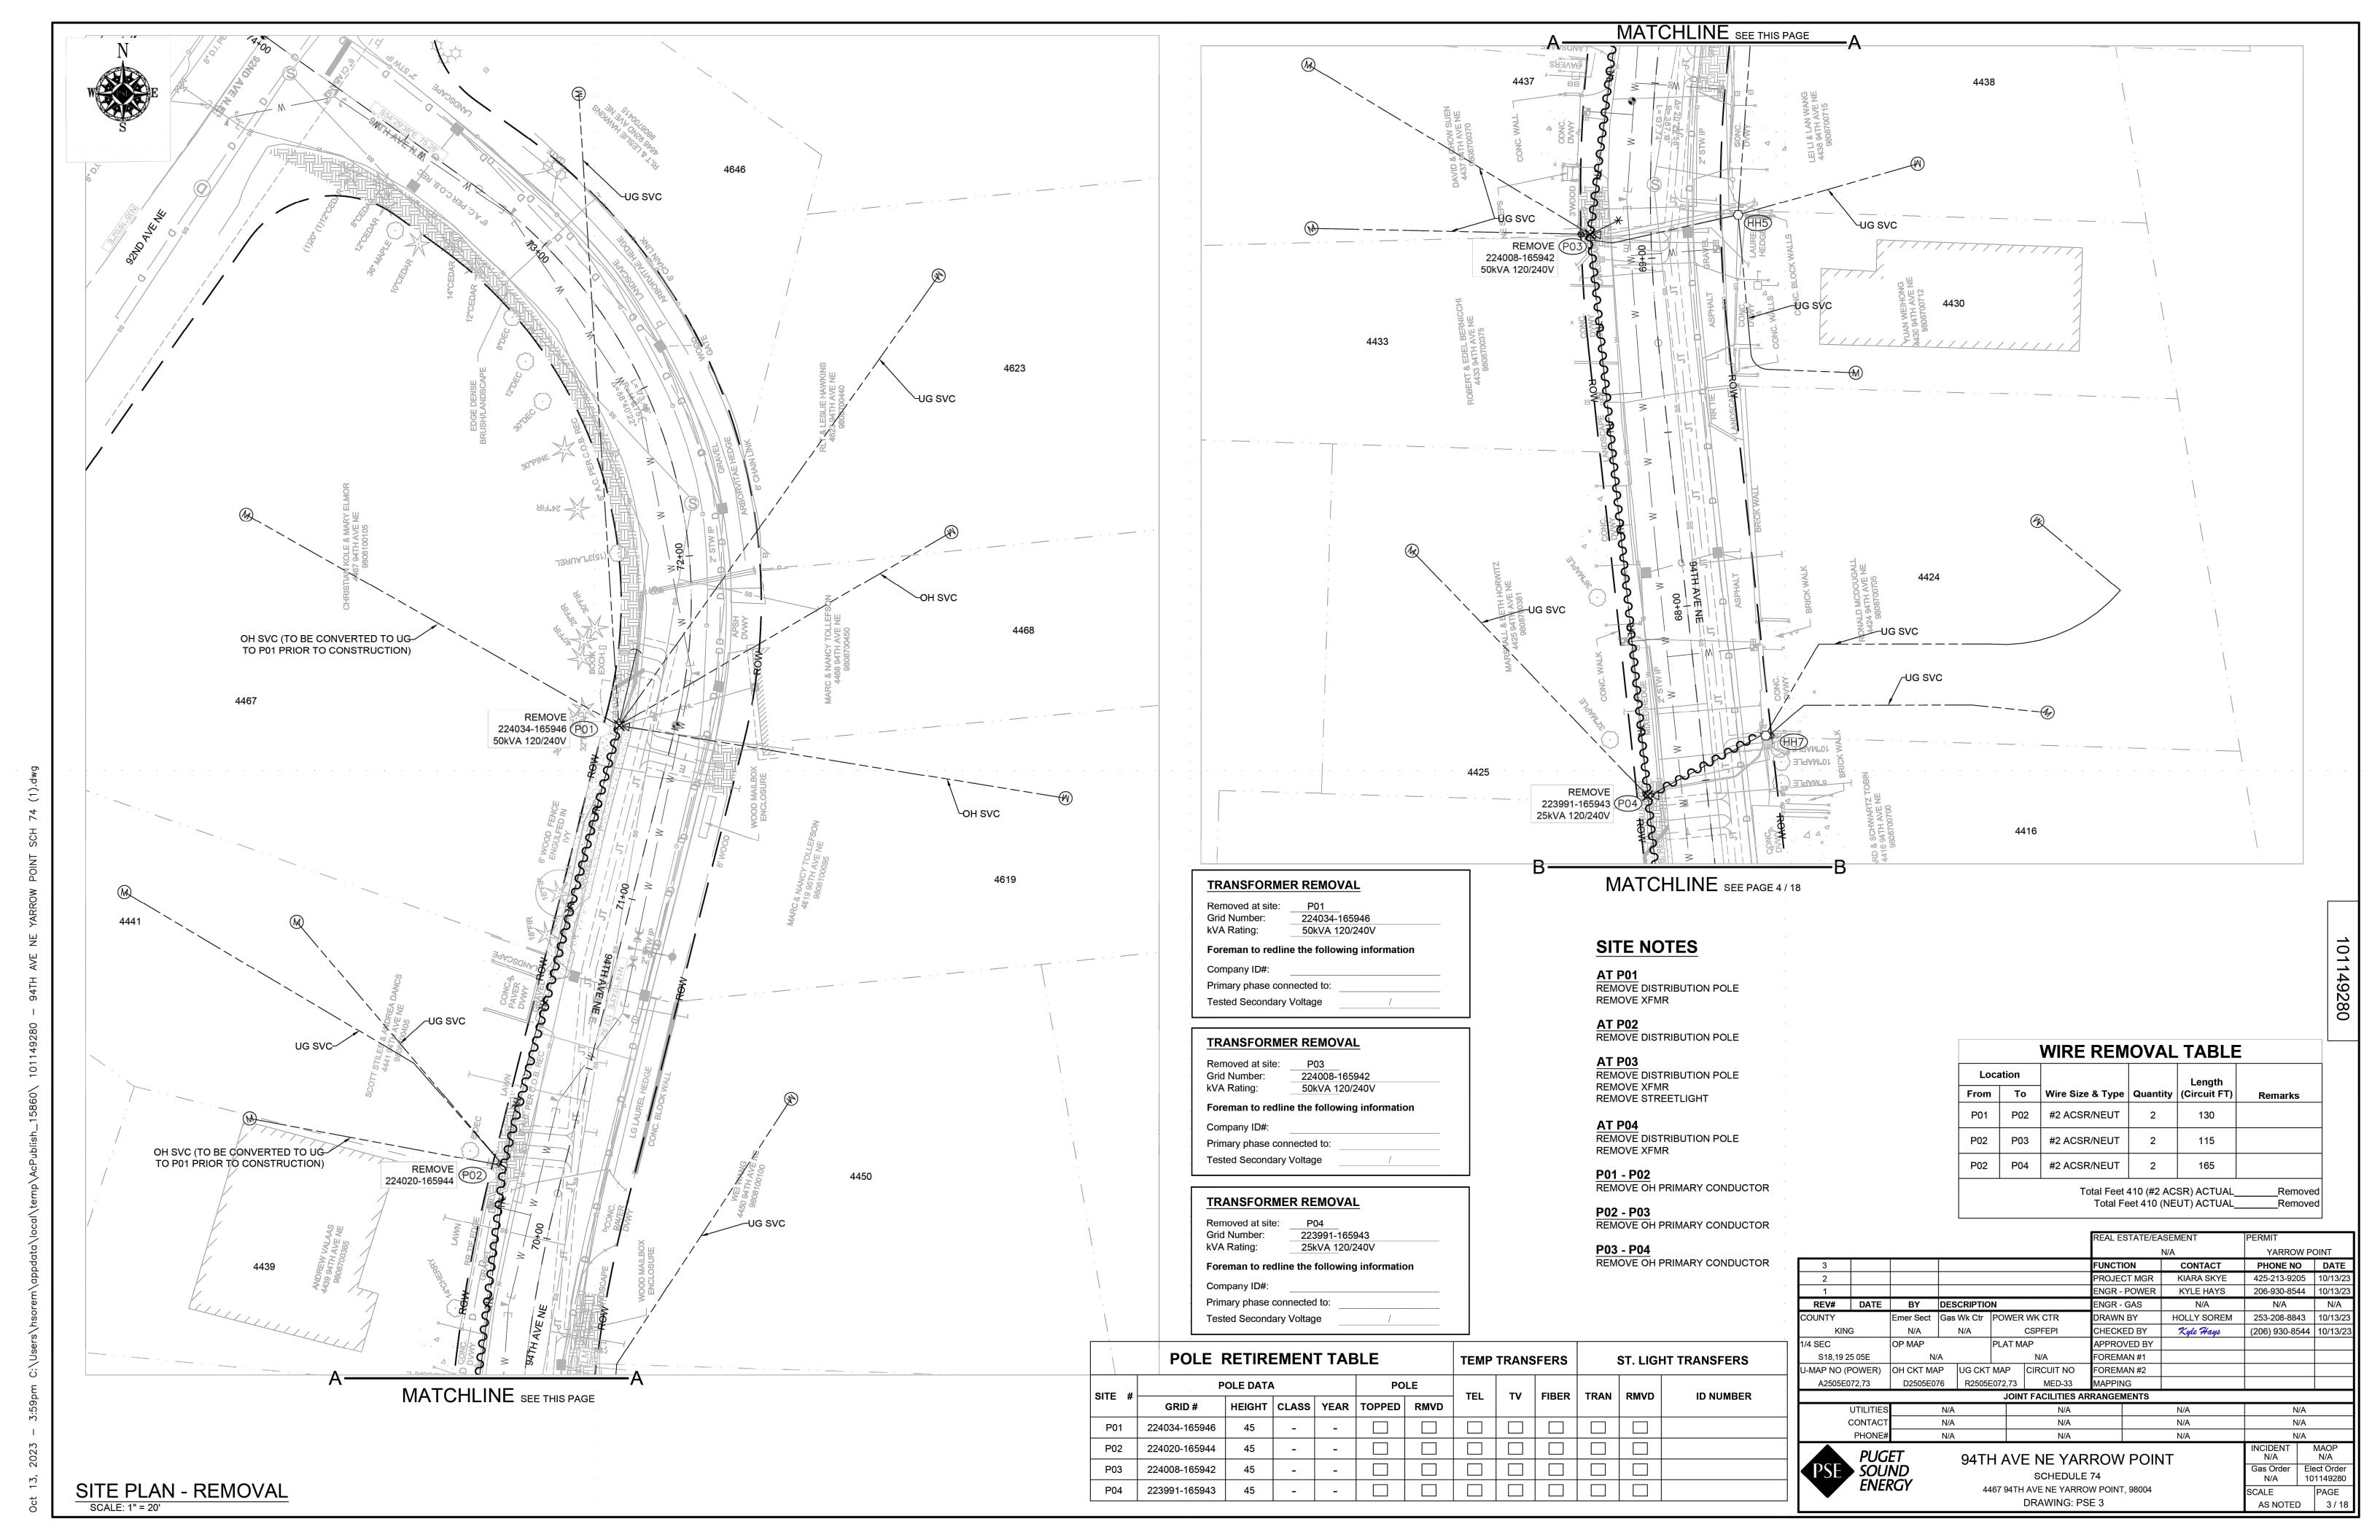

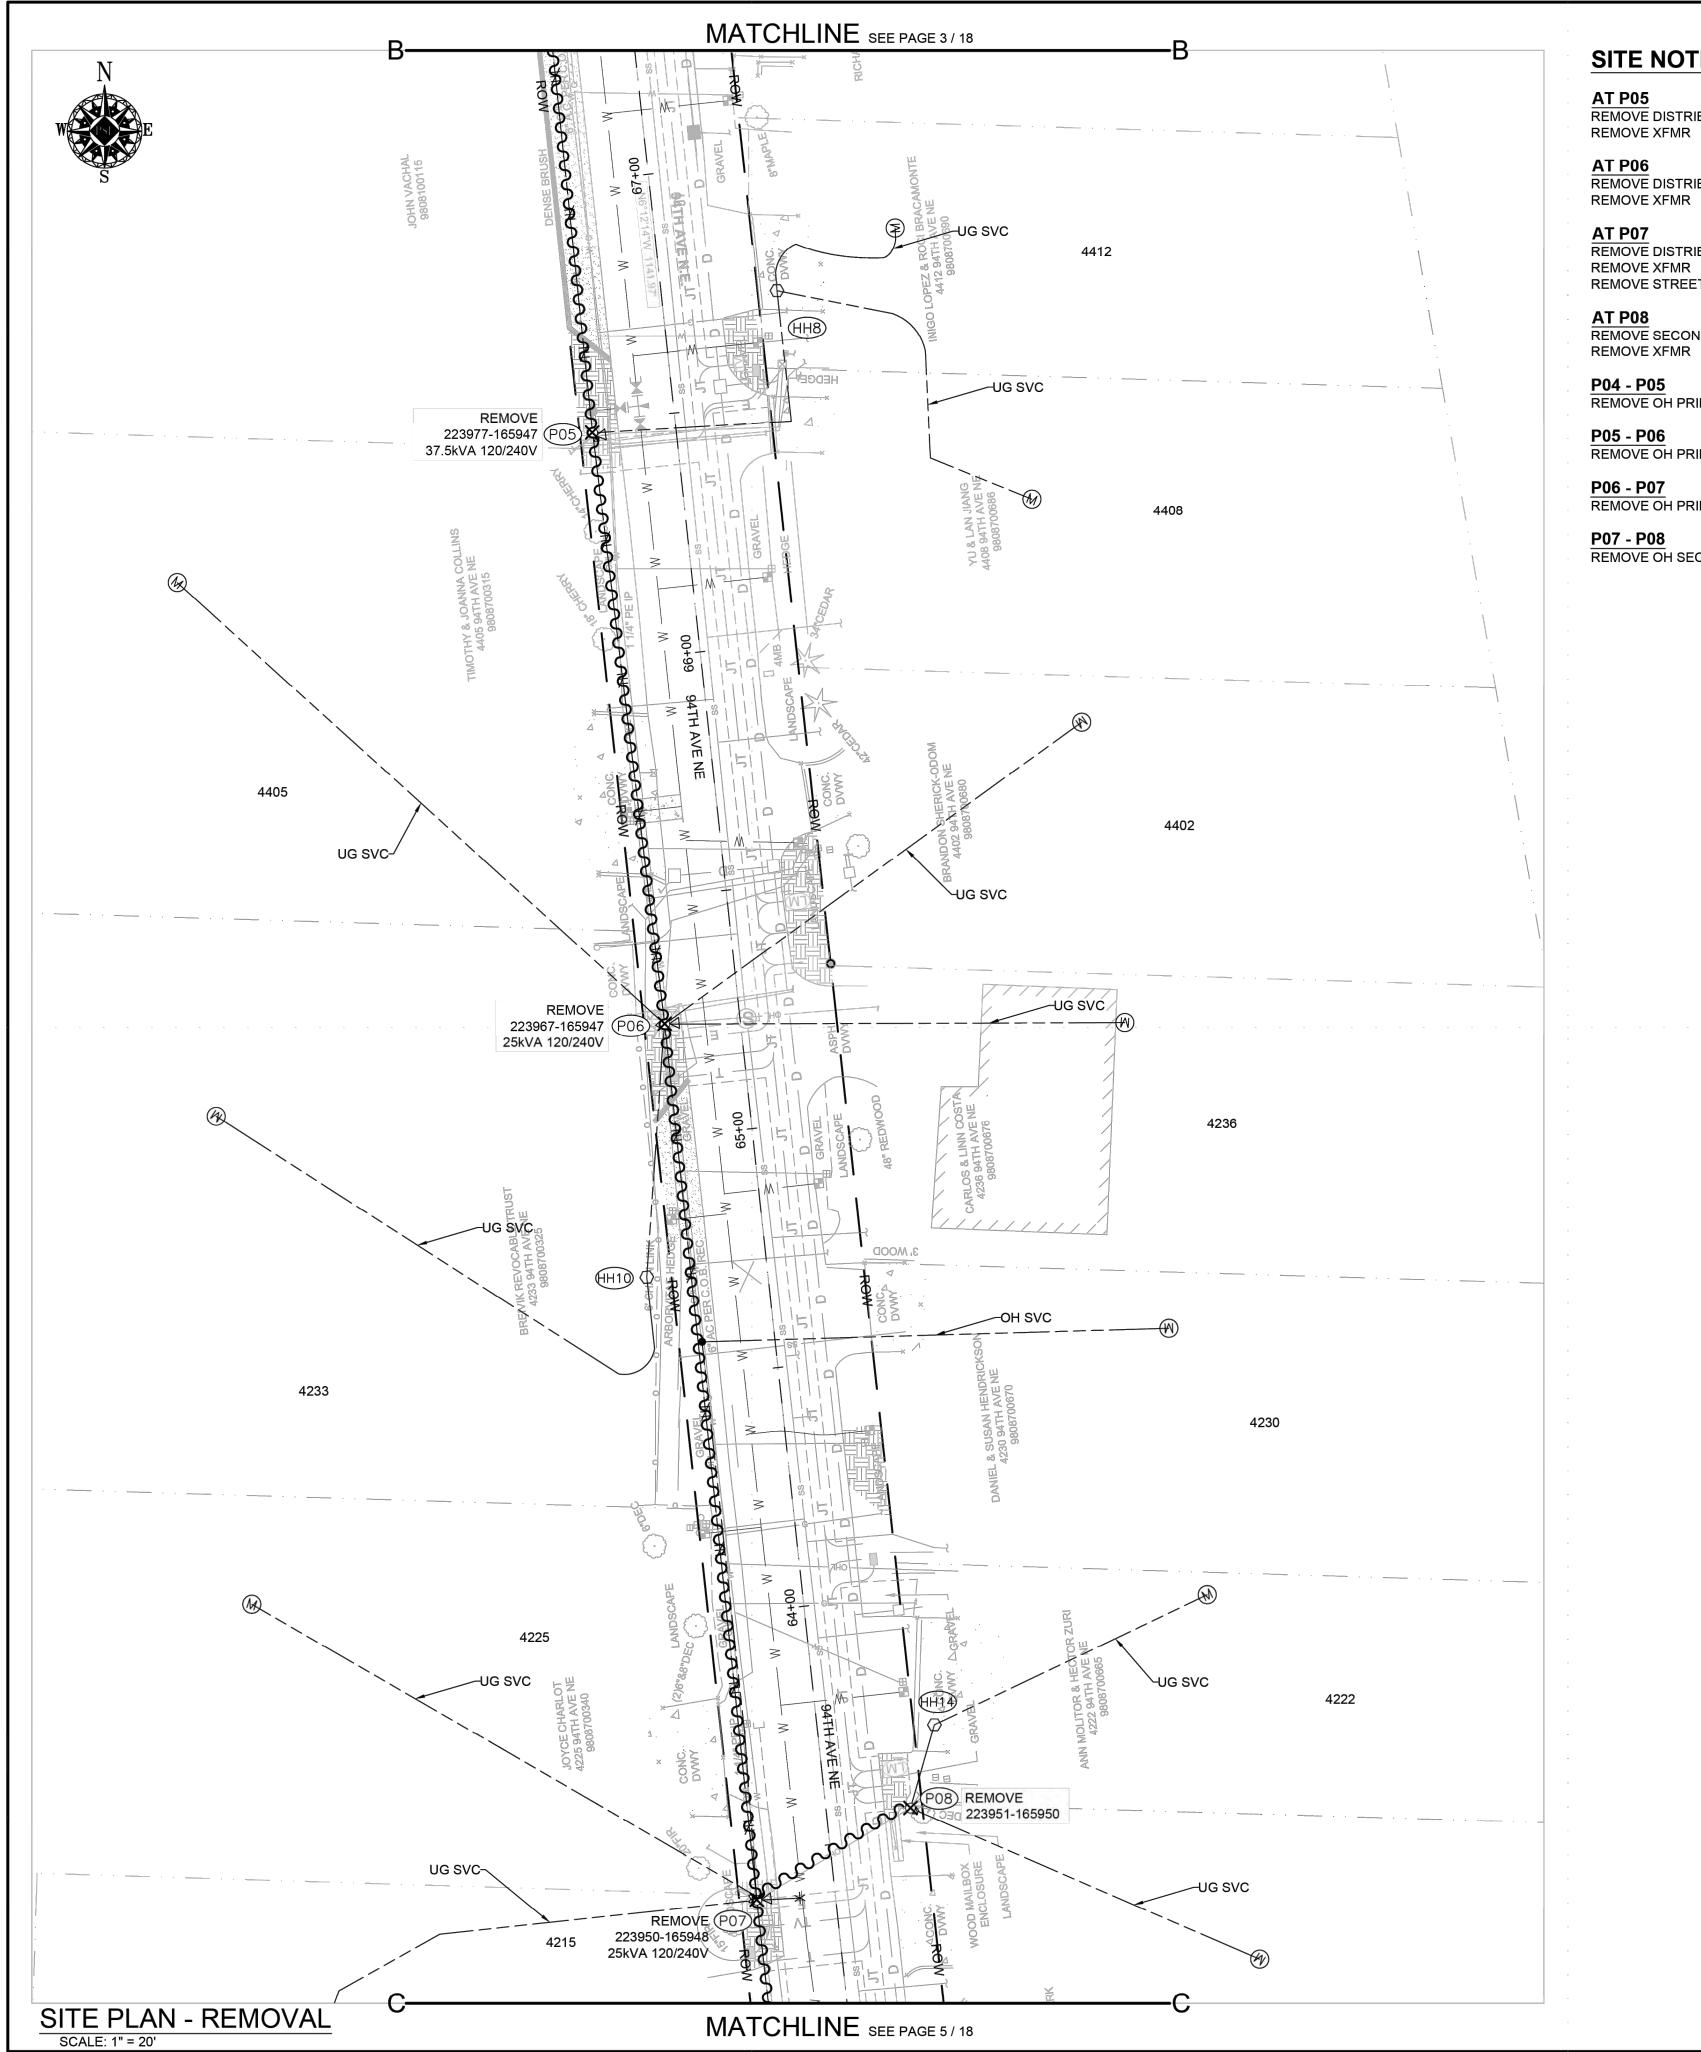

**AT P05** REMOVE DISTRIBUTION POLE

AT P06
REMOVE DISTRIBUTION POLE REMOVE XFMR

AT P07
REMOVE DISTRIBUTION POLE REMOVE XFMR REMOVE STREETLIGHT

AT P08 REMOVE SECONDARY SERVICE POLE REMOVE XFMR

P04 - P05 REMOVE OH PRIMARY CONDUCTOR

P05 - P06 REMOVE OH PRIMARY CONDUCTOR

P06 - P07 REMOVE OH PRIMARY CONDUCTOR

REMOVE OH SECONDARY CONDUCTOR

	POLE I	RETIRE	EMEN	T TAE	BLE		TEMP	TRANS	FERS	;	ST. LIGI	HT TRANSFERS
SITE #	Р	OLE DATA	1		РО	LE	TEI	TV	FIDED	TDAN	DM\/D	ID NUMBER
SITE #	GRID#	HEIGHT	CLASS	YEAR	TOPPED	RMVD	TEL	'V	FIBER	TRAN	RMVD	ID NUMBER
P05	223977-165947	45	-	-								
P06	223967-165947	45	-	-								
P07	223951-165950	45	-	-								
P08	223950-165948	45	-	-								

		WIRE REM	OVAL	TABLE	
Loca	ation			Length	
From	То	Wire Size & Type	Quantity	(Circuit FT)	Remarks
P04	P05	#2 ACSR/NEUT	2	100	
P05	P06	#2 ACSR/NEUT	2	125	
P06	P07	#2 ACSR/NEUT	2	190	
			•	SR) ACTUAL UT) ACTUAL	Removed Removed

SE	CON	<b>IDARY WIR</b>	RE REI	MOVAL	TABLE
Loca	ation			Length (per	
From	То	Wire Size & Type	Quantity	conductor)	Remarks
P07	P08	Triplex	1	40 FT	

TRANSFORMER REMOVAL Removed at site: Grid Number: 223991-165943 37.5kVA 120/240V Foreman to redline the following information Company ID#: Primary phase connected to:

Tested Secondary Voltage

TRANSFORMER REMOVAL Removed at site: Grid Number: 25kVA 120/240V kVA Rating: Foreman to redline the following information Company ID#: Primary phase connected to: Tested Secondary Voltage


TRANSFORMER REMOVAL Removed at site: Grid Number: 223934-165950 25kVA 120/240V kVA Rating: Foreman to redline the following information Company ID#: Primary phase connected to: Tested Secondary Voltage

						IVEAL	SIAIL/LA	SCIVICIVI	li Fizivii i	
								N/A	YARROV	/ POINT
3						FUNCT	ION	CONTACT	PHONE NO	DATE
2						PROJE	CT MGR	KIARA SKYE	425-213-920	5 10/13/23
1						ENGR -	POWER	KYLE HAYS	206-930-854	4 10/13/23
REV#	DATE	BY	DESCRI	PTION		ENGR -	GAS	N/A	N/A	N/A
OUNTY		Emer Sect	Gas Wk	Ctr POWE	R WK CTR	DRAWN	N BY	HOLLY SOREM	253-208-884	3 10/13/23
KING	3	N/A	N/A		CSPFEPI	CHECK	ED BY	Kyle Hays	(206) 930-85	44 10/13/23
4 SEC		OP MAP		PLAT N	/AP	APPRO	VED BY			
S18,19 2	5 05E	N/	Α		N/A	FOREM	1AN #1			
-MAP NO (P	POWER)	ОН СКТ МА	P UG	CKT MAP	CIRCUIT NO	FOREM	1AN #2			
A2505E0	72,73	D2505E07	76 R2	2505E072,73	MED-33	MAPPI	NG			
				JOII	NT FACILITIES A	RRANGE	MENTS			
(	UTILITIES		N/A		N/A			N/A	N/.	A
(	CONTACT		N/A		N/A			N/A	N/	A
	PHONE#		N/A		N/A			N/A	N/	A
PSE	PUG. SOU		94	1TH AV	E NE YAF		/ POIN	IT	INCIDENT N/A Gas Order	MAOP N/A Elect Order
W	ENER			4407.04	SCHEDULE		T 00004		N/A	101149280



94TH AVE NE YARROW POINT SCHEDULE 74 4467 94TH AVE NE YARROW POINT, 98004 DRAWING: PSE 4

AS NOTED 4 / 18

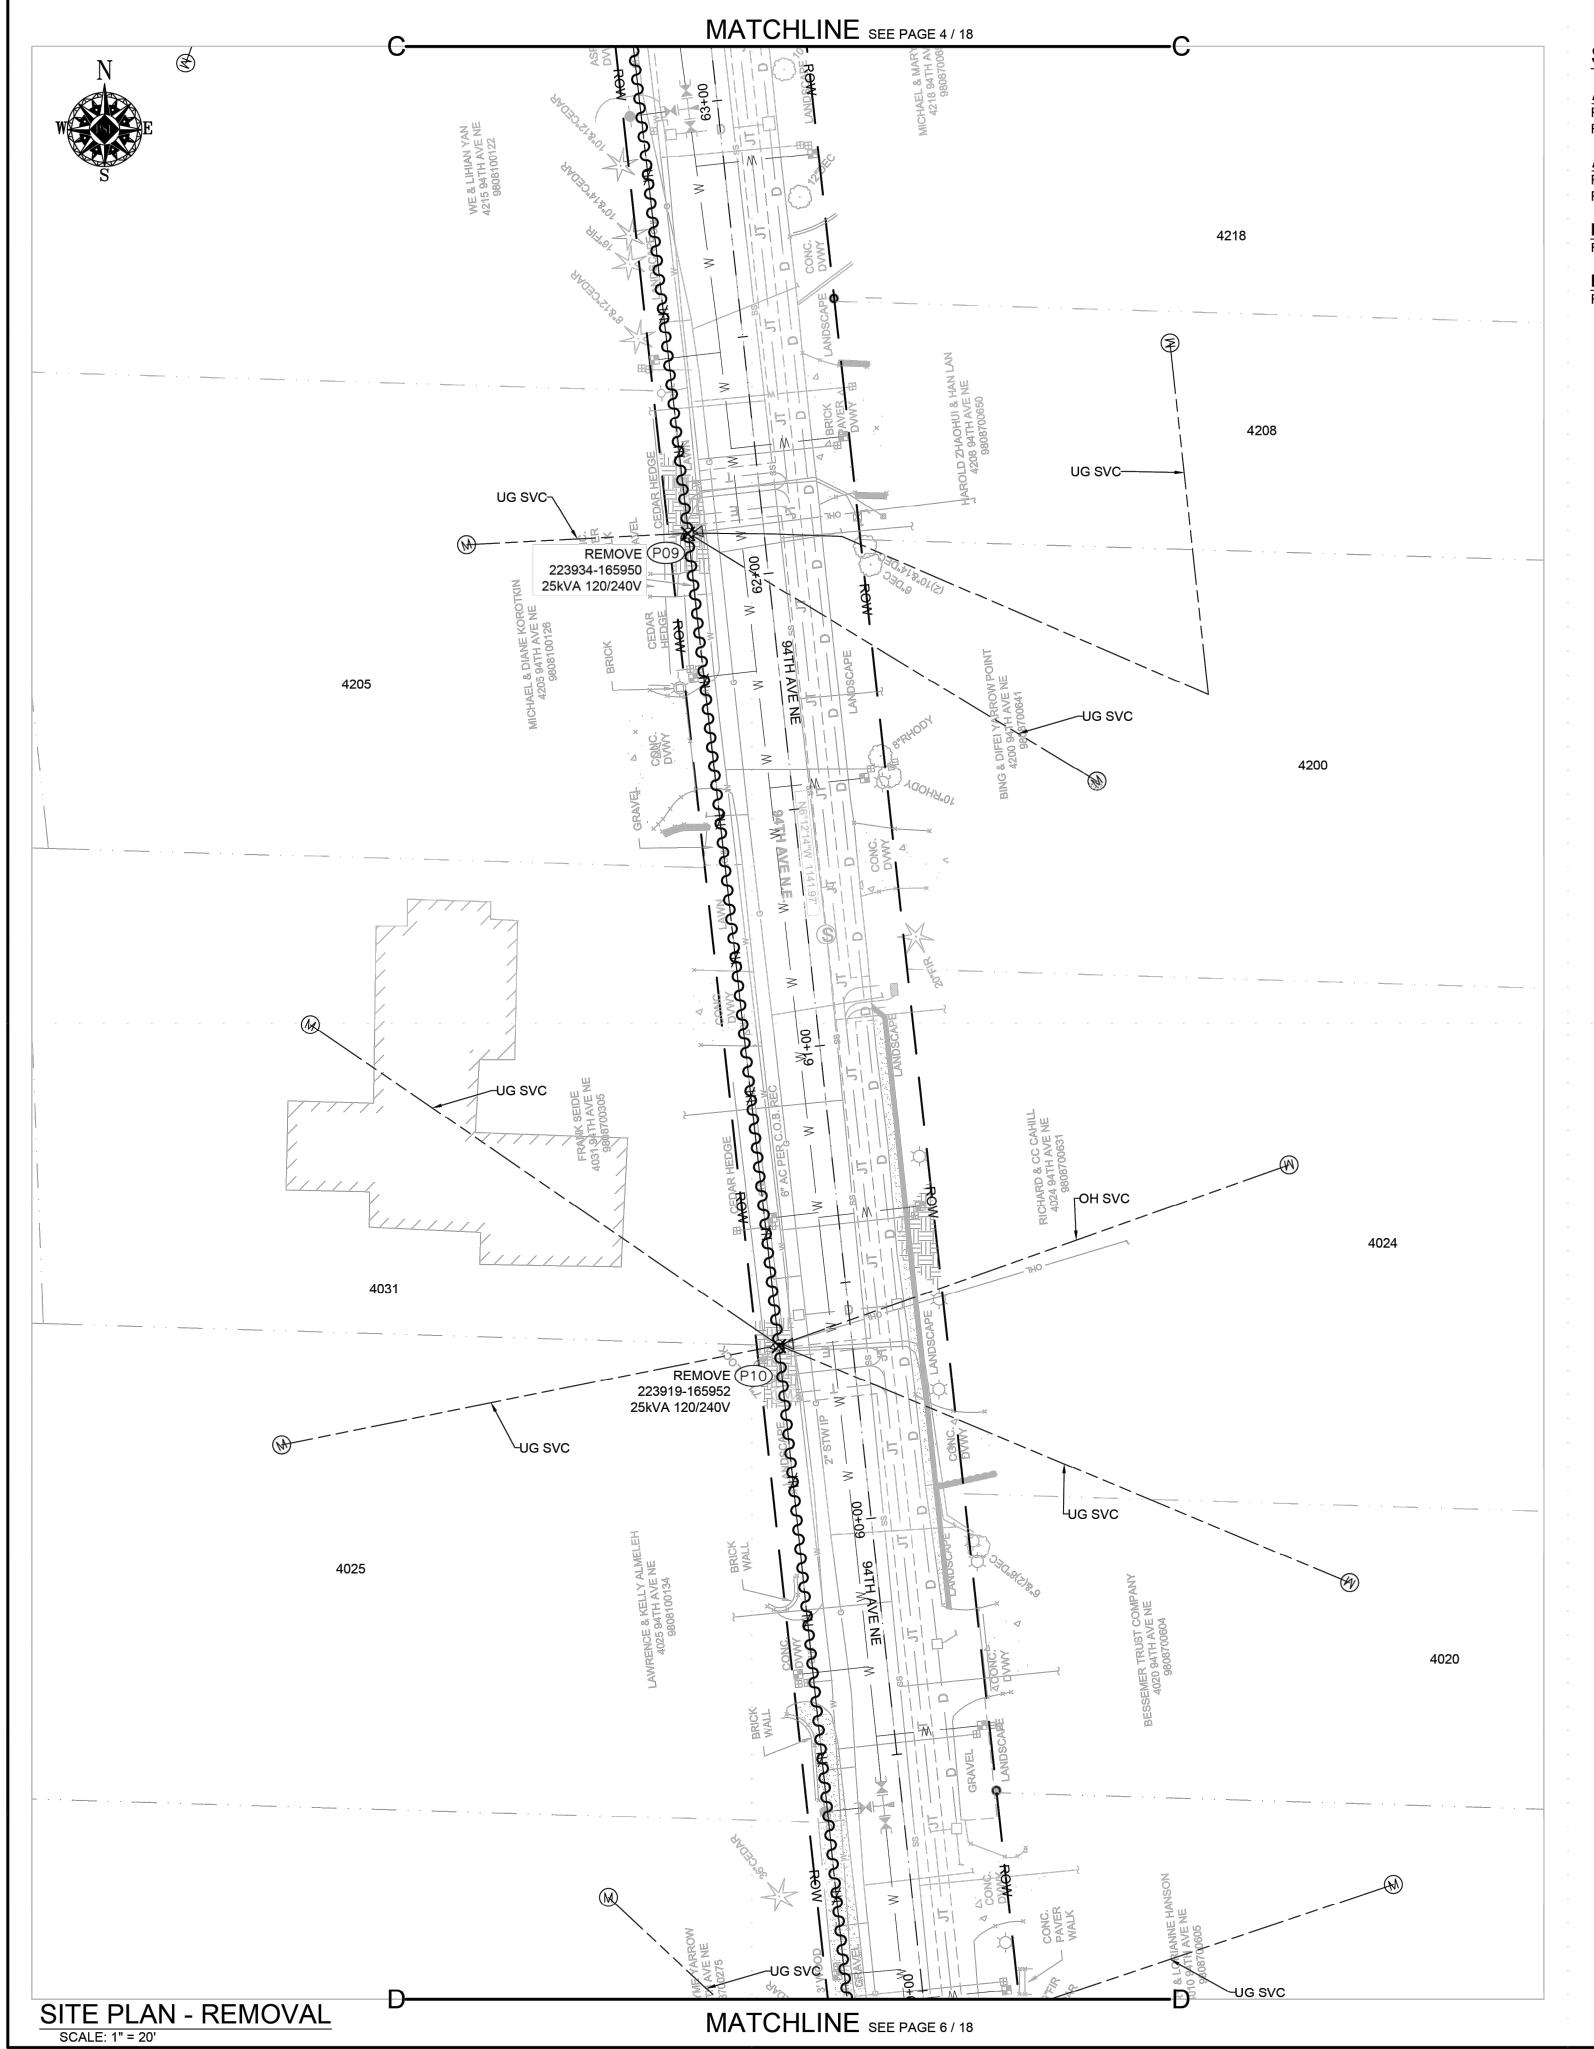

AT P09
REMOVE DISTRIBUTION POLE
REMOVE XFMR

AT P10
REMOVE DISTRIBUTION POLE
REMOVE XFMR

P08 - P09
REMOVE OH PRIMARY CONDUCTOR

P09 - P10
REMOVE OH PRIMARY CONDUCTOR

	POLE I	RETIRE	EMEN	T TAE	BLE		TEMP	TRANS	SFERS	,	ST. LIGI	HT TRANSFERS
SITE #	Р	OLE DATA	١		РО	LE	TEL	TV	FIBER	TDAN	RMVD	ID NUMBER
SITE #	GRID#	HEIGHT	CLASS	YEAR	TOPPED	RMVD	'51	1	FIBER	TRAN	RIVID	ID NUMBER
P09	223934-165950	. 45	-	-								
P10	223919-165952	45	_	-								

		WIRE REM	WIRE REMOVAL TABLE				
Loca	ation			Length			
From	То	Wire Size & Type	Quantity	(Circuit FT)	Remarks		
P07	P09	#2 ACSR/NEUT	2	130			
P09	P10	#2 ACSR/NEUT	2	175			
			•	SR) ACTUAL <sub></sub> UT) ACTUAL <sub></sub>			

Removed at site:	P09
Grid Number:	223934-165950
κVA Rating:	25kVA 120/240V
Foreman to redlin	e the following informa
	e the following informa
	e the following informa
F <mark>oreman to redlin</mark> Company ID#: Primary phase con	

Removed at site:	P10
Grid Number:	223919-165952
κVA Rating:	25kVA 120/240V
Company ID#:	e the following information
Primary phase con	nected to:
i ililiary priase con	
Tested Secondary	

							REAL E	STATE/EA	SEMENT	PERMIT	
								I	N/A	YARROW F	POINT
3							FUNCT	ION	CONTACT	PHONE NO	DATE
2							PROJE	CT MGR	KIARA SKYE	425-213-9205	10/13/23
1								POWER	KYLE HAYS	206-930-8544	10/13/23
REV#	DATE	BY	DES	ESCRIPTION				GAS	N/A	N/A	N/A
COUNTY		Emer Sect	Gas	Wk Ctr	POWER	WK CTR	DRAW	N BY	HOLLY SOREM	253-208-8843	10/13/23
KING	3	N/A N/A		CSPFEPI		CHECK	ED BY	Kyle Hays	(206) 930-8544	10/13/23	
1/4 SEC		OP MAP			PLAT M	AP	APPRO	VED BY			
S18,19 2	5 05E	N/	Ά		N/A		FOREMAN #1				
U-MAP NO (F	POWER)	ОН СКТ МА	·P	UG CKT	MAP	CIRCUIT NO	FOREM	1AN #2			
A2505E0	72,73	D2505E0	76	R2505E	072,73	MED-33	MAPPI	NG			
					JOIN	T FACILITIES AF	RRANGE	MENTS			
UTILITIES N/A					N/A			N/A	N/A		
CONTACT N/A				N/A	N/A			N/A			
	PHONE#		N/A			N/A	N/A N/A				
	DUC	ГТ					_	_		INCIDENT	MAOP




 94TH AVE NE YARROW POINT
 INCIDENT N/A
 MAOP N/A

 SCHEDULE 74
 Gas Order N/A
 Elect Order 101149280

 4467 94TH AVE NE YARROW POINT, 98004
 SCALE
 PAGE AS NOTED

 DRAWING: PSE 5
 AS NOTED
 5 / 18

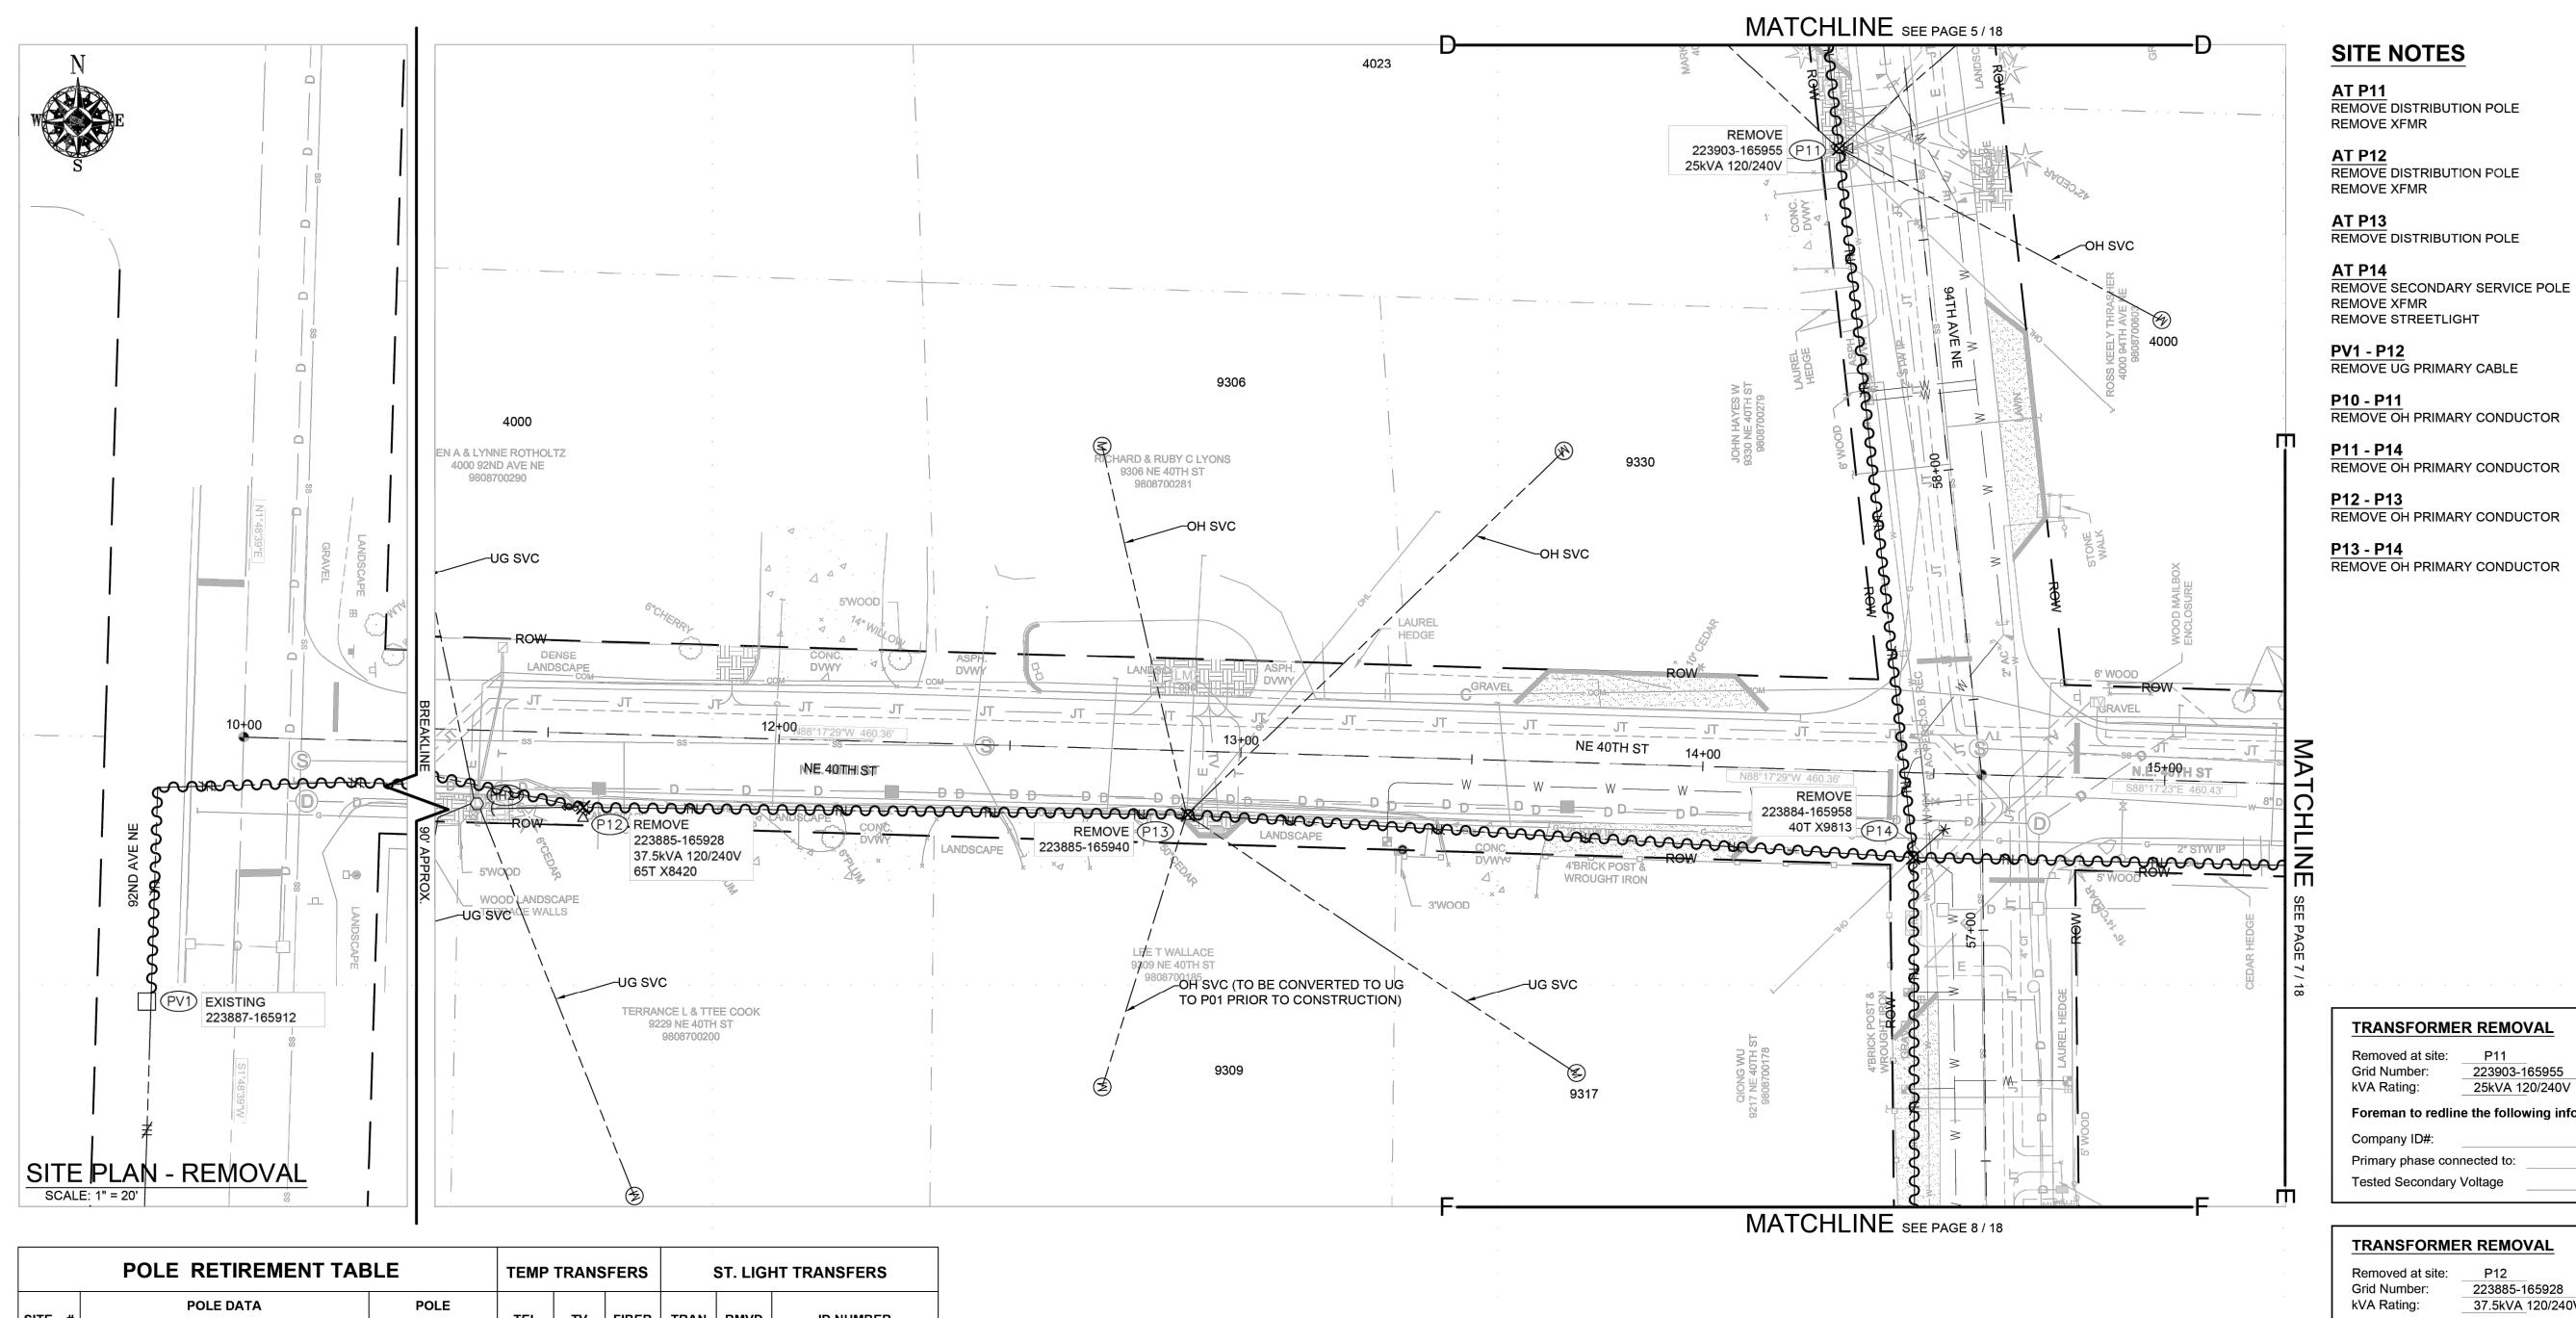

	POLE I	T TAE	BLE	TEMP TRANSFERS			ST. LIGHT TRANSFERS					
SITE #	Р	OLE DATA	١		РО	TEI	TV	LIDED	TDAN	DMVD	ID NUMBER	
SITE #	GRID#	HEIGHT	CLASS	YEAR	TOPPED	RMVD	TEL	IV	FIBER	TRAN	RMVD	ID NUMBER
P11	223903-165955	45	-	-								
P12	223885-165928	45	-	-								
P13	223885-165940	45	-	-								
P14	223884-165958	45	-	-								

		WIRE REM	OVAL	TABLE	=
Loc	ation			Length	
From	То	Wire Size & Type	Quantity	(Circuit FT)	Remarks
P10	P11	#2 ACSR/NEUT	2	170	
P11	P14	#2 ACSR/NEUT	2	155	
P12	P13	#2 ACSR/NEUT	4	160	
P13	P14	#2 ACSR/NEUT	4	160	
			•	SR) ACTUAL UT) ACTUAL	

## CABLE REMOVAL SCHEDULE

CABLE	LOCA	TIONS	CABLE	CABLE TYPE	YEAR INST					
NO.	FROM	то	(LF) EST							
ACX832	P12	PV1	220	1/0 SOL CONCENTRIC NEUTRAL						
ACX833	P12	PV1	220	1/0 SOL CONCENTRIC NEUTRAL						
ACX834	P12	PV1	220	1/0 SOL CONCENTRIC NEUTRAL						
	Total Feet 660 (1/0 JKT) ACTUALRemoved									

## SITE NOTES

<u>AT P11</u>

REMOVE DISTRIBUTION POLE REMOVE XFMR

**AT P12** 

REMOVE DISTRIBUTION POLE REMOVE XFMR

**AT P13** REMOVE DISTRIBUTION POLE

REMOVE XFMR REMOVE STREETLIGHT

PV1 - P12

REMOVE UG PRIMARY CABLE

P10 - P11

REMOVE OH PRIMARY CONDUCTOR

REMOVE OH PRIMARY CONDUCTOR

P12 - P13 REMOVE OH PRIMARY CONDUCTOR

P13 - P14

REMOVE OH PRIMARY CONDUCTOR

TRANSFORMER REMOVAL

Removed at site: Grid Number: 223903-165955 kVA Rating: 25kVA 120/240V

Foreman to redline the following information

Company ID#:

Primary phase connected to: Tested Secondary Voltage

TRANSFORMER REMOVAL

223885-165928 Grid Number: 37.5kVA 120/240V kVA Rating:

Foreman to redline the following information Company ID#:

Primary phase connected to:

Tested Secondary Voltage

							REAL E	STATE/EA	SEMENT	PERMIT			
									N/A	YARROW PO	TNIC		
3							FUNCT	ION	CONTACT	PHONE NO	DATE		
2							PROJE	CT MGR	KIARA SKYE	425-213-9205	10/13/23		
1						ENGR -	POWER	KYLE HAYS	206-930-8544	10/13/23			
EV#	DATE	BY	DES	CRIPTIO	N		ENGR -	GAS	N/A	N/A	N/A		
NTY		Emer Sect	Gas	Gas Wk Ctr POWER WK CTR			DRAW	RAWN BY HOLLY SORE		253-208-8843	10/13/23		
KING	3	N/A		N/A		CSPFEPI		ED BY	Kyle Hays	(206) 930-8544	10/13/23		
EC		OP MAP			PLAT MAP		APPROVED BY						
S18,19 2	5 05E	N/	Ά			N/A		IAN #1					
AP NO (P	POWER)	ОН СКТ МА	ď.	UG CKT	MAP	CIRCUIT NO	FOREM	1AN #2					
A2505E0	072,73 D2505E076 R2505E072,73 ME		MED-33	MAPPII	NG								
					JOIN	T FACILITIES AF	RRANGE	MENTS					
	UTILITIES	N/A			N/A			N/A	N/A				
(	CONTACT	NTACT N/A				N/A		N/A	N/A				
	PHONE# N/A N/A			N/A			N/A	N/A					




94TH AVE NE YARROW POINT SCHEDULE 74 4467 94TH AVE NE YARROW POINT, 98004

DRAWING: PSE 6

INCIDENT MAOP
N/A N/A

Gas Order Elect Order
N/A 101149280 AS NOTED 6 / 18

101149280

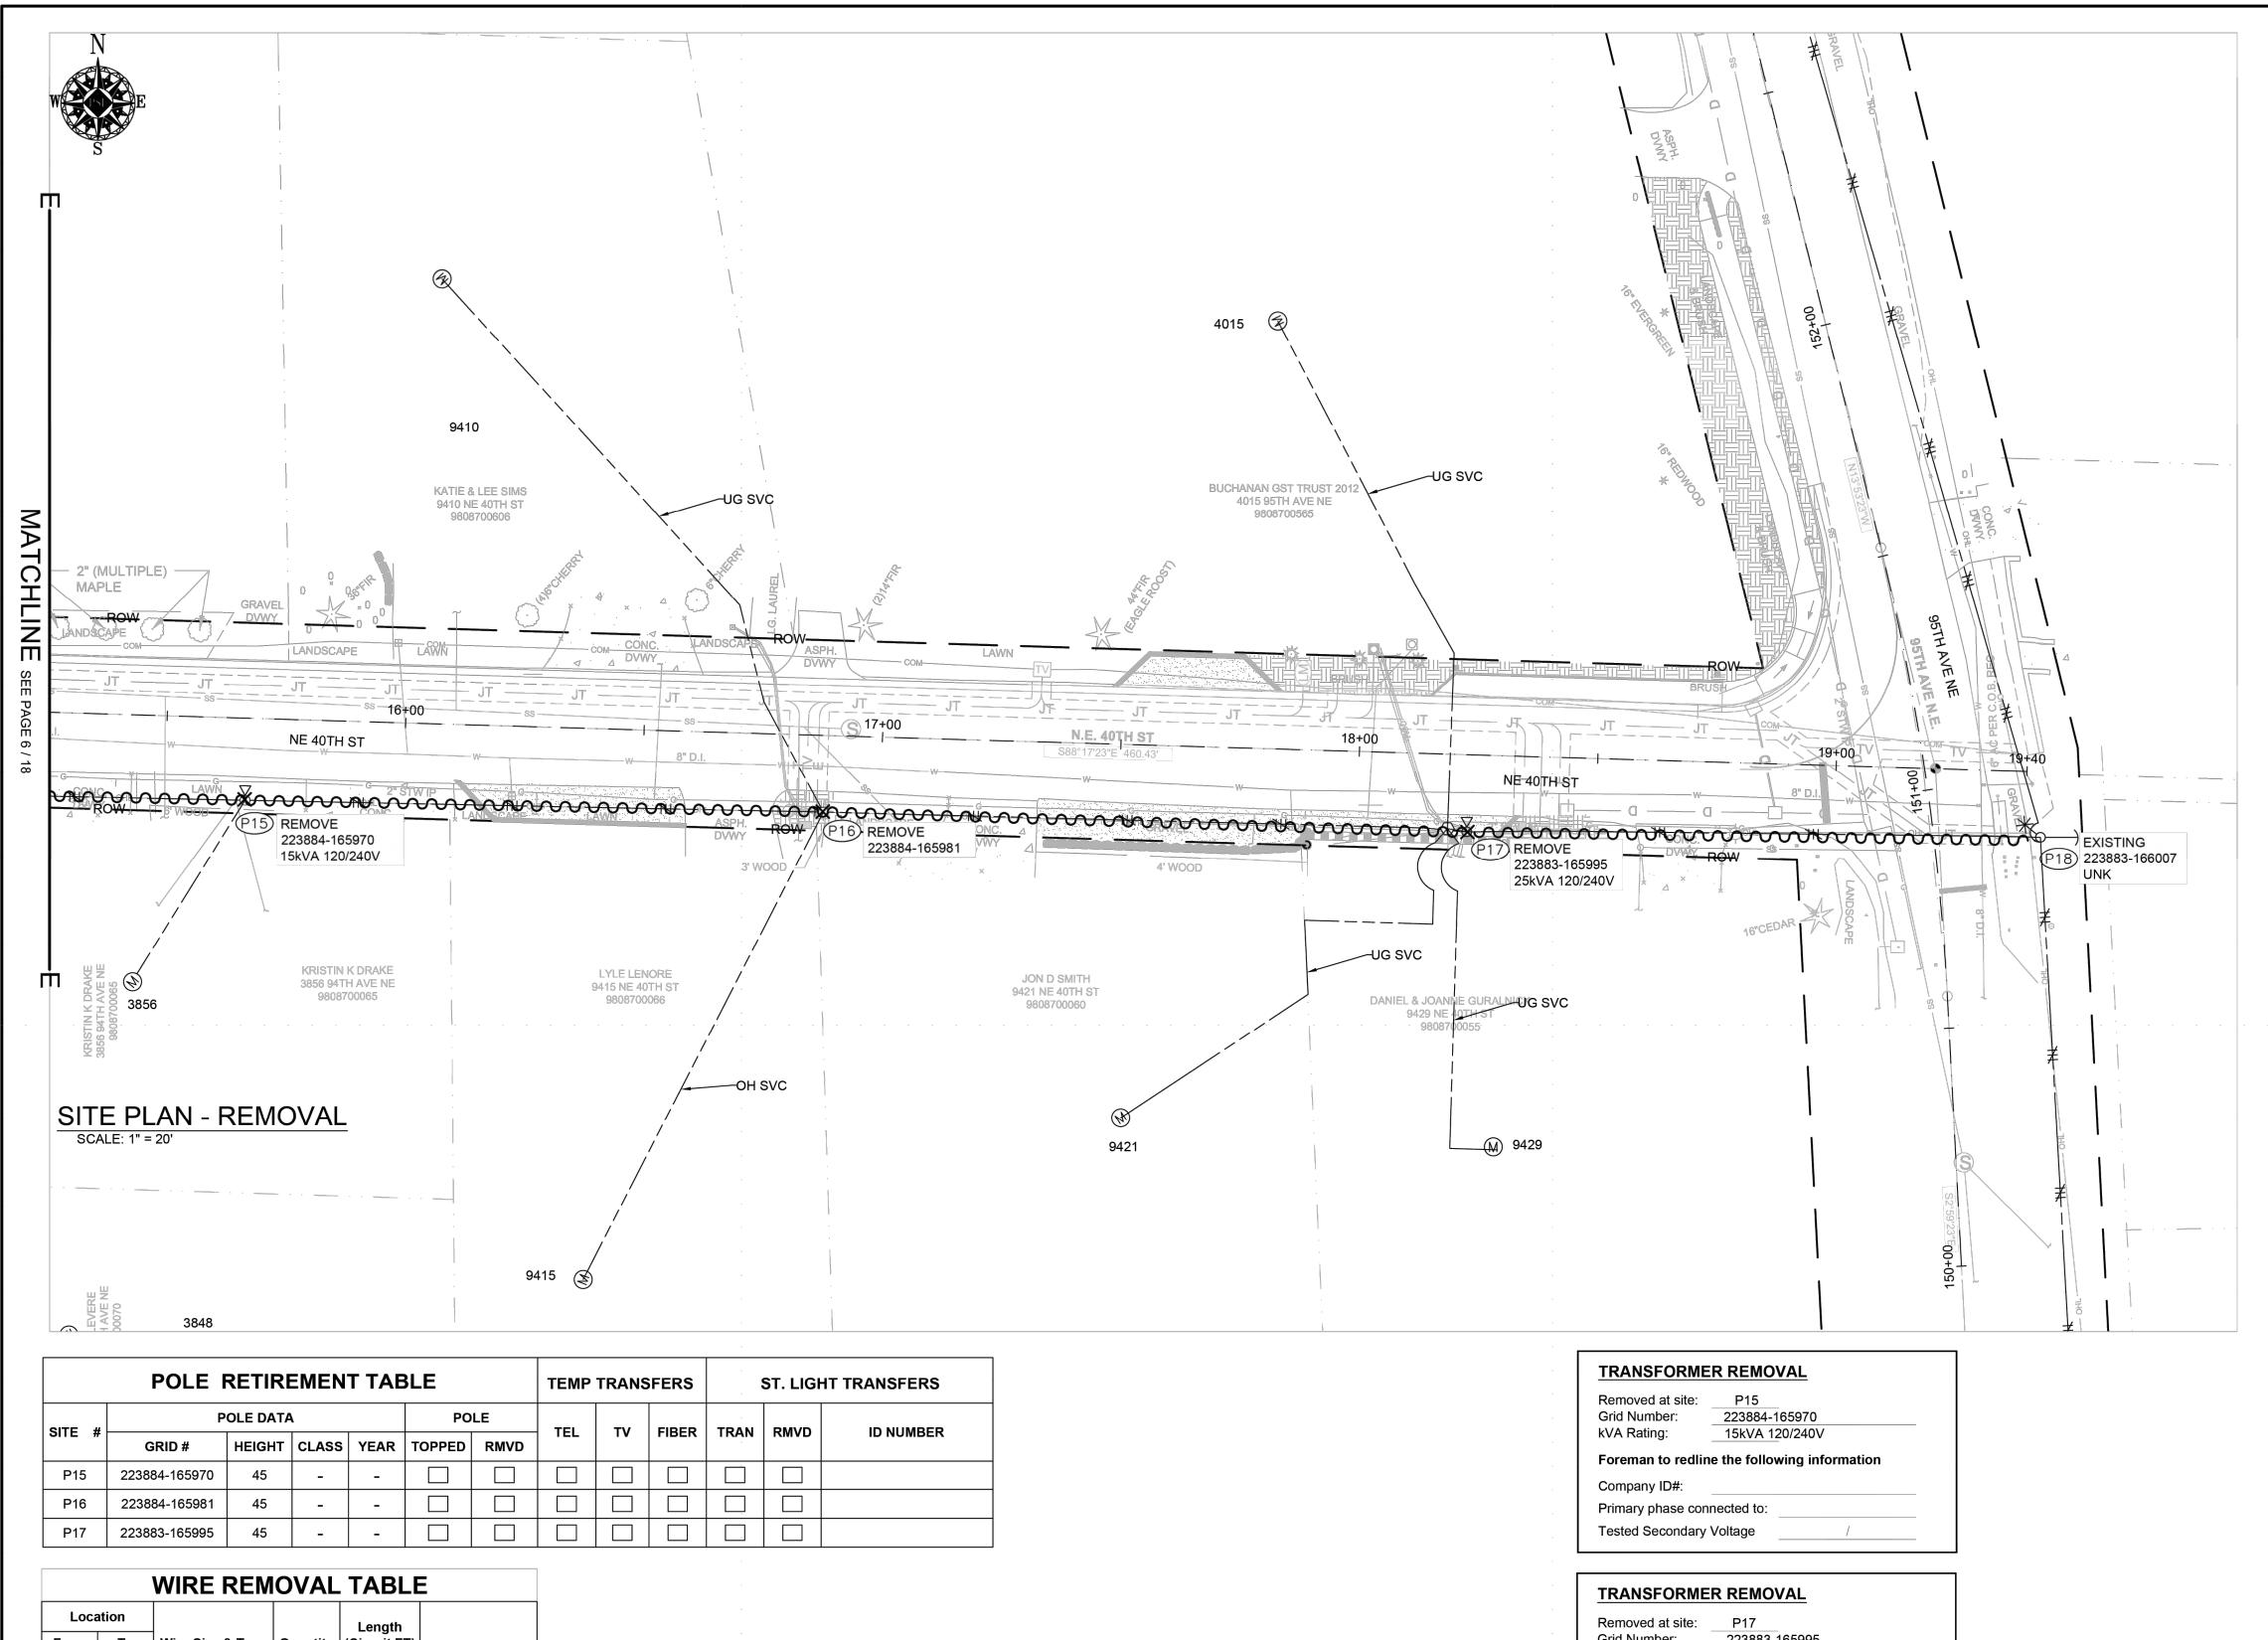

		WIKE KEW	OVAL	IABLE						
Loca	ation			Length						
From	То	Wire Size & Type	Quantity	(Circuit FT)	Remarks					
P14	P15	#2 ACSR/NEUT	4	120						
P15	P16	#2 ACSR/NEUT	4	125						
P16	P17	#2 ACSR/NEUT	4	135						
P17	P18	#2 ACSR/NEUT	4	120						
Total Feet 1500 (#2 ACSR) ACTUALRemoved Total Feet 500 (NEUT) ACTUALRemoved										

Removed at site:	P17	
Grid Number:	223883-1659	995
kVA Rating:	25	
Foreman to redlin	e the following	informatio
	e the following	j informatio
Foreman to redlin Company ID#: Primary phase con		j informatio

AT P15

REMOVE DISTRIBUTION POLE REMOVE XFMR

AT P16
REMOVE DISTRIBUTION POLE

EXISTING DISTRIBUTION POLE REMOVE XFMR

INSTALL 3Ø TERM

AT P18
EXISTING DISTRIBUTION POLE

P14 - P15
REMOVE OH PRIMARY CONDUCTOR

P15 - P16
REMOVE OH PRIMARY CONDUCTOR

P16 - P17

REMOVE OH PRIMARY CONDUCTOR


							REAL F	ESTATE/EA	SEMENT	PERMIT	
									N/A	YARROW P	OINT
3							FUNCT	ION	CONTACT	PHONE NO	DATE
2							PROJE	CT MGR	KIARA SKYE	425-213-9205	10/13/23
1							ENGR - POWER KYLE HAYS			206-930-8544	10/13/23
REV#	DATE	BY	DES	SCRIPTIO	N		ENGR - GAS N/A			N/A	N/A
OUNTY		Emer Sect	Gas Wk Ctr POWER WK CTR				DRAWN	AWN BY HOLLY SOREM		253-208-8843	10/13/23
KING	KING N/A N/A		N/A	CSPFEPI		CHECK	(ED BY	Kyle Hays	(206) 930-8544	10/13/23	
/4 SEC		OP MAP		,	PLAT MAP		APPROVED BY				
S18,19 25	5 05E	N/A	Α	'	N/A		FOREMAN #1		·		
-MAP NO (P	OWER)	OH CKT MA	'b	UG CKT	MAP	CIRCUIT NO	FOREM	1AN #2	1		
A2505E0	72,73	D2505E07	76	R2505F	E072,73	MED-33	MAPPIN	NG	[		
					JOIN	IT FACILITIES AR	RANGE	MENTS			
ı	UTILITIES N/A N/A			N/A			N/A	N/A			
C	CONTACT N/A N/A			N/A	N/A			N/A			
PHONE# N/A N/A				N/A N/A							
$\overline{}$									-	INCIDENT	MAOD



 94TH AVE NE YARROW POINT
 INCIDENT MAOP N/A N/A

 SCHEDULE 74
 Gas Order N/A 101149280

 4467 94TH AVE NE YARROW POINT, 98004
 SCALE PAGE AS NOTED 7 / 18

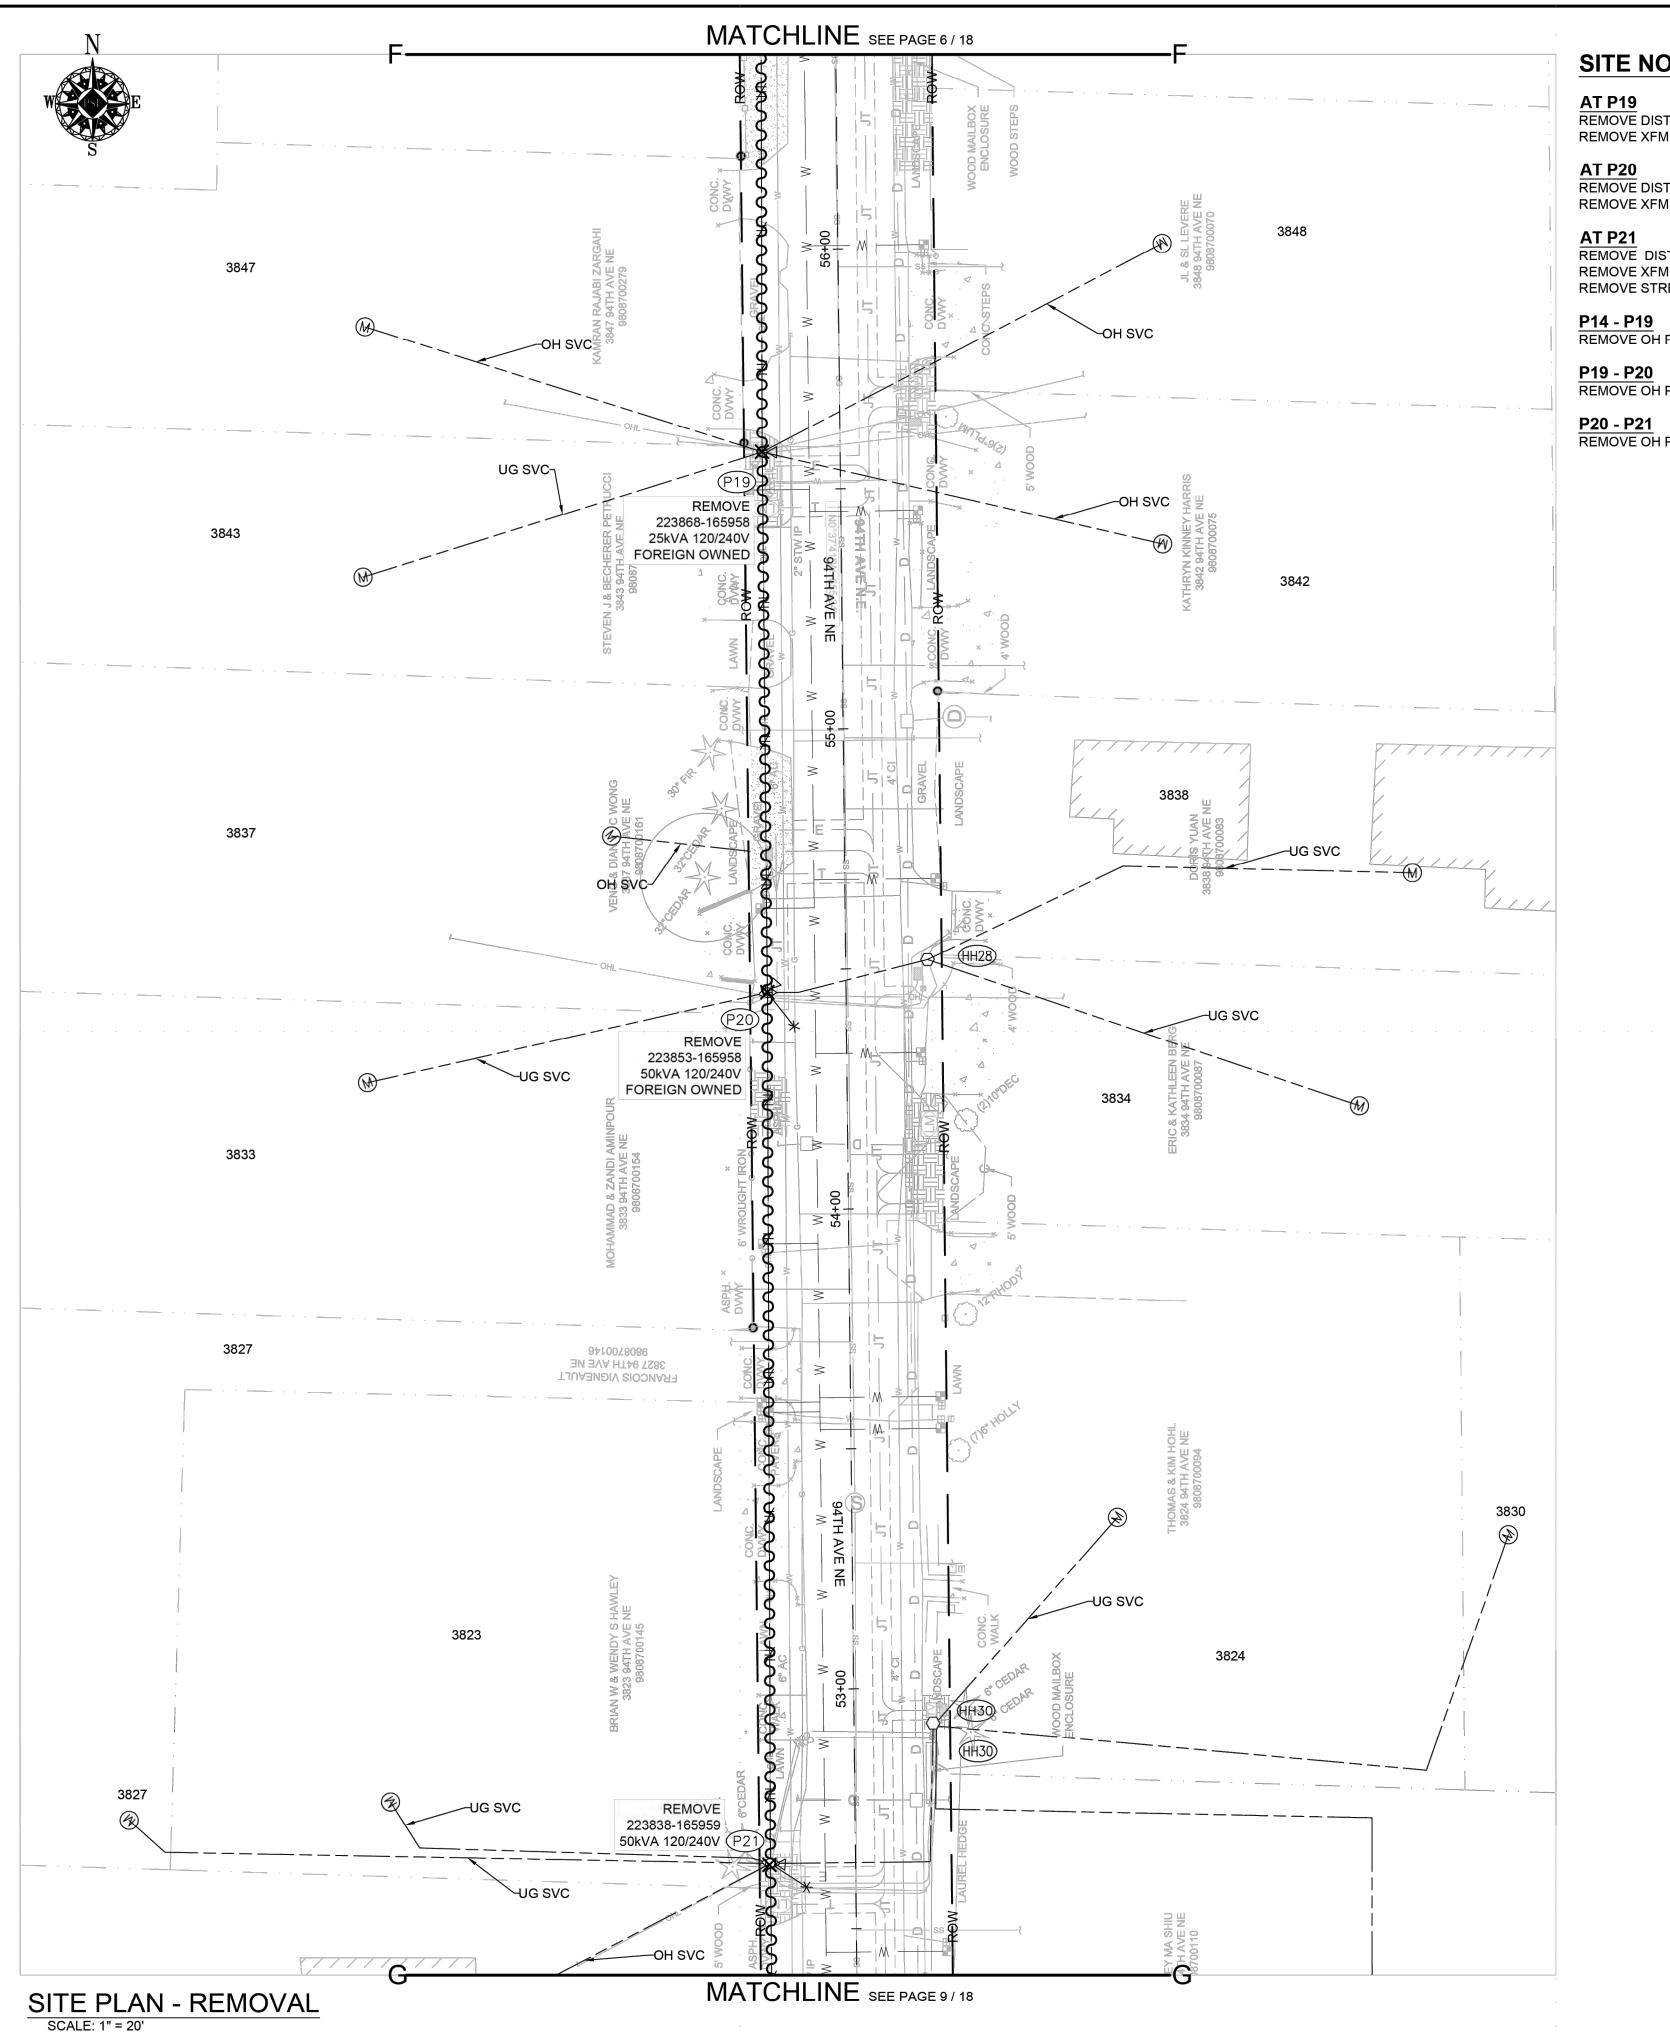

AT P19
REMOVE DISTRIBUTION POLE
REMOVE XFMR

AT P20 REMOVE DISTRIBUTION POLE REMOVE XFMR

AT P21 REMOVE DISTRIBUTION POLE REMOVE XFMR REMOVE STREETLIGHT

REMOVE OH PRIMARY CONDUCTOR

REMOVE OH PRIMARY CONDUCTOR

P20 - P21 REMOVE OH PRIMARY CONDUCTOR

	POLE I	T TAE	BLE	TEMP TRANSFERS ST. LIGHT TRANSFERS					HT TRANSFERS			
OITE #	POLE DATA				POLE		TE.	<b>-</b>	FIDED	TDAN	DM/D	ID NUMBER
SITE #	GRID#	HEIGHT	CLASS	YEAR	TOPPED	RMVD	TEL	TV	FIBER	TRAN	RMVD	ID NUMBER
P19	223868-165958	45	-	-								
P20	223853-165958	45	-	-								
P21	223838-165959	45	_	_								

		WIRE REM	OVAL	TABLE	<b>=</b>					
Loca	ation			Length						
From	То	Wire Size & Type	Quantity	(Circuit FT)	Remarks					
P14	P19	#2 ACSR/NEUT	2	160						
P19	P20	#2 ACSR/NEUT	2	115						
P20	P21	#2 ACSR/NEUT	2	185						
Total Feet 460 (#2 ACSR) ACTUALRemoved Total Feet 460 (NEUT) ACTUALRemoved										

TRANSFORMER REMOVAL Removed at site: Grid Number: kVA Rating: 25kVA 120/240V Foreman to redline the following information Company ID#: Primary phase connected to: Tested Secondary Voltage

TRANSFORMER REMOVAL Removed at site: 223853-165958 25kVA 120/240V Grid Number: kVA Rating: Foreman to redline the following information Company ID#: Primary phase connected to: Tested Secondary Voltage

TRANSFORMER REMOVAL Removed at site: Grid Number: kVA Rating: 50kVA 120/240V Foreman to redline the following information Company ID#: Primary phase connected to: Tested Secondary Voltage


							KEAL E	SIAIE/EA	SEIVIENT	PERIVILI		
						_			N/A	YARROW P	TNIC	
3							FUNCT	ION	CONTACT	PHONE NO	DATE	
2							PROJE	CT MGR	KIARA SKYE	425-213-9205	10/13/23	
1							ENGR -	POWER	KYLE HAYS	206-930-8544	10/13/23	
REV#	DATE	BY	DES	CRIPTIO	N		ENGR -	GAS	N/A	N/A	N/A	
INTY		Emer Sect	Gas	Wk Ctr	POWE	R WK CTR	DRAW	N BY	HOLLY SOREM	253-208-8843	10/13/23	
KING	KING N/A N/A					CSPFEPI	CHECK	ED BY	Kyle Hays	(206) 930-8544	10/13/23	
SEC		OP MAP	DP MAP PL		PLAT	PLAT MAP		VED BY				
S18,19 2	5 05E	N/	Ά			N/A		1AN #1				
AP NO (F	POWER)	ОН СКТ МА	·P	UG CKT	MAP	CIRCUIT NO	FOREM	IAN #2				
A2505E0	505E072,73 D2505E076 R2505E072,73		MED-33	MAPPII	NG							
					JOI	NT FACILITIES AI	RRANGE	MENTS				
	UTILITIES N/A			N/A			N/A	N/A	·			
(	CONTACT N/A			N/A			N/A	N/A				
PHONE# N/A N/A			N/A			N/A	N/A					



94TH AVE NE YARROW POINT SCHEDULE 74 4467 94TH AVE NE YARROW POINT, 98004

INCIDENT MAOP
N/A N/A

Gas Order Elect Order
N/A 101149280 DRAWING: PSE 8 AS NOTED 8 / 18

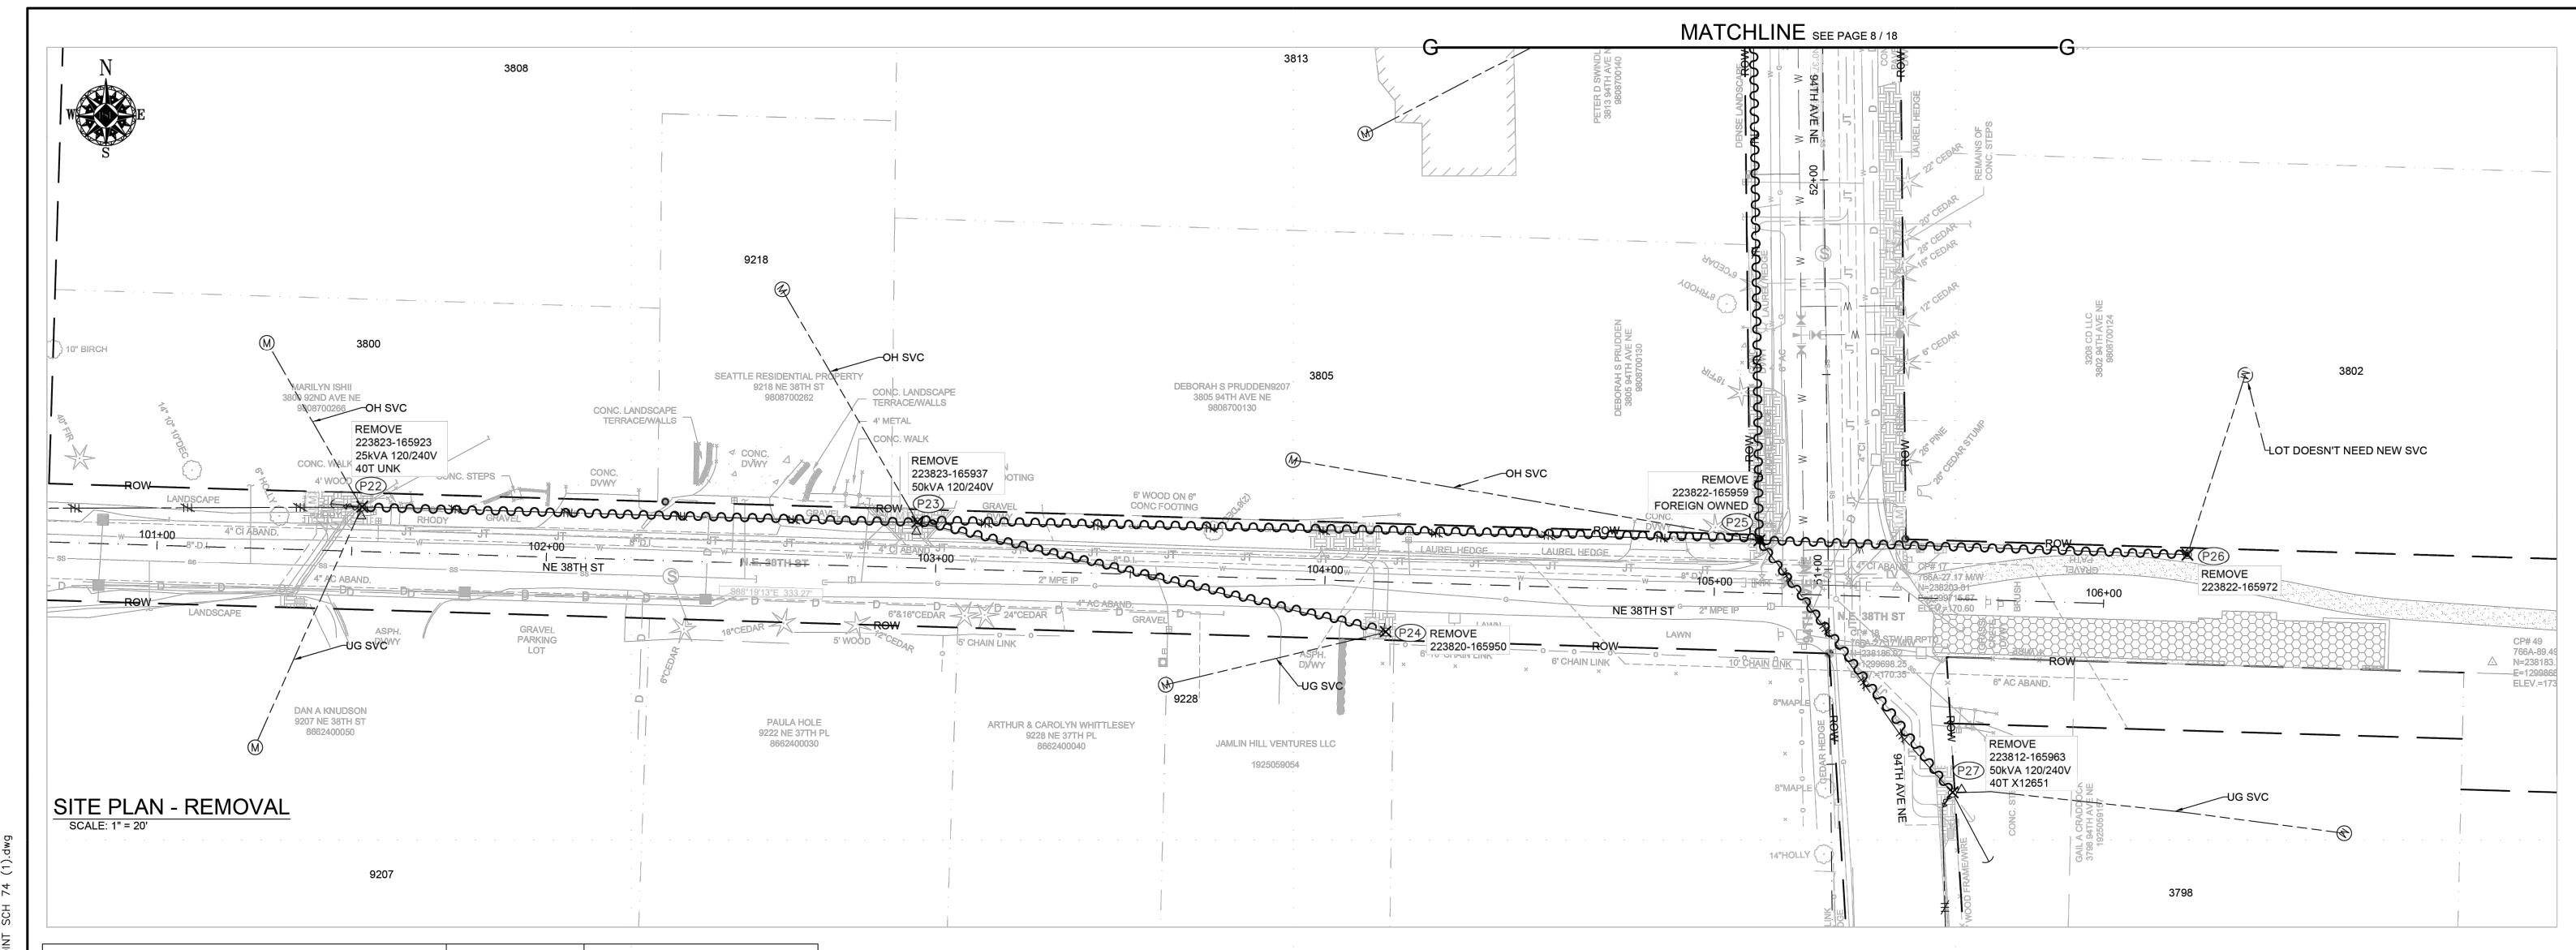

	POLE I	RETIRI	EMEN	T TAE	BLE		TEMP TRANSFERS			ST. LIGHT TRANSFERS		
SITE #	Р	OLE DATA	4		POLE		TEI	TV	FIBER	TDAN	DM//D	ID NUMBER
SIIE #	GRID#	HEIGHT	CLASS	YEAR	TOPPED	RMVD	TEL	''	FIDER	TRAN	RMVD	ID NOMBER
P22	223823-165923	45	-	-								
P23	223823-165937	45	-	-								
P24	223820-165950	45	-	-								
P25	223822-156959	45	-	-								
P26	223822-165972	45	-	_								
P27	223812-165963	45	-	-								

		WIRE REM	OVAL	TABLE	
Loca	ation			Longth	
From	То	Wire Size & Type	Quantity	Length (Circuit FT)	Remarks
P21	P25	#2 ACSR/NEUT	2	160	
P22	P23	#2 ACSR/NEUT	2	145	
P23	P24	TRIPLEX	1	125	
P23	P25	#2 ACSR/NEUT	2	220	
P25	P26	TRIPLEX	1	110	
P26	P27	#2 ACSR/NEUT	2	85	
		Total	Feet 610 (N	CSR) ACTUAL EUT) ACTUAL PLEX) ACTUAL	Removed

AT P22
REMOVE DISTRIBUTION POLE
REMOVE XFMR

AT P23
REMOVE DISTRIBUTION POLE
REMOVE XFMR

AT P24
REMOVE DISTRIBUTION POLE
REMOVE XFMR

REMOVE STREETLIGHT

AT P25
REMOVE DISTRIBUTION POLE
REMOVE XFMR
REMOVE STREETLIGHT

AT P26
REMOVE DISTRIBUTION POLE
REMOVE XFMR
REMOVE STREETLIGHT

AT P27
REMOVE DISTRIBUTION POLE
REMOVE XFMR
REMOVE STREETLIGHT

P21 - P22
REMOVE OH PRIMARY CONDUCTOR

P22 - P23 REMOVE OH PRIMARY CONDUCTOR

P23 - P24
REMOVE OH SECONDARY CONDUCTOR
P23 - P25
REMOVE OH PRIMARY CONDUCTOR

P25 - P27
REMOVE OH PRIMARY CONDUCTOR

P25 - P26
REMOVE OH SECONDARY CONDUCTOR

## TRANSFORMER REMOVAL

 Removed at site:
 P22

 Grid Number:
 223823-165923

 kVA Rating:
 25kVA 120/240V

Foreman to redline the following information

Company ID#:

Primary phase connected to:
Tested Secondary Voltage

## TRANSFORMER REMOVAL

Removed at site: P23
Grid Number: 223823-165937
kVA Rating: 50kVA 120/240V

Foreman to redline the following information

Company ID#:
Primary phase connected to:
Tested Secondary Voltage

## TRANSFORMER REMOVAL

 Removed at site:
 P27

 Grid Number:
 223812-165963

 kVA Rating:
 50kVA 120/240V

Foreman to redline the following information

Company ID#:

Primary phase connected to:

Tested Secondary Voltage

						REAL E	STATE/EA	SEMENT	PERMIT	
								N/A	YARROW	POINT
3						FUNCTI	ON	CONTACT	PHONE NO	DATE
2						PROJEC	CT MGR	KIARA SKYE	425-213-9205	10/13/23
1						ENGR -	POWER	KYLE HAYS	206-930-8544	10/13/23
REV#	DATE	BY	DESCRIPTIO	N	N		GAS	N/A	N/A	N/A
COUNTY		Emer Sect	Gas Wk Ctr	POWER	R WK CTR	DRAWN	BY	HOLLY SOREM	253-208-8843	10/13/23
KING N/A		N/A	N/A	CSPFEPI		CHECKED BY		Kyle Hays	(206) 930-8544	10/13/23
/4 SEC		OP MAP	AP PLAT MAP		APPRO	VED BY				
S18,19 25	5 05E	N/.	Α		N/A	FOREM	AN #1			
J-MAP NO (P	OWER)	ОН СКТ МА	P UG CKT	MAP	CIRCUIT NO	FOREMAN #2				
A2505E0	72,73	D2505E07	76 R2505	E072,73	MED-33	MAPPIN	IG			
				JOIN	IT FACILITIES AF	RRANGEN	MENTS			
Į	JTILITIES		N/A		N/A			N/A	N/A	
C	CONTACT N/A N/A		N/A			N/A	N/A			
PHONE# N/A N/A								N/A	N/A	
PUGET 94TH AVE NE YARROW POINT									INCIDENT N/A	MAOP N/A




 94TH AVE NE YARROW POINT
 INCIDENT N/A N/A
 MAOP N/A

 SCHEDULE 74
 Gas Order N/A 101149280
 Elect Order 101149280

 4467 94TH AVE NE YARROW POINT, 98004
 SCALE PAGE AS NOTED 9 / 18

101149280

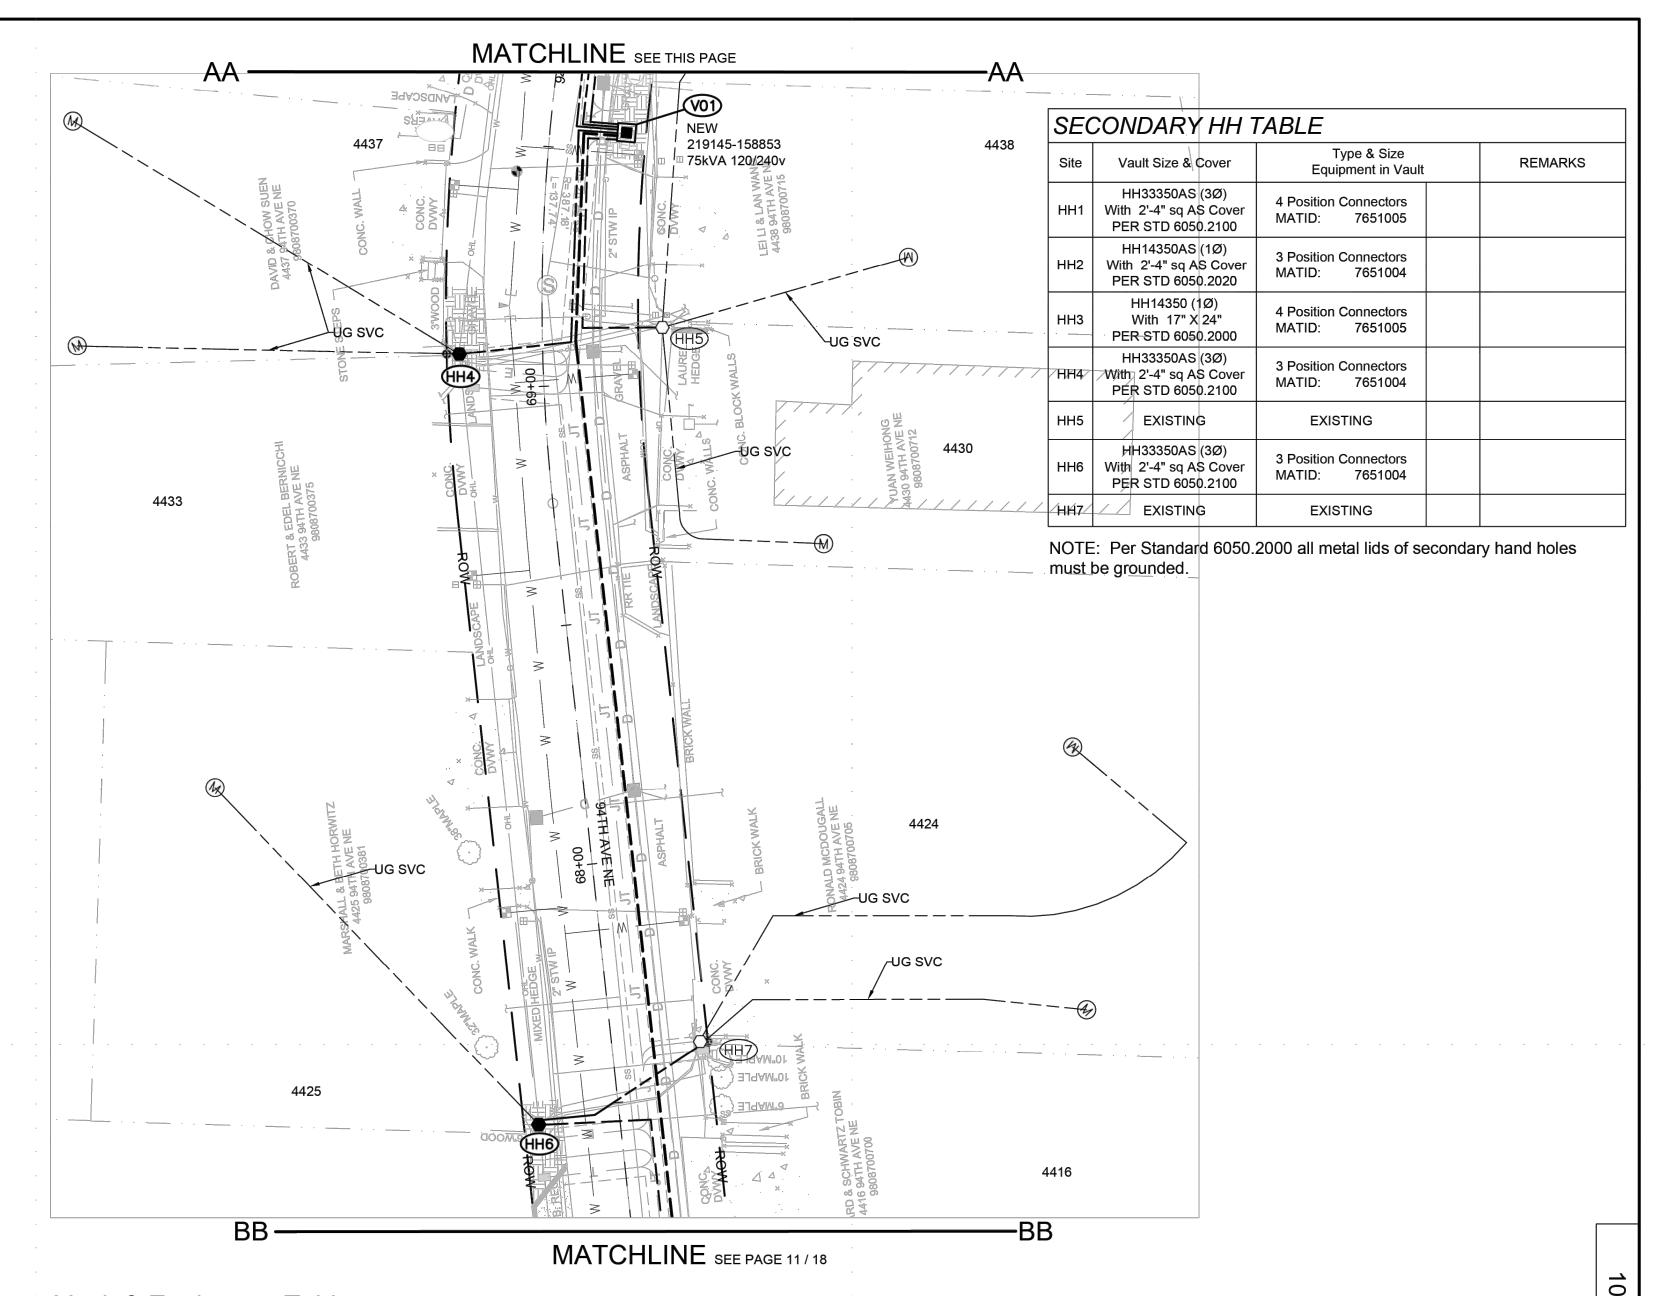

## Vault & Equipment Table

Site	Approximate Station & Offset From VIt Center	Grid Number	Vault Size & Cover	Type & Size Equipment In Vault	LB DC I		Transformer ID Numbers (Company ID)	ASBUILT INFORMATION Foreman-Complete
V01	STA 69+54.9 15.8 RT	219145 158853	Anti-Skid 4'-8"SQ x 7'-6" TUT Unistrut HH TUT1SLA (LOOP) PER STD 6045.7000	75kVA 120/240v MID: 6237150				

## SITE NOTES

AT HH1

NEW SECONDARY HANDHOLE
INTERCEPT EXISTING UG SERVICE AT 4467, 4623 & 4646 & EXTEND CABLE/CONDUIT TO HH1

AT HH2
NEW SECONDARY HANDHOLE
CUSTOMER TO INSTALL NEW UG SERVICE AT 4468 & 4619

## AT HH3

NEW SECONDARY HANDHOLE
INTERCEPT EXISTING UG SERVICE AT 4444, 4441 & 4439 & EXTEND CABLE/CONDUIT TO HH3

NEW SECONDARY HANDHOLE
INTERCEPT EXISTING UG SERVICE AT 4437 & 4433 & EXTEND CABLE/CONDUIT TO HH4

AT HH5
EXISTING SECONDARY HANDHOLE AND CONNECTIONS TO REMAIN

## AT HH6

NEW SECONDARY HANDHOLE
INTERCEPT EXISTING UG SERVICE AT 4425 & EXTEND CABLE/CONDUIT TO HH6

AT HH7
EXISTING SECONDARY HANDHOLE AND CONNECTIONS TO REMAIN

AT IP1 & IP2
INTERCEPT EXISTING UG TPX AND EXTEND TO HH1

										1	
								ĺ	N/A	YARROW F	OINT
3							FUNCT	ION	CONTACT	PHONE NO	DATE
2							PROJE	CT MGR	KIARA SKYE	425-213-9205	10/13/23
1						ENGR -	POWER	KYLE HAYS	206-930-8544	10/13/23	
REV#	DATE	BY	DES	CRIPTIO	N		ENGR -	GAS	N/A	N/A	N/A
JNTY		Emer Sect	Gas	Wk Ctr	POWER	WK CTR	DRAW	N BY	HOLLY SOREM	253-208-8843	10/13/23
KING N/A			N/A	CSPFEPI		CHECKED BY		Kyle Hays	(206) 930-8544	10/13/23	
SEC	OP MAP PLAT MAP		APPRO	VED BY							
S18,19 2	5 05E	N/	Ά			N/A	FOREM	1AN #1			
AP NO (F	POWER)	ОН СКТ МА	·P	UG CKT	MAP	CIRCUIT NO	FOREM	1AN #2			
A2505E0	72,73	D2505E0	76	R2505E	072,73	MED-33	MAPPII	NG			
					JOIN	T FACILITIES AF	RRANGE	MENTS			
	UTILITIES N/A N/A			N/A	N/A			N/A			
(	CONTACT		N/A			N/A			N/A	N/A	
PHONE# N/A N/A						N/A	N/A				
	DUC									INCIDENT	MAOP

REAL ESTATE/EASEMENT



N/A N/A

Gas Order Elect Order
N/A 101149280 94TH AVE NE YARROW POINT SCHEDULE 74 4467 94TH AVE NE YARROW POINT, 98004 DRAWING: PSE 10 AS NOTED 10 / 18

AT HH8
EXISTING SECONDARY HANDHOLE AND CONNECTIONS TO REMAIN

AT HH9 NEW SECONDARY HANDHOLE

INTERCEPT EXISTING UG SERVICE AT 4405 & EXTEND CABLE/CONDUIT TO HH9
INTERCEPT EXISTING UG RUN TO HH10 EXTEND CABLE/CONDUIT TO HH9

AT HH10
EXISTING SECONDARY HANDHOLE AND CONNECTIONS TO REMAIN

AT HH11
NEW SECONDARY HANDHOLE
INTERCEPT EXISTING UG SERVICE AT 4402 & 4236 & EXTEND CABLE/CONDUIT TO HH11
CUSTOMER TO INSTALL NEW UG SERVICE AT 4230

AT HH12
NEW SECONDARY HANDHOLE
INTERCEPT EXISTING UG SERVICE AT 4225 & 4215 & EXTEND CABLE/CONDUIT TO HH12

## **AT HH13**

NEW SECONDARY HANDHOLE
INTERCEPT EXISTING UG SERVICE AT 4218 & EXTEND CABLE/CONDUIT TO HH13
INTERCEPT EXISTING UG RUN TO HH14 EXTEND CABLE/CONDUIT TO HH13

## **AT HH14**

EXISTING SECONDARY HANDHOLE AND CONNECTIONS TO REMAIN

SEC	CONDARY HH	TABLE	
Site	Vault Size & Cover	Type & Size Equipment in Vault	REMARKS
HH8	EXISTING	EXISTING	
НН9	HH14350AS (1Ø) With 2'-4" sq AS Cover PER STD 6050.2020	4 Position Connectors MATID: 7651005	
HH10	EXISTING	EXISTING	
HH11	HH33350AS (3Ø) With 2'-4" sq AS Cover PER STD 6050.2100	4 Position Connectors MATID: 7651005	
HH12	HH33350AS (3Ø) With 2'-4" sq AS Cover PER STD 6050.2100	3 Position Connectors MATID: 7651004	
HH13	HH33350AS (3Ø) With 2'-4" sq AS Cover PER STD 6050.2100	3 Position Connectors MATID: 7651004	


NOTE: Per Standard 6050.2000 all metal lids of secondary hand holes must be grounded.

**EXISTING** 

**EXISTING** 

## Vault & Equipment Table

Site	Approximate Station & Offset From Vlt Center	Grid Number	Vault Size & Cover	Type & Size Equipment In Vault	LB DC		Transformer ID Numbers (Company ID)	ASBUILT INFORMATION Foreman-Complete
V02	STA 65+37.2 14.8 RT	219103 158857	Anti-Skid 4'-8"SQ x 7'-6" TUT Unistrut HH TUT1SLA (LOOP) PER STD 6045.7000	100kVA 120/240v MID: 6237200				

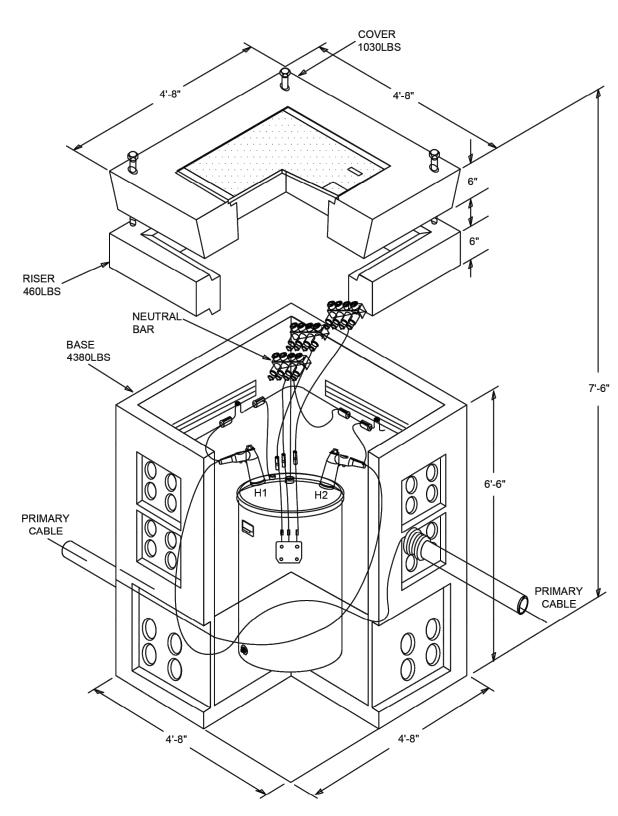

SINGLE PHASE TUT DETAIL AT V01 & V02

							REAL E	STATE/EA	SEMENT	PERMIT	
								Ī	N/A	YARROW	POINT
3							FUNCT	ION	CONTACT	PHONE NO	DATE
2							PROJE	CT MGR	KIARA SKYE	425-213-9205	5 10/13/23
1							ENGR -	POWER	KYLE HAYS	206-930-8544	10/13/23
REV#	DATE	BY	DES	CRIPTIO	N		ENGR -	GAS	N/A	N/A	N/A
YTNUC	NTY Emer Sect Gas Wk Ctr POWER WK CTR		DRAWN BY		HOLLY SOREM	253-208-8843	3 10/13/23				
KING		N/A		N/A		CSPFEPI	CHECK	ED BY	Kyle Hays	(206) 930-854	4 10/13/23
4 SEC		OP MAP			PLAT MAP		APPRO	VED BY			
S18,19 2	5 05E	N/	Α			N/A	FOREM	1AN #1			
MAP NO (F	POWER)	ОН СКТ МА	.P	UG CKT	MAP	CIRCUIT NO	FOREMAN #2				
A2505E0	72,73	D2505E07	76	R2505	E072,73	MED-33	MAPPI	NG			
					JOIN	IT FACILITIES AI	RRANGE	MENTS			
UTILITIES N/A			N/A		N/A		N/A	١			
(	CONTACT		N/A			N/A			N/A	N/A	١
	PHONE#		N/A			N/A			N/A	N/A	1
				•						INCIDENT	MAOP

PSE SOUND ENERGY

INCIDENT MAOP
N/A N/A

Gas Order Elect Order
N/A 101149280 94TH AVE NE YARROW POINT SCHEDULE 74 4467 94TH AVE NE YARROW POINT, 98004 SCALE PAGE
AS NOTED 11 / 18 DRAWING: PSE 11

MATCHLINE SEE PAGE 11 / 18


## SITE NOTES

AT HH15
NEW SECONDARY HANDHOLE
INTERCEPT EXISTING UG SERVICE AT 4205, 4208 & 4200 & EXTEND CABLE/CONDUIT TO HH15

AT HH16
NEW SECONDARY HANDHOLE
INTERCEPT EXISTING UG SERVICE AT 4031, 4024 & 4025 & EXTEND CABLE/CONDUIT TO HH16
CUSTOMER TO CONNECT UG SERVICE AT 4020 & EXTEND CABLE/CONDUIT TO HH16


SECONDARY HH TABLE											
Site	Vault Size & Cover	Type & Size Equipment in Vault	REMARKS								
HH15	HH14350AS (1Ø) With 2'-4" sq AS Cover PER STD 6050.2020	4 Position Connectors MATID: 7651005									
HH16	HH16500AS (1Ø) HH 233 VAULT PER STD 6050.2020	6 Position Connectors MATID: 7651101									

NOTE: Per Standard 6050.2000 all metal lids of secondary hand holes must be grounded.

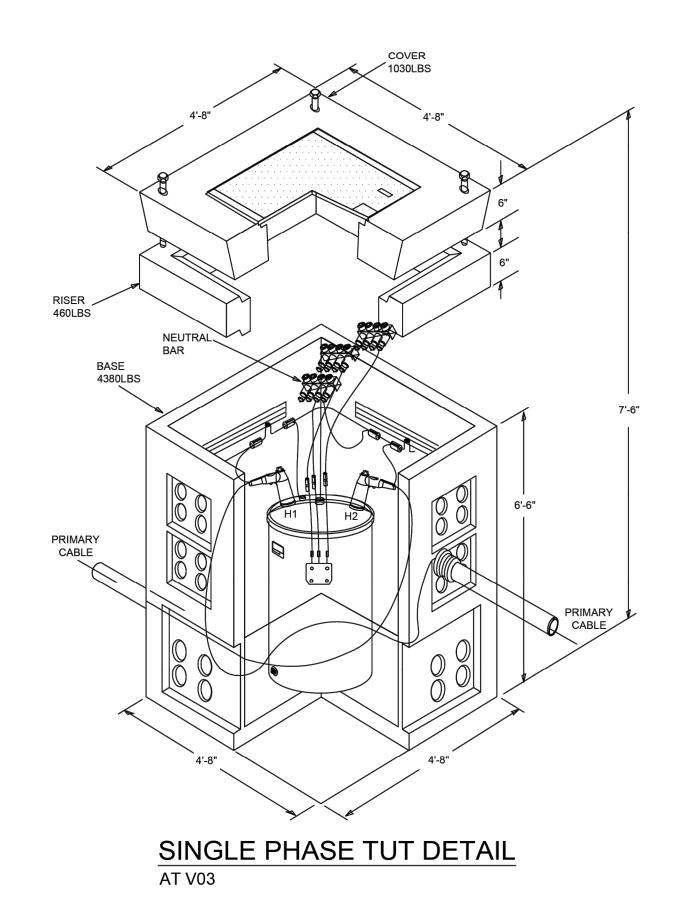

REAL ESTATE/EASEMENT									PERMIT	
						```		N/A	YARROW	/ POINT
3						FUNCT		CONTACT	PHONE NO	DATE
2						PROJECT MGR		KIARA SKYE	425-213-920	
1						ENGR - POWER		KYLE HAYS	206-930-854	1 10/13/23
REV#	DATE	BY	DESCRIPTION			ENGR -	GAS	N/A	N/A	N/A
JNTY		Emer Sect	Gas Wk Ctr POWER WK CTR		DRAWN	I BY	HOLLY SOREM	253-208-884	3 10/13/23	
KING	3	N/A N/A CSPFEPI		CSPFEPI	CHECK	CHECKED BY Kyle Hays		(206) 930-854	14 10/13/23	
SEC		OP MAP PLAT MAP		IAP	APPRO	VED BY				
S18,19 2	25 05E N/A				N/A	FOREMAN #1				
AP NO (P	POWER)	ОН СКТ МА	P UG CKT	MAP	CIRCUIT NO	FOREM	AN #2			
A2505E0	72,73	D2505E07	76 R2505	E072,73	MED-33	MAPPIN	lG			
				JOIN	IT FACILITIES AR	RANGE	MENTS			
ı	UTILITIES		N/A		N/A	N/A			N/A	
C	CONTACT		N/A		N/A	N/A			N/A	
	PHONE#		N/A		N/A			N/A	N/A	
	PUGET 94TH AVE NE YAR							IT	INCIDENT N/A	MAOP N/A
PSE)	SOU				SCHEDULE				Gas Order N/A	Elect Order 101149280
<b>ENERGY</b> 4467 94TH AVE NE YARRO							, 98004		SCALE	PAGE
DRAWING: PSE 12										12 / 18

PSE SOUND ENERGY

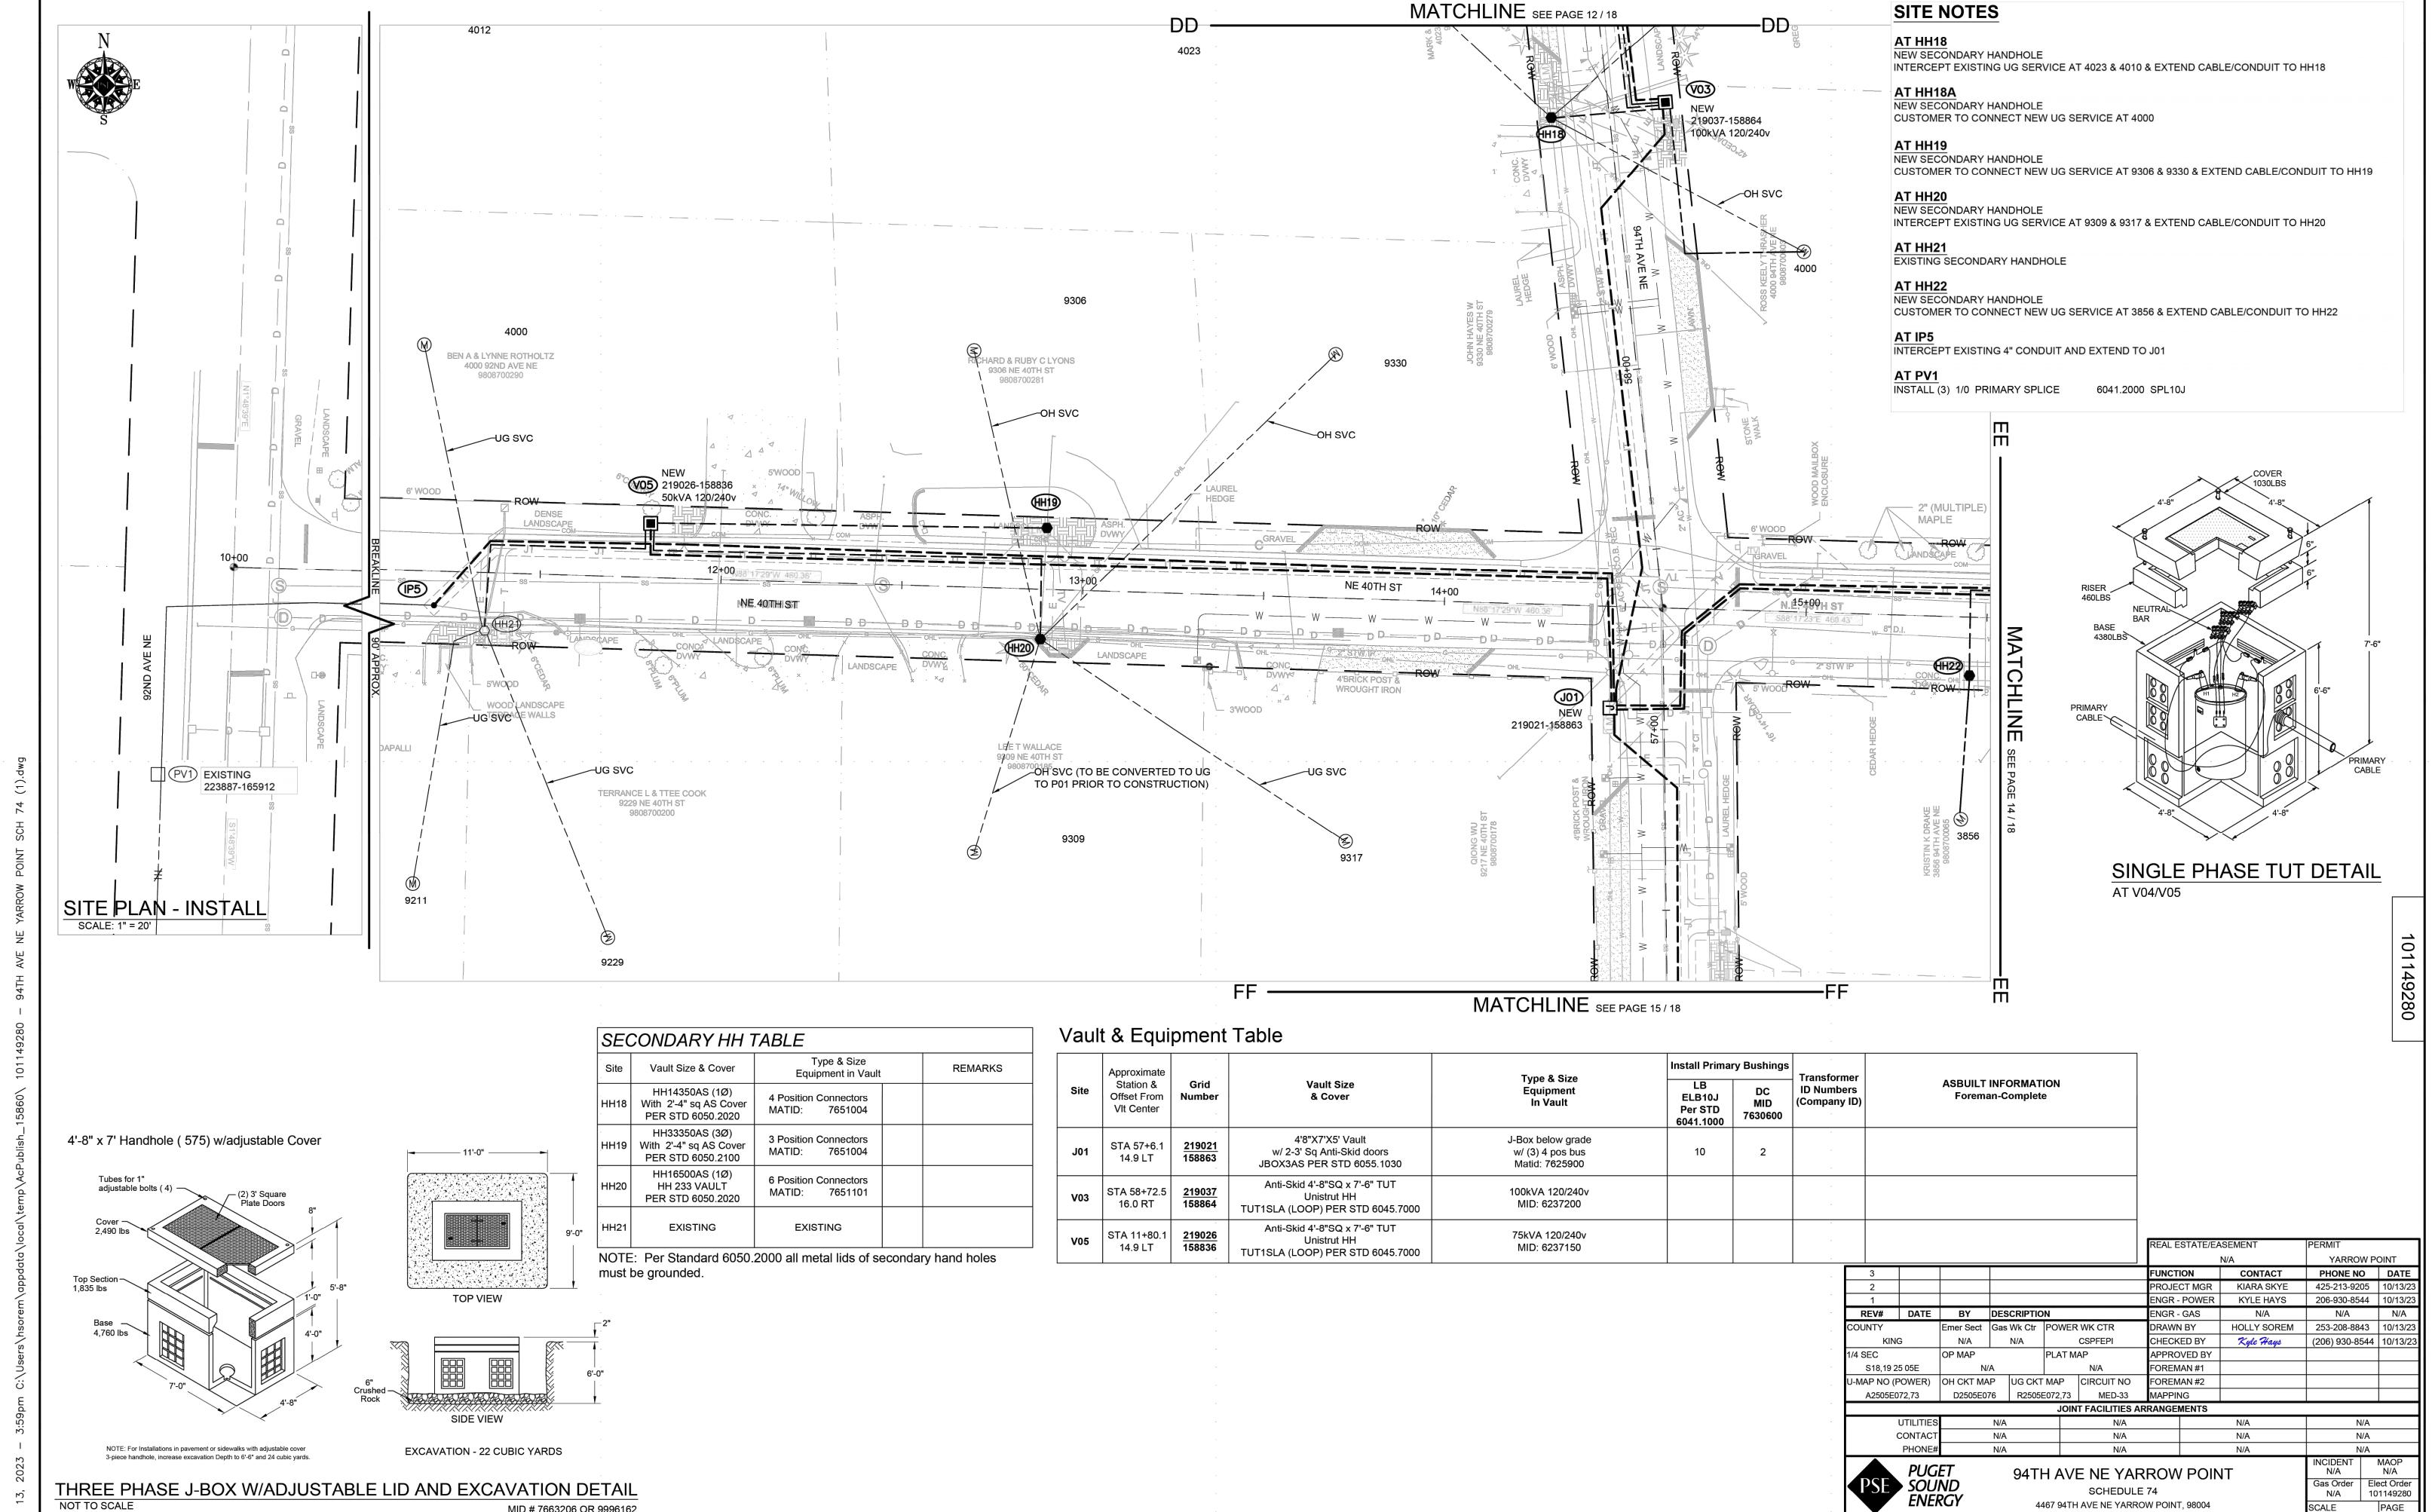

SCHEDULE 74

4467 94TH AVE NE YARROW POINT, 98004 DRAWING: PSE 13

N/A 101149280

AS NOTED 13 / 18

NOT TO SCALE

## Vault & Equipment Table

Site	Approximate Station & Offset From VIt Center	Grid Number	Vault Size & Cover	Type & Size Equipment In Vault		DC MID 7630600	Transformer ID Numbers (Company ID)	ASBUILT INFORMATION Foreman-Complete
V04	STA 17+24.3 15.4 LT	<u>219024</u> 158888	Anti-Skid 4'-8"SQ x 7'-6" TUT Unistrut HH TUT1SLA (LOOP) PER STD 6045.7000	50kVA 120/240v MID: 6237100				

## SITE NOTES

**AT HH23** 

NEW SECONDARY HANDHOLE
INTERCEPT EXISTING UG SERVICE AT 9410 & EXTEND CABLE/CONDUIT TO HH23
CUSTOMER TO CONNECT NEW UG SERVICE AT 9415

AT HH24

**AT P18** 

NEW SECONDARY HANDHOLE INTERCEPT EXISTING UG SERVICE AT 4015, 9421 & 9429 & EXTEND CABLE/CONDUIT TO HH24

EXISTING POLE TO REMAIN
INSTALL 1Ø UG TO OH TERM
INSTALL SW:\_\_\_\_\_, FUSE AT 40T
INSTALL (1) 4" RISER

6043.1001, UTSU1LB

6042.1000, RIS4CSS

SEC	CONDARY HH 7	TABLE	
Site	Vault Size & Cover	Type & Size Equipment in Vault	REMARKS
HH22	HH14350AS (1Ø) With 2'-4" sq AS Cover PER STD 6050.2020	3 Position Connectors MATID: 7651004	
HH23	HH33350AS (3Ø) With 2'-4" sq AS Cover PER STD 6050.2100	3 Position Connectors MATID: 7651004	
HH24	HH33350AS (3Ø) With 2'-4" sq AS Cover PER STD 6050.2100	4 Position Connectors MATID: 7651005	

NOTE: Per Standard 6050.2000 all metal lids of secondary hand holes must be grounded.


							REAL E	STATE/EA	PERMIT		
								1	N/A	YARROW	POINT
3							FUNCT	ION	CONTACT	PHONE NO	DATE
2							PROJE	CT MGR	KIARA SKYE	425-213-9205	10/13/23
1							ENGR -	POWER	KYLE HAYS	206-930-8544	10/13/23
REV#	DATE	BY	DES	CRIPTIO	N		ENGR -	GAS	N/A	N/A	N/A
YTNUC		Emer Sect Gas Wk Ctr POWER WK CTR		DRAWN BY		HOLLY SOREM	253-208-8843	10/13/23			
KING		N/A		N/A	CSPFEPI		CHECKED BY		Kyle Hays	(206) 930-854	1 10/13/23
4 SEC		OP MAP			PLAT M	IAP	APPRO	VED BY			
S18,19 2	5 05E	N/.	Α		N/A			IAN #1			
MAP NO (P	OWER)	ОН СКТ МА	P	UG CKT	MAP	CIRCUIT NO	FOREMAN #2				
A2505E0	72,73	D2505E07	76	R2505E	072,73	MED-33	MAPPI	NG			
					JOIN	IT FACILITIES AR	RANGE	MENTS			
UTILITIES N/A N/A			N/A			N/A	N/A				
(	CONTACT		N/A			N/A			N/A	N/A	
	PHONE#		N/A			N/A			N/A	N/A	
										INCIDENT	MAOP

PSE SOUND ENERGY

INCIDENT MAOP
N/A

Gas Order Elect Order
101149280

SCALE PAGE
AS NOTED 14 / 18 94TH AVE NE YARROW POINT SCHEDULE 74 4467 94TH AVE NE YARROW POINT, 98004 DRAWING: PSE 14

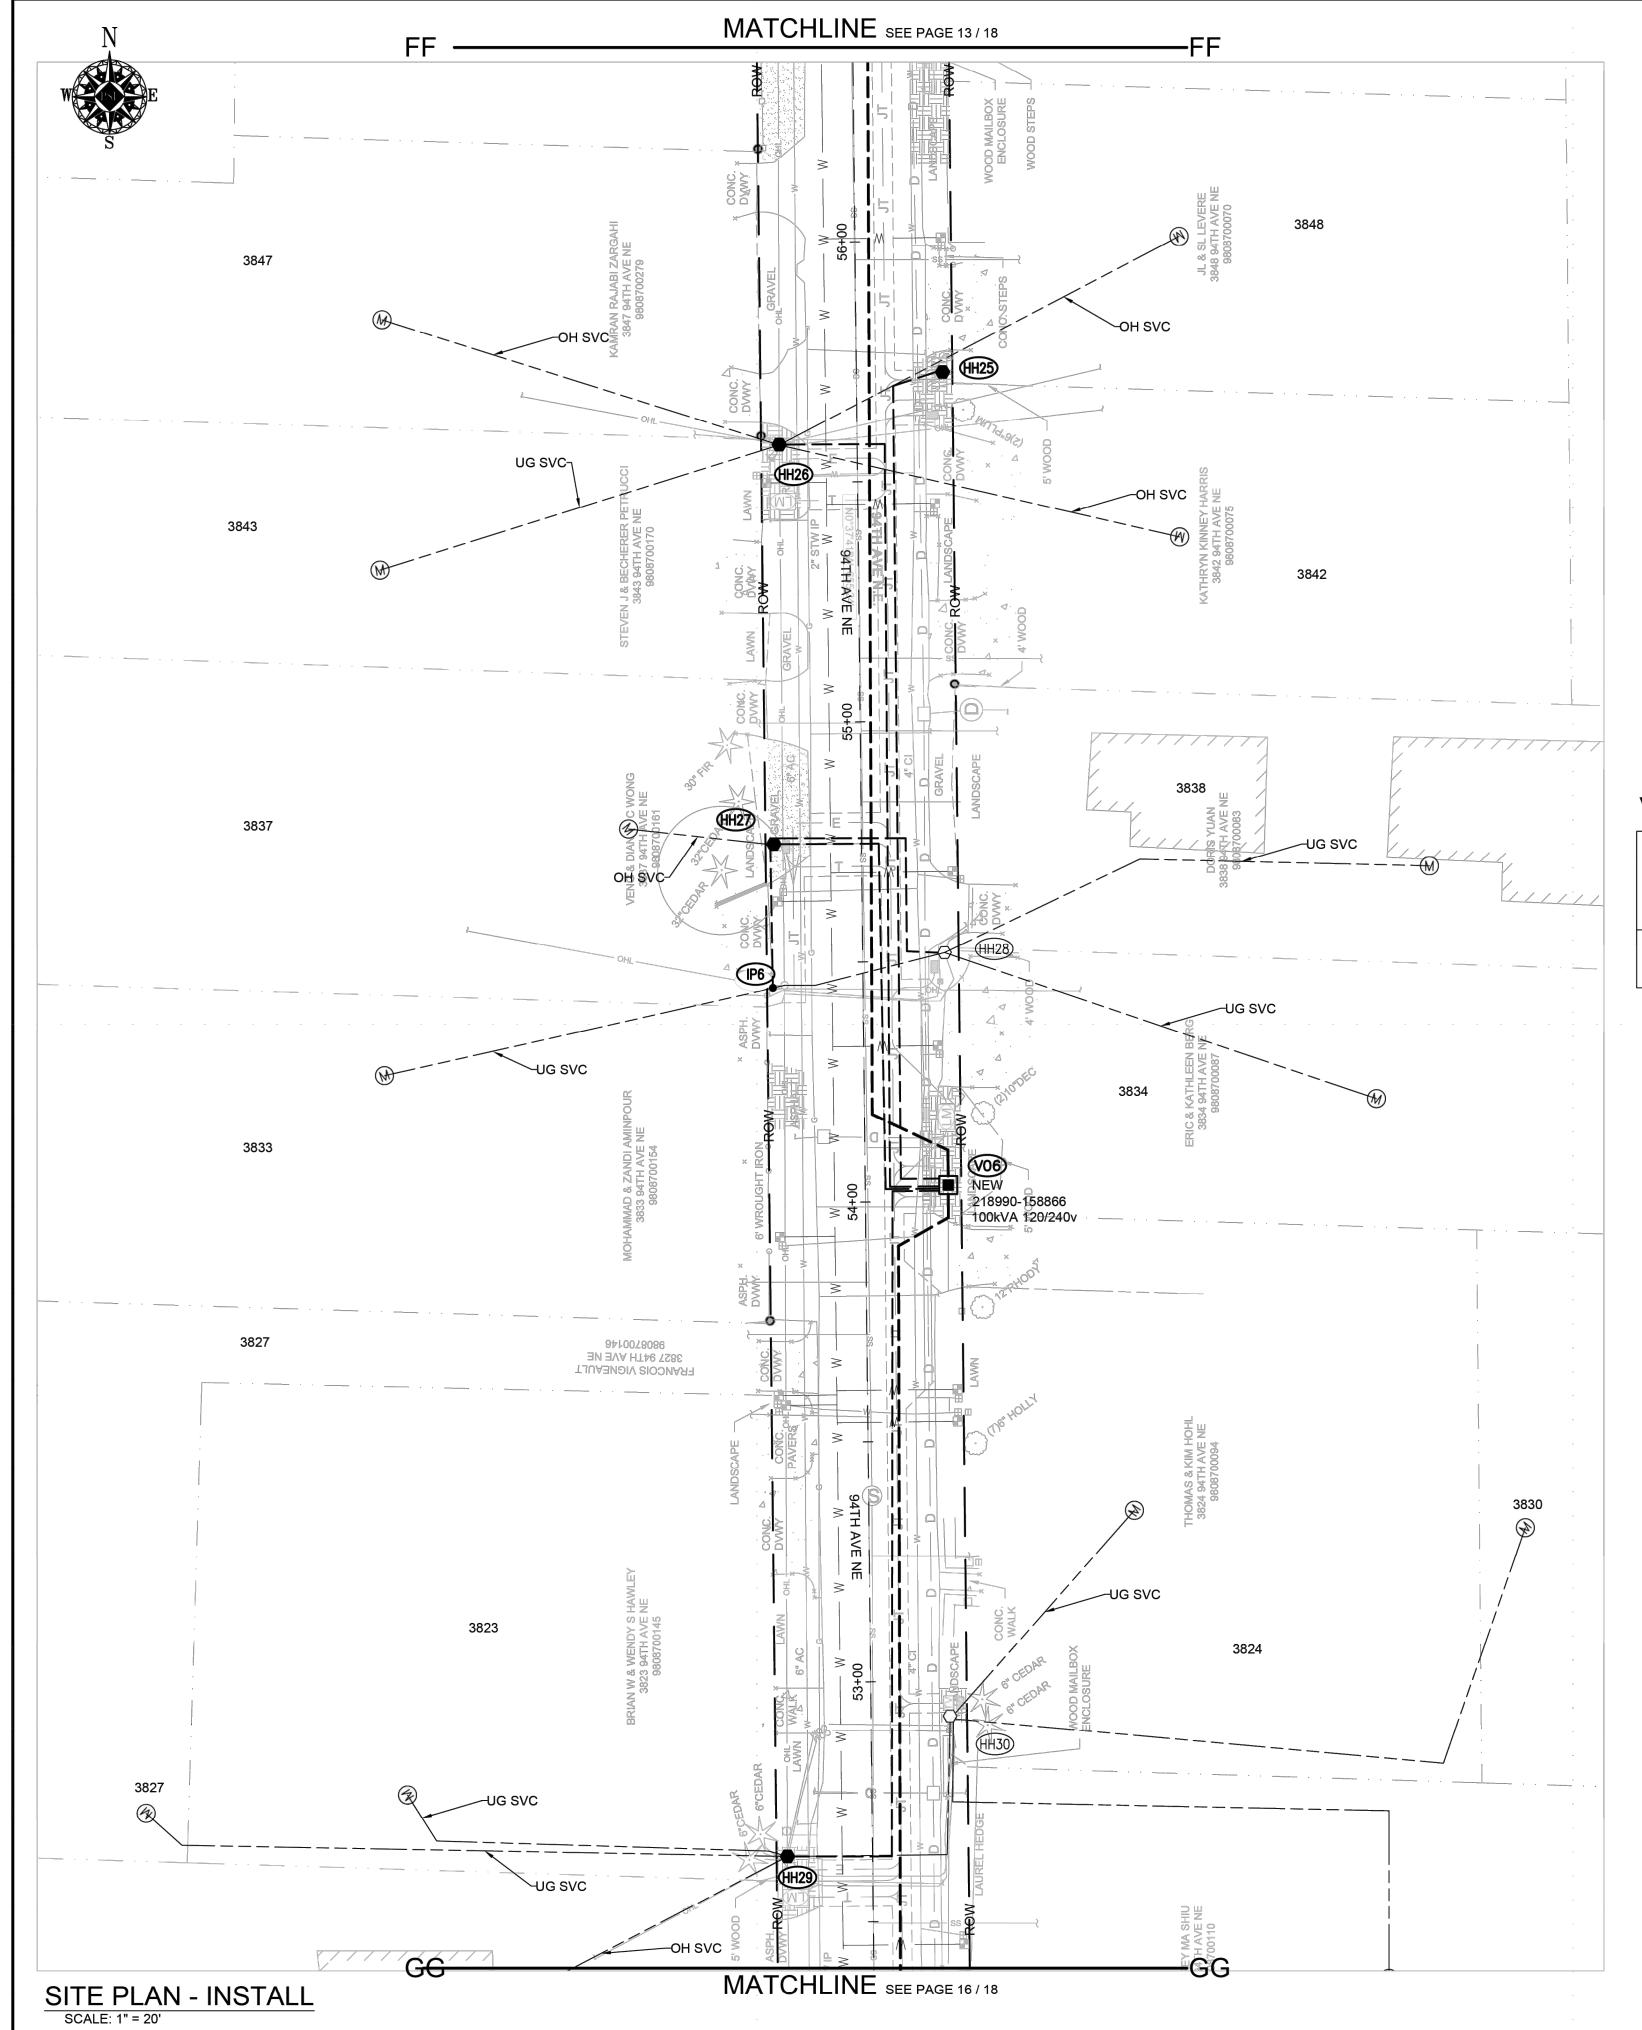

SEC	CONDARY HH T	TABLE	
Site	Vault Size & Cover	Type & Size Equipment in Vault	REMARKS
HH25	HH14350AS (1Ø) With 2'-4" sq AS Cover PER STD 6050.2020	3 Position Connectors MATID: 7651004	
HH26	HH33350AS (3Ø) With 2'-4" sq AS Cover PER STD 6050.2100	3 Position Connectors MATID: 7651004	
HH27	HH33350AS (3Ø) With 2'-4" sq AS Cover PER STD 6050.2100	3 Position Connectors MATID: 7651004	
HH28	EXISTING	EXISTING	
HH29	HH33350AS (3Ø) With 2'-4" sq AS Cover PER STD 6050.2100	4 Position Connectors MATID: 7651004	
HH30	EXISTING	EXISTING	

NOTE: Per Standard 6050.2000 all metal lids of secondary hand holes must be grounded.

## SITE NOTES

AT HH25

NEW SECONDARY HANDHOLE
CUSTOMER TO CONNECT NEW UG SERVICE AT 3848 & 3842

AT HH26
NEW SECONDARY HANDHOLE
INTERCEPT EXISTING UG SERVICE AT 3843 & EXTEND CABLE/CONDUIT TO HH26
CUSTOMER TO CONNECT NEW UG SERVICE AT 3847

AT HH27
NEW SECONDARY HANDHOLE
CUSTOMER TO CONNECT NEW UG SERVICE AT 3837

AT IP6
INTERCEPT EXISTING UG SERVICE AT 3833 & EXTEND CABLE/CONDUIT TO HH27

AT HH28

EXISTING SECONDARY HANDHOLE
INTERCEPT EXISTING UG SERVICE AT 3838 & 3834 & EXTEND CABLE/CONDUIT TO HH28

**AT HH29** 


NEW SECONDARY HANDHOLE
INTERCEPT EXISTING UG SERVICE AT 3823 & 3827 & EXTEND CABLE/CONDUIT TO HH29
CUSTOMER TO CONNECT NEW UG SERVICE AT 3813

**AT HH30** 

EXISTING SECONDARY HANDHOLE
INTERCEPT EXISTING UG SERVICE AT 3824, 3830 & 3812 & EXTEND CABLE/CONDUIT TO HH30

## Vault & Equipment Table

I SITA I			Type & Size	Install Prima	ry Bushings	Transformer		
Site		Grid Number	Vault Size & Cover	Equipment In Vault	LB ELB10J Per STD 6041.1000	DC MID 7630600	ID Numbers (Company ID)	ASBUILT INFORMATION Foreman-Complete
V06	STA 54+3.3 17.2 RT	218990 158866	Anti-Skid 4'-8"SQ x 7'-6" TUT Unistrut HH TUT1SLA (LOOP) PER STD 6045.7000	100kVA 120/240v MID: 6237200				

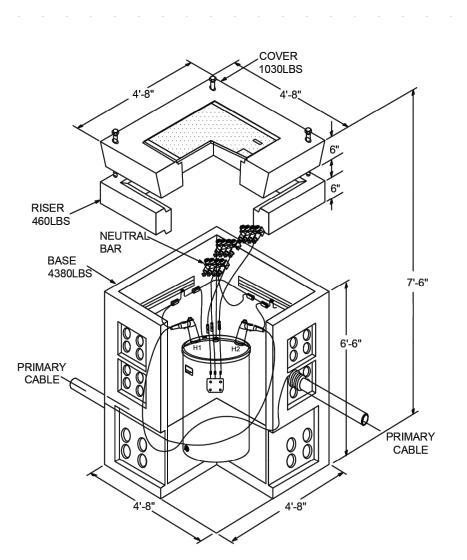


## SINGLE PHASE TUT DETAIL AT V06, V07


							REAL E	STATE/EA	SEMENT	PERMIT	
									V/A	YARROW	POINT
3							FUNCT	ION	CONTACT	PHONE NO	DATE
2							PROJE	CT MGR	KIARA SKYE	425-213-920	5 10/13/23
1				ESCRIPTION				POWER	KYLE HAYS	206-930-854	10/13/23
REV#	DATE	BY	DESCF	RIPTION	1		ENGR -	GAS	N/A	N/A	N/A
COUNTY						WK CTR	DRAWN	N BY	HOLLY SOREM	253-208-884	3 10/13/23
KING	€	N/A	N/.	/A		CSPFEPI	CHECK	ED BY	Kyle Hays	(206) 930-854	14 10/13/23
/4 SEC			PLAT M	AP	APPRO	VED BY					
S18,19 2	5 05E	N/	Ά			N/A	FOREM	1AN #1			
J-MAP NO (P	OWER)	ОН СКТ МА	P U	G CKT I	MAP	CIRCUIT NO	FOREM	1AN #2			
A2505E0	72,73	D2505E07	76 F	R2505E	072,73	MED-33	MAPPI	NG			
					JOIN	T FACILITIES AF	RANGE	MENTS			
UTILITIES N/A						N/A			N/A	N//	4
CONTACT N/A					N/A			N/A	N//	4	
	PHONE#		N/A			N/A			N/A	N//	4
	DI IC	FT .		) 4 T I	I A\/I			/ DOIN	· <b>T</b>	INCIDENT N/A	MAOP N/A

PSE SOUND ENERGY

N/A N/A

Gas Order Elect Order
N/A 101149280 94TH AVE NE YARROW POINT SCHEDULE 74 4467 94TH AVE NE YARROW POINT, 98004 DRAWING: PSE 15 AS NOTED 15 / 18

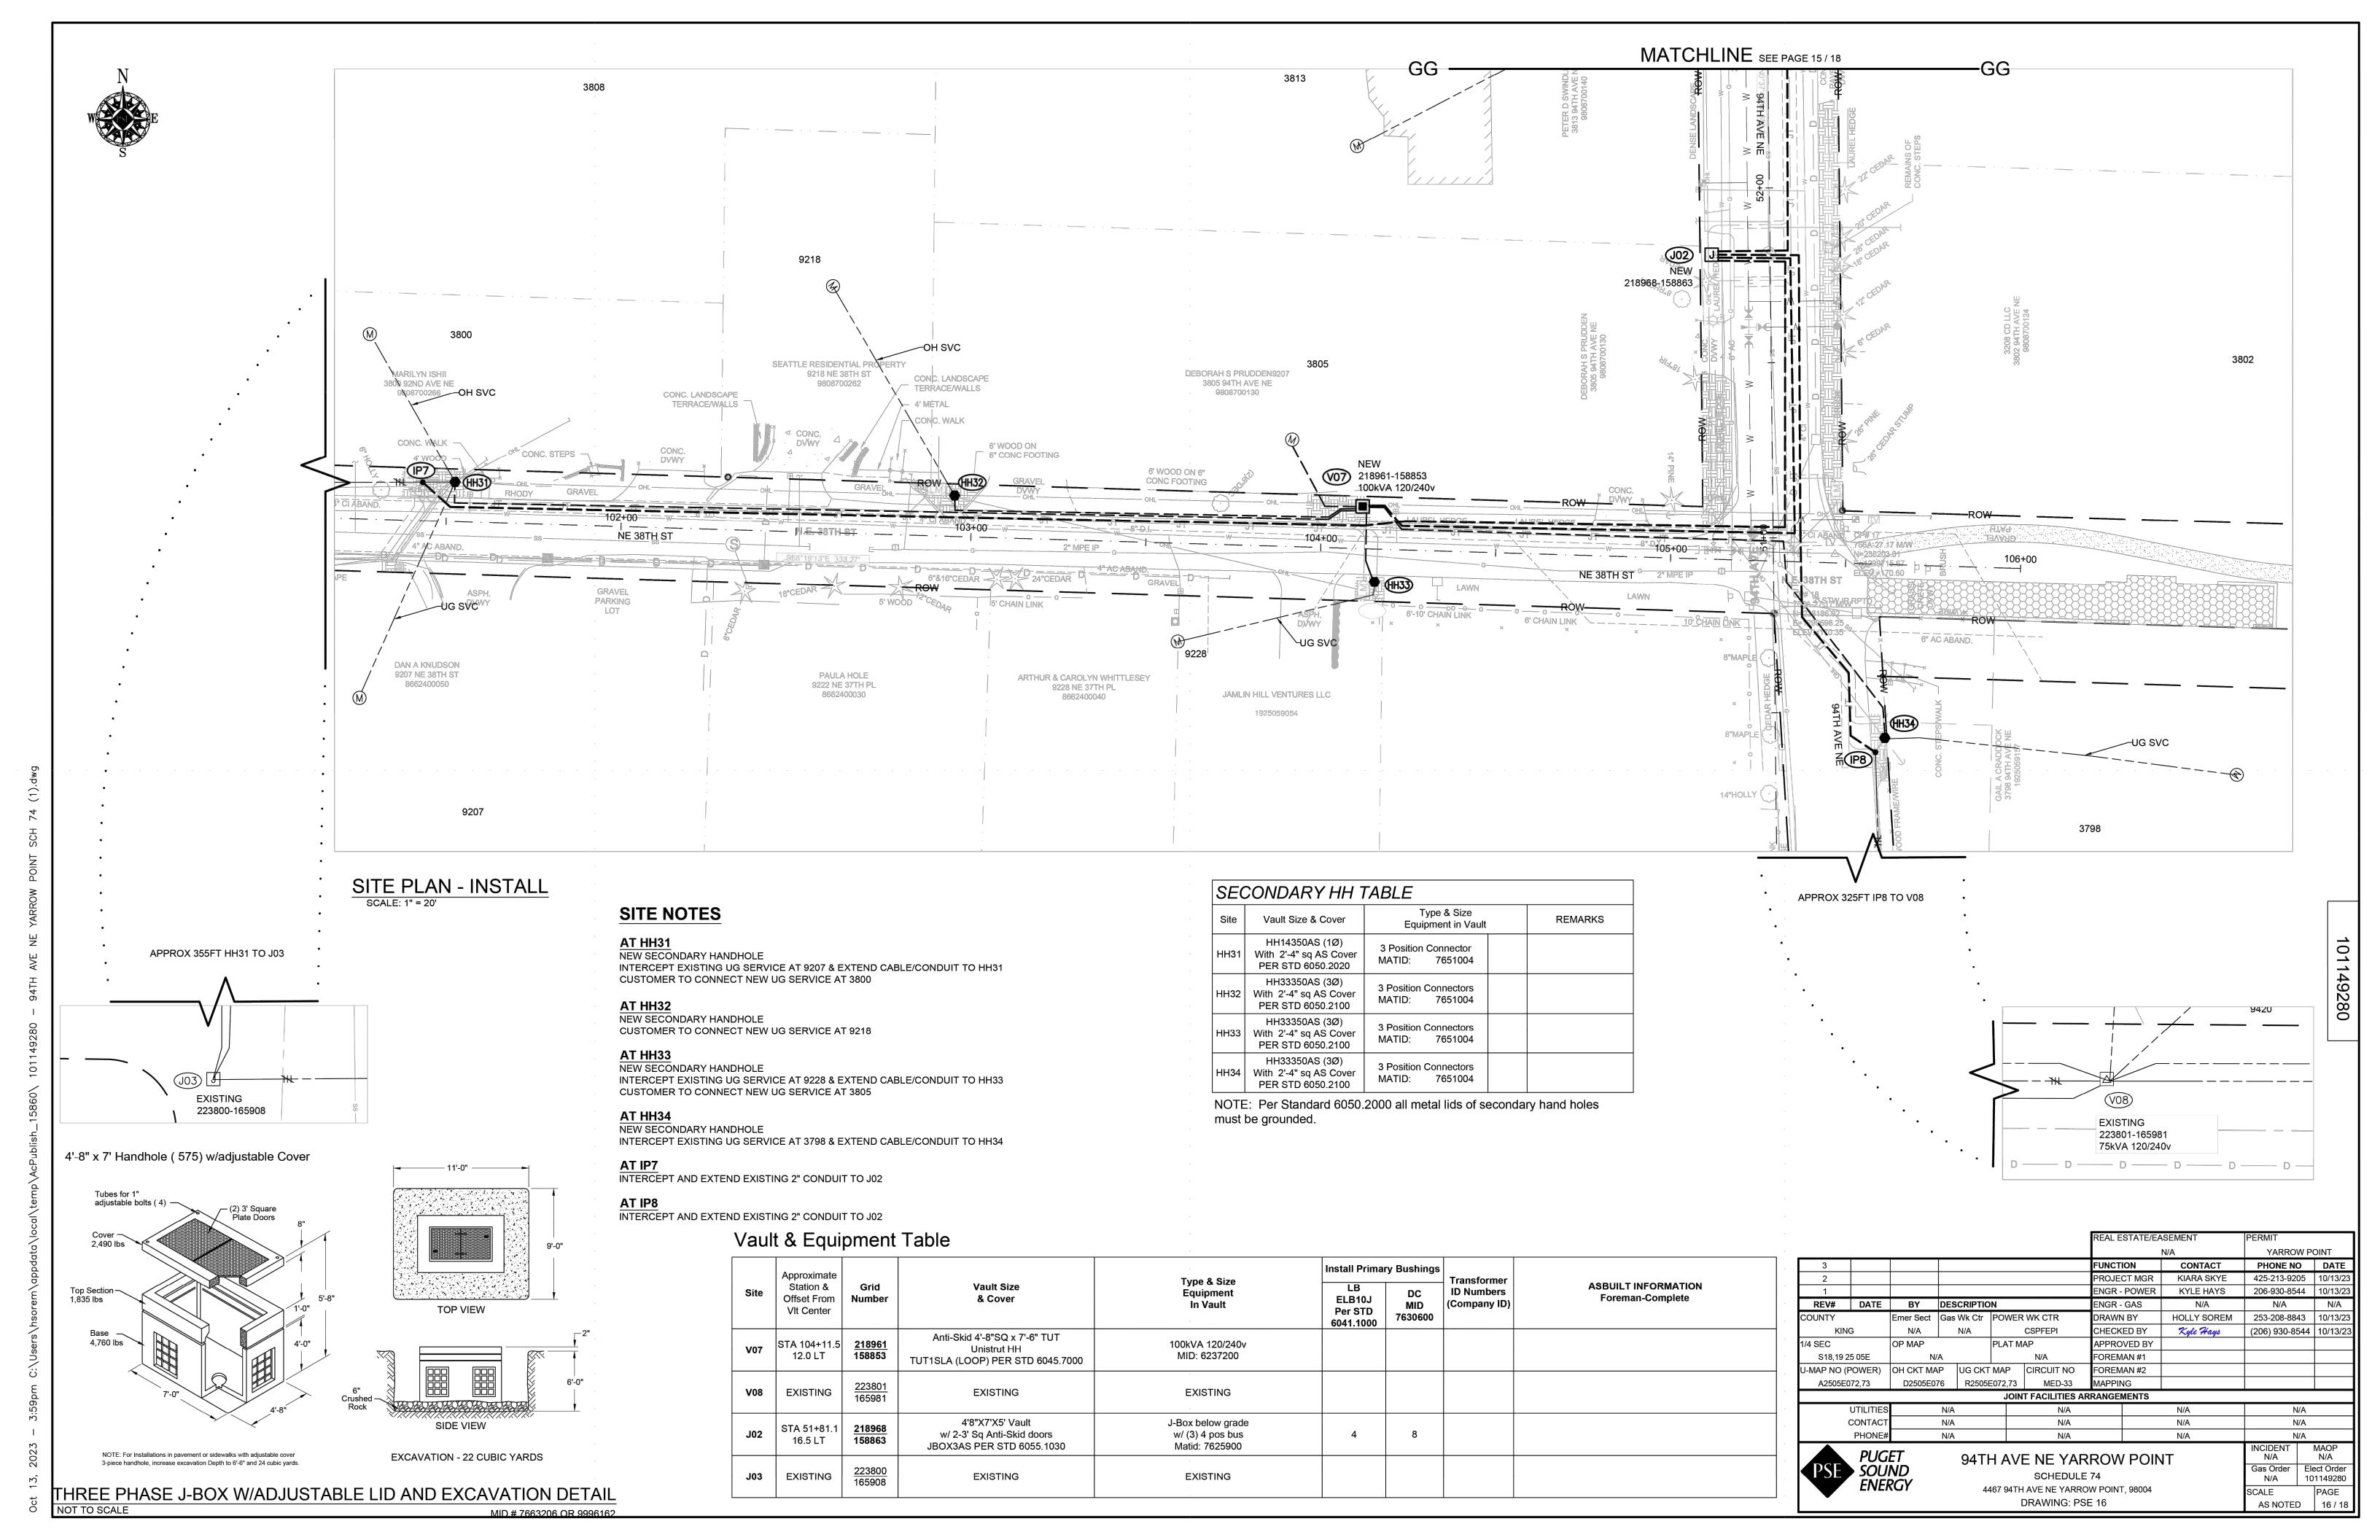

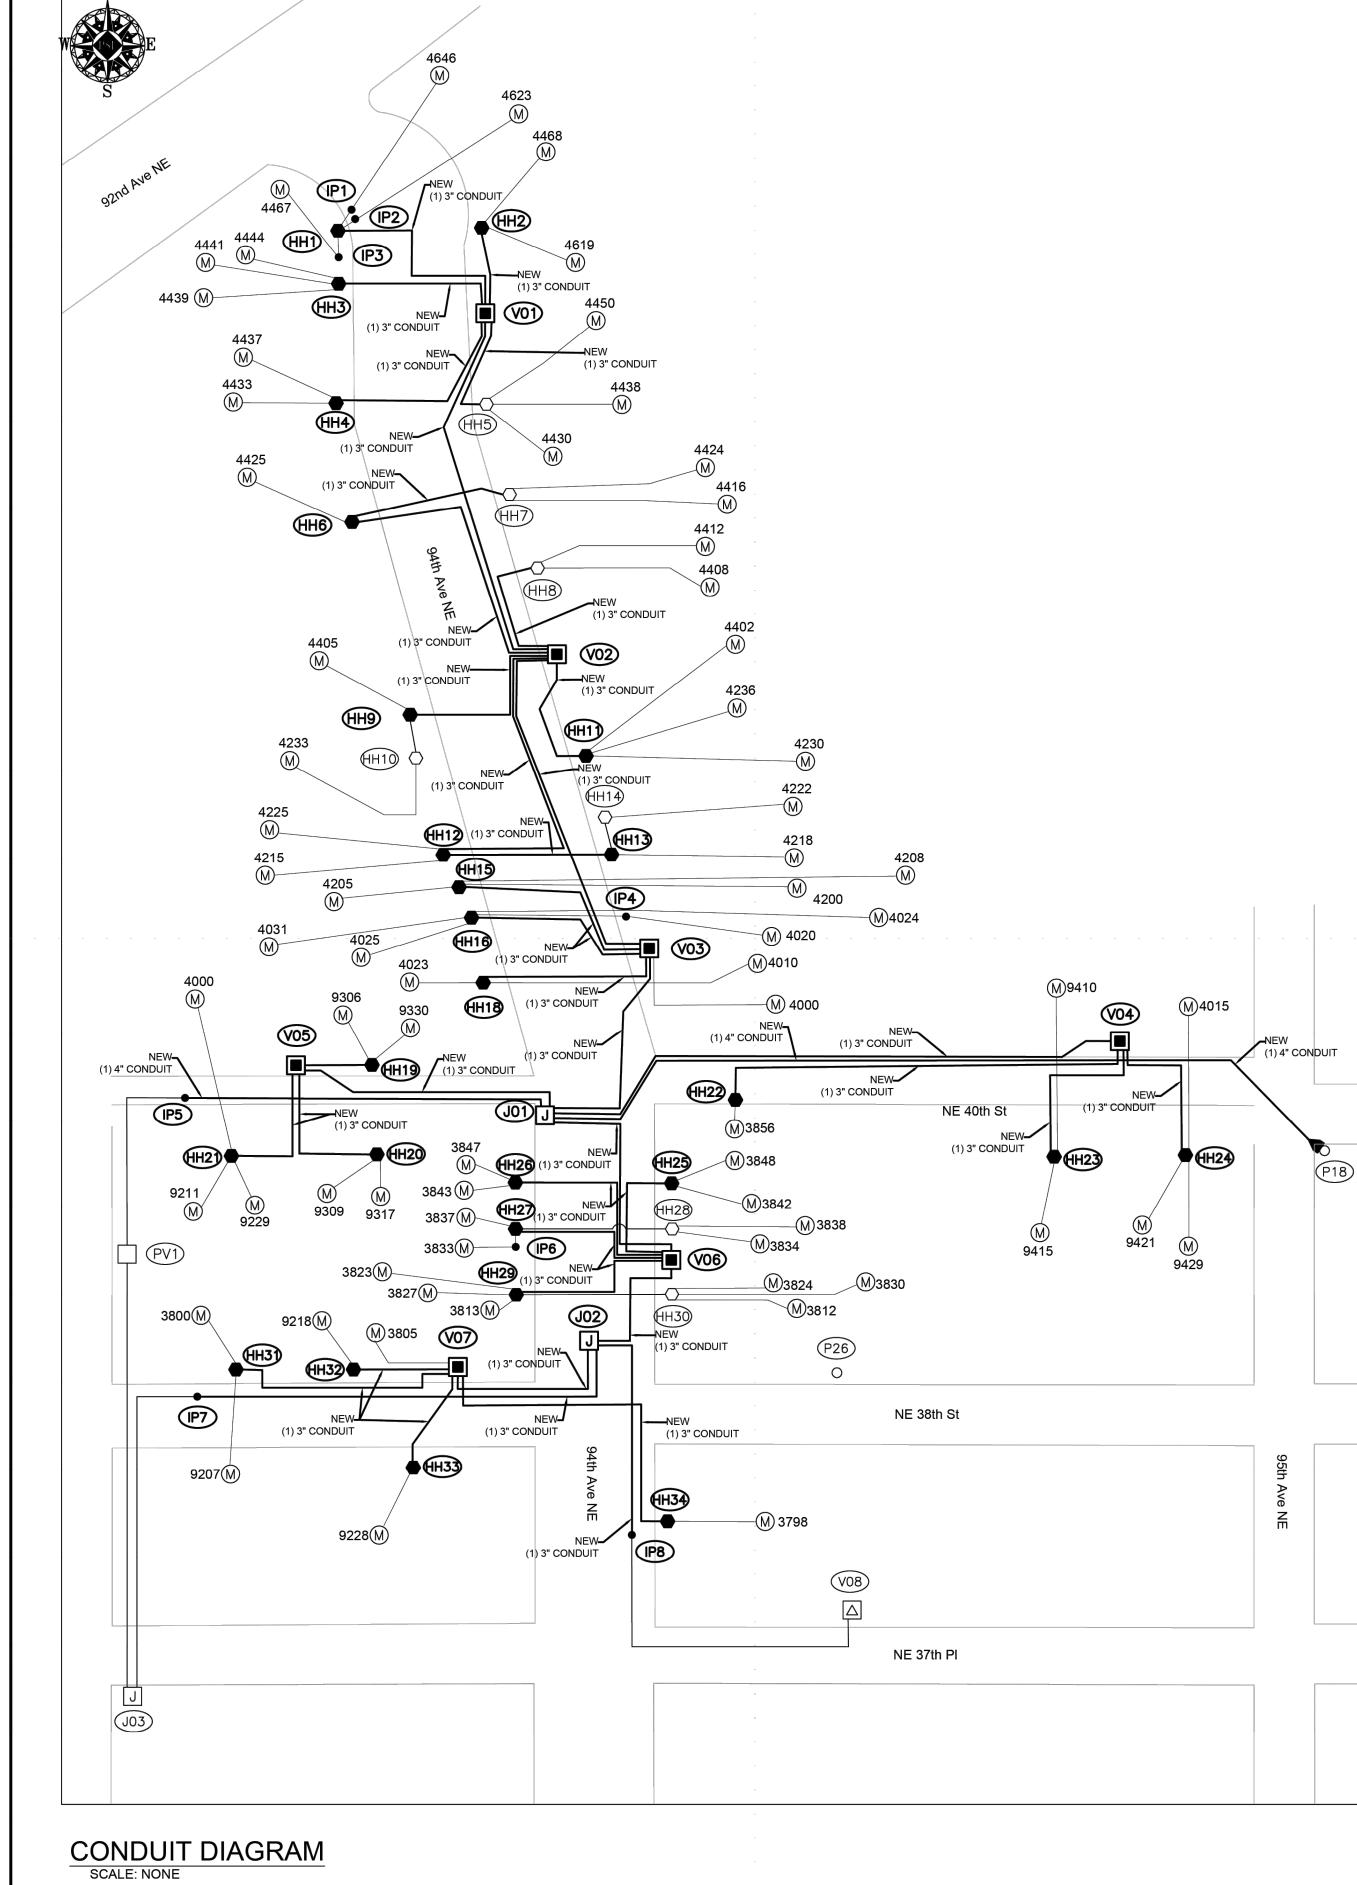

PRIMARY CABLE & CONDUIT TABLE

						ONDU	T							DDIM	ARY CABL				ASBUILT INFORMATION
				1		ONDO	,,,,							FRIIV	IART CABL	. <b>C</b>			ASBUILT INFORMATION
LOCA	TION	SIZE	Qty	LENGTH Design		BEN	NDS		PULL	PULL	Cable	LENGTH Design	C	able Numbe	rs	Plea	ase Record		Foreman - Complete
FROM	то	(in)		(ft)	90°	45°	22°	11°	(lbs)	Rev (lbs)	Size	(ft)	Α	В	С	Manufacturer	Compound	Year	Actual Amount Installed (Conduit & Cable)
V01	V02	3	1	425	1	-	-	1			1/0 JKT	445	-	EJJ625	-				
V02	V03	3	1	675	2	-	-	-			1/0 JKT	695	-	EJJ626	-				
V03	J01	3	1	175	-	2	2	-			1/0 JKT	195 .	-	EJJ627	-				
J01	V04	3	1	305	1	4	-	-			1/0 JKT	325	EJJ628	-	-				
J01	P18	4	1	225	1	4	-	-			1/0 JKT	245	EJJ630	EJJ631	EJJ632				
J01	V05	3	1	305	2	-	-	-			1/0 JKT	325	-	-	EJJ629				
J01	IP5	4	1	75	1	2	-	-					CONDUIT O	NLY					
J01	PV1			CABL	E ONL	Υ					1/0 JKT	290	ACX832	ACX833	ACX834				
J01	V06	3	1	320	-	4	-	-			1/0 JKT	340	-	EJJ633	-				
V06	J02	3	1	250	1	2	-	-			1/0 JKT	270	-	-	EJJ634				
J02	V07	3	1	225	2	2	-	-			1/0 JKT	245	-	EJJ635	-				
J02	IP7	3	1	490	2	2	-	2			CONDUIT ONLY								
J02	J03	<u> </u>		CABL	E ONL	Υ					1/0 JKT 860 - EJJ636 -								
J02	IP8	3	1	175	1	4	-	-			CONDUIT ONLY								
J02	V08		CABLE ONLY							1/0 JKT	500	-	EJJ637	-					

## SECONDARY CABLE & CONDUIT TABLE

LOCATION	CAB	BLE		C	ONDU	ΊΤ			ASBUILT INFORMATION	
LOCA	ATION	SIZE	LENGTH Design	SIZE	LENGTH Design		BEI	NDS		Foreman - Complete
FROM	то	(1/0,4/0,350)	(ft)	(in)	(ft)	90°	45°	22°	11°	Actual Amount Installed (Conduit & Cable)
V01	HH1	350 TPX	240	3	230	2	-	-	4	·
V01	HH2	350 TPX	230	3	220	2	-	-	4	·
V01	HH3	350 TPX	100	3	90	2	-	-	-	
V01	HH4	350 TPX	90	3	80	2	-	-	-	
V01	HH5	350 TPX	70	3	60	2	-	-	-	
HH1	IP1	350 TPX	15	3	5	-	-	-	-	·
HH1	IP2	350 TPX	25	3	15	-	-	-	-	
HH1	IP3	350 TPX	25	3	15	-	-	-	-	
V02	HH6	350 TPX	250	3	240	2	-	-	-	
HH6	HH7	350 TPX	50	3	40	-	1	-	-	
V02	HH8	350 TPX	175	3	165	3	-	-	-	·
V02	HH9	350 TPX	55	3	45	2	-	-	-	
V02	HH11	350 TPX	145	3	135	1	2	-	-	
V02	HH12	350 TPX	240	3	230	2	-	-	-	
HH12	HH13	350 TPX	50	3	40	-	1	-	-	
V03	HH15	350 TPX	375	4	365	2	-	-	-	
V03	HH15	350 TPX	375		CAE	SLE O	NLY			
V03	HH16	350 TPX	205	3	195	2	-	-	-	
V03	HH18	350 TPX	40	3	30	-	-	-	-	
HH16	IP4	4/0 SEC	65	3	55	1	-	-	-	
V05	HH19	4/0 SEC	120	3	110	-	-	-	-	·
V05	HH20	4/0 SEC	145	3	135	2	-	-	-	·
V05	HH21	4/0 SEC	80	3	70	2	-	-	-	
V04	HH22	1/0 SEC	215	3	205	1	2	-	-	
V04	HH23	1/0 SEC	70	3	60	1	2	-	-	
V04	HH24	1/0 SEC	125	3	115	1	2	-	-	·
V06	HH25	4/0 SEC	195	3	185	2	-	-	-	·
V06	HH26	4/0 SEC	195	3	185	2	-	-	-	
V06	HH27	4/0 SEC	115	3	105	2	-	-	-	
V06	HH29	4/0 SEC	180	3	170	2	-	-	-	
HH27	IP6	4/0 SEC	40	3	30	-	-	-	-	·
V07	HH31	4/0 SEC	280	3	270	2	-	-	-	·
V07	HH32	4/0 SEC	135	3	125	2	-	-	-	
V07	HH33	4/0 SEC	30	3	20	-	-	1	-	
V07	HH34	4/0 SEC	85	3	75	3	-	-	-	

NOTE: 2 RUNS OF 350 IN (1) 4" CONDUIT FROM V03-HH15

							REAL E	STATE/EA	SEMENT	PERMIT	
									N/A	YARROW PO	TNIC
3							FUNCT	ION	CONTACT	PHONE NO	DATE
2							PROJE	CT MGR	KIARA SKYE	425-213-9205	10/13/23
1							ENGR -	POWER	KYLE HAYS	206-930-8544	10/13/23
REV#	DATE	BY	DES	CRIPTIO	N		ENGR -	GAS	N/A	N/A	N/A
OUNTY	JNTY Emer Sect Gas Wk Ctr POWE				POWER	WK CTR	DRAW	N BY	HOLLY SOREM	253-208-8843	10/13/23
KING	}	N/A		N/A		CSPFEPI	CHECK	ED BY	Kyle Hays	(206) 930-8544	10/13/23
/4 SEC		OP MAP			PLAT M	AP	APPRO	VED BY			
S18,19 2	5 05E	N/	Α			N/A	FOREM	1AN #1			
-MAP NO (P	OWER)	ОН СКТ МА	P	UG CKT	MAP	CIRCUIT NO	FOREM	1AN #2			
A2505E0	72,73	D2505E07	76	R2505E	072,73	MED-33	MAPPI	NG			
					JOIN	T FACILITIES AF	RRANGE	MENTS			
Į.	UTILITIES		N/A			N/A			N/A	N/A	
C	CONTACT		N/A	·		N/A			N/A	N/A	·
	PHONE#		N/A			N/A			N/A	N/A	




94TH AVE NE YARROW POINT SCHEDULE 74 4467 94TH AVE NE YARROW POINT, 98004

DRAWING: PSE 17

INCIDENT MAOP
N/A N/A

Gas Order Elect Order
N/A 101149280 SCALE PAGE
AS NOTED 17 / 18

CABLE DIAGRAM
SCALE: NONE

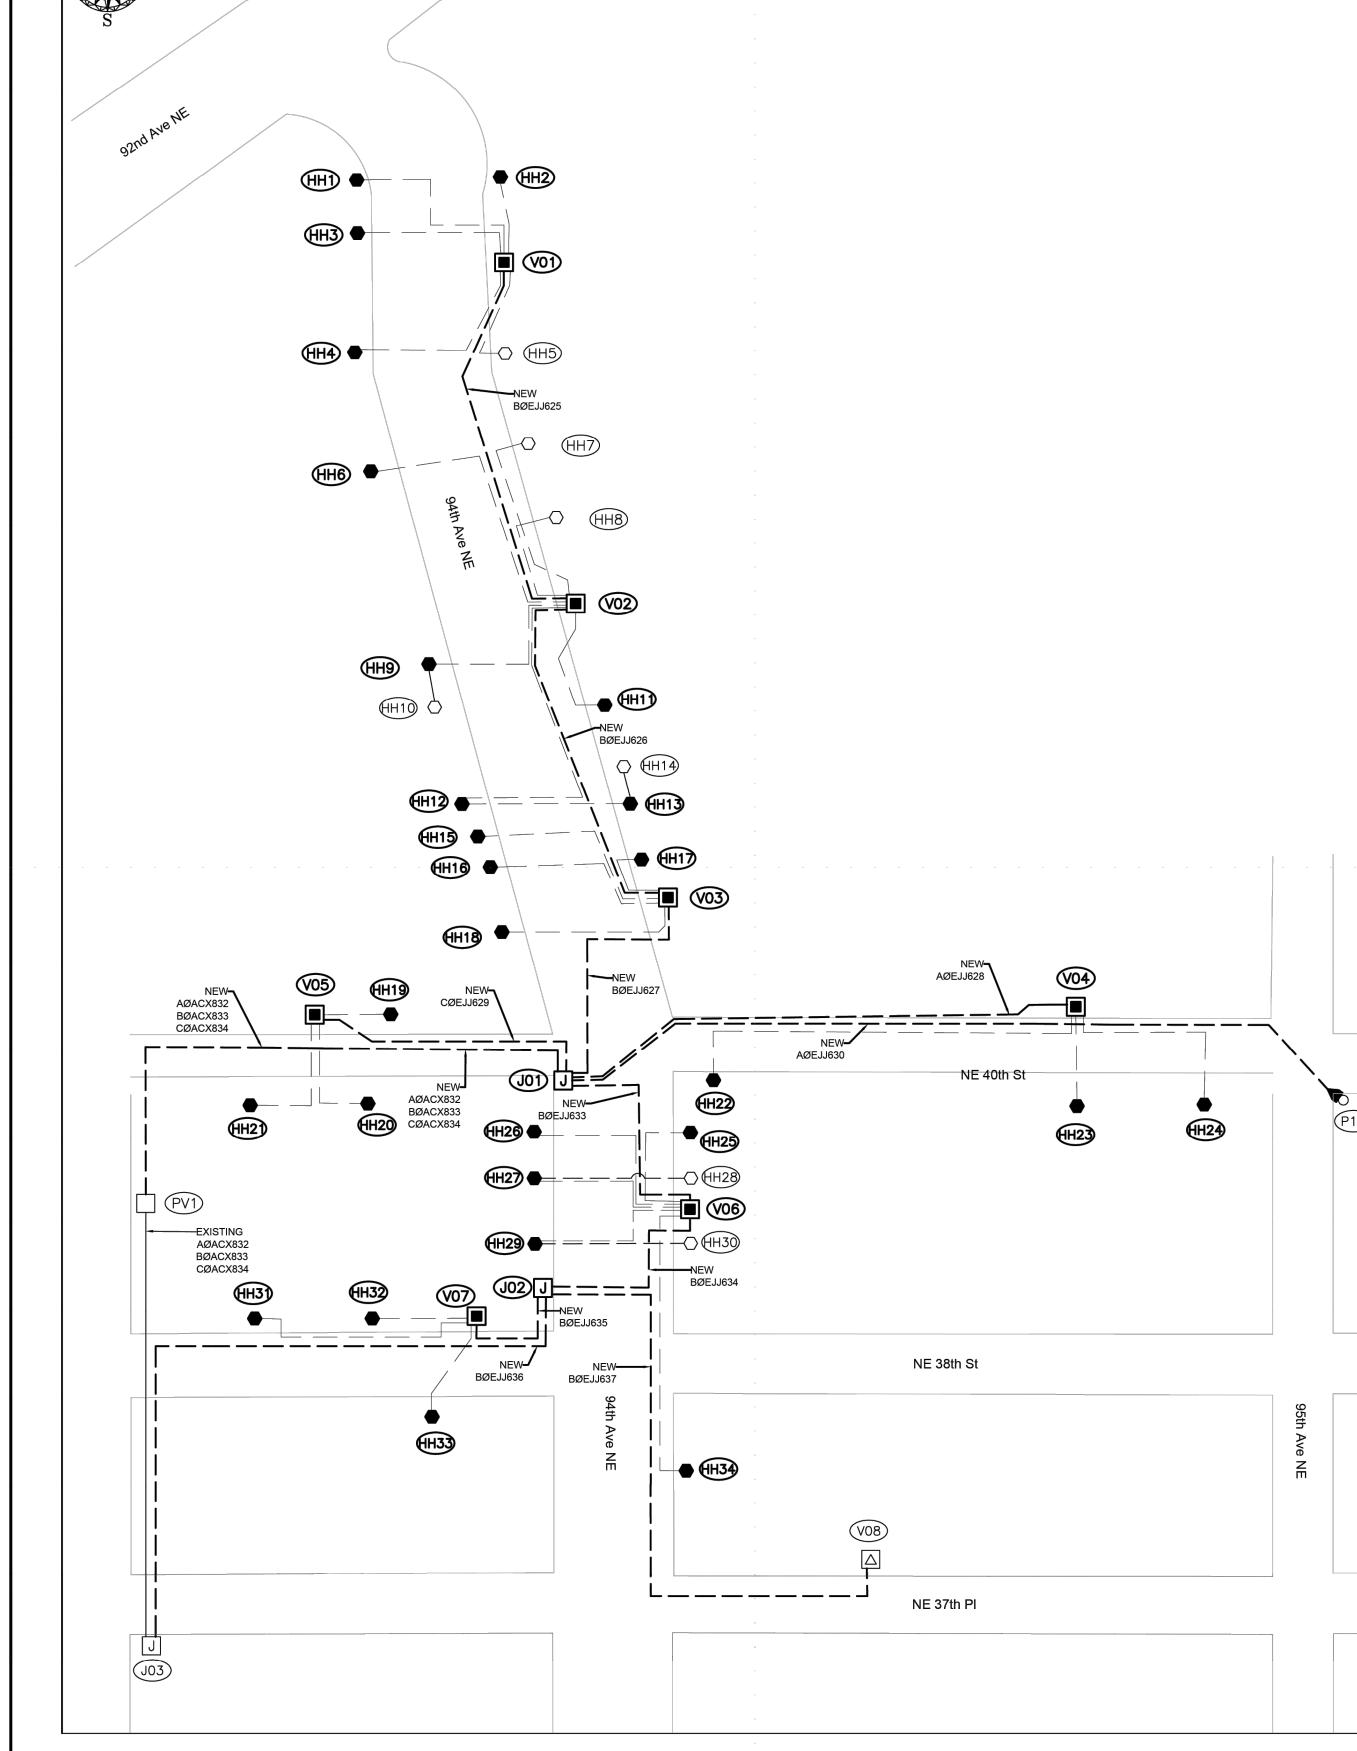

## PRIMARY CABLE & CONDUIT TABLE

					C	ONDU	JIT							PRIM	IARY CABL	.E			ASBUILT INFORMATION
LOCA	ATION	SIZE	Qty	LENGTH Design		BEI	NDS		PULL	PULL	Cable	LENGTH Design	Ca	able Numbe	rs	Plea	ase Record		Foreman - Complete
FROM	то	(in)		(ft)	90°	45°	22°	11°	(lbs)	Rev (lbs)	Size	(ft) .	Α	В	С	Manufacturer	Compound	Year	Actual Amount Installed (Conduit & Cable)
V01	V02	3	1	425	1	-	-	1			1/0 JKT	445	-	EJJ625	-				
V02	V03	3	1	675	2	-	-	-			1/0 JKT	695	-	EJJ626	-				
V03	J01	3	1	175	-	2	2	-			1/0 JKT	195	-	EJJ627	-				
J01	V04	3	1	305	1	4	-	-			1/0 JKT	325	EJJ628	-	-				
J01	P18	4	1	225	1	4	-	-			1/0 JKT	245	EJJ630	-	-				
J01	V05	3	1	305	2	-	-	-			1/0 JKT	325	-	-	EJJ629				
J01	IP5	4	1	75	1	2	-	-				.(	CONDUIT O	NLY					
J01	PV1			CABLI	E ONL	Υ.Υ					1/0 JKT	290	ACX832	ACX833	ACX834				
J01	V06	3	1	320	-	4	-	-			1/0 JKT	340	-	EJJ633	-				
V06	J02	3	1	250	1	2	-	-			1/0 JKT	270	-	-	EJJ634				
J02	V07	3	1	225	2	2	-	-			1/0 JKT	245	-	EJJ635	-				
J02	IP7	3	1	490	2	2	-	2				•(	CONDUIT O	NLY					
J02	J03			CABLI	E ONL	Υ					1/0 JKT 860 - EJJ636 -								
J02	IP8	3	1	175	1	4	-	-			CONDUIT ONLY								
J02	V08			CABLI	E ONL	Υ					1/0 JKT	500	-	EJJ637	-				

## SECONDARY CABLE & CONDUIT TABLE

NOTE: 2 RUNS OF 350 IN (1) 4" CONDUIT FROM V03-HH15

		CAB	BLE		C	ONDU	IT			ASBUILT INFORMATION
LOCA	ATION	SIZE	LENGTH Design	SIZE	LENGTH Design		BEI	NDS		Foreman - Complete
FROM	то	(1/0,4/0,350)	(ft)	(in)	(ft)	90°	45°	22°	11°	Actual Amount Installed (Conduit & Cable)
V01	HH1	350 TPX	240	3	230	2	-	-	4	
V01	HH2	350 TPX	230	3	220	2	-	-	4	
V01	HH3	350 TPX	100	3	90	2	-	-	-	
V01	HH4	350 TPX	90	3	80	2	-	-	-	
V01	HH5	350 TPX	70	3	60	2	-	-	-	
HH1	IP1	350 TPX	15	3	5	-	-	-	-	
HH1	IP2	350 TPX	25	3	15	-	-	-	-	
HH1	IP3	350 TPX	25	3	15	-	-	-	-	
V02	HH6	350 TPX	250	3	240	2	-	-	-	
HH6	HH7	350 TPX	50	3	40	-	1	-	-	
V02	HH8	350 TPX	175	3	165	3	-	-	-	
V02	HH9	350 TPX	55	3	45	2	-	-	-	
V02	HH11	350 TPX	145	3	135	1	2	-	-	
V02	HH12	350 TPX	240	3	230	2	-	-	-	
HH12	HH13	350 TPX	50	3	40	-	1	-	-	
V03	HH15	350 TPX	375	4	365	2	-	-	-	
V03	HH15	350 TPX	375		CAE	SLE OI	NLY			,
V03	HH16	350 TPX	205	3	195	2	-	-	-	
V03	HH18	350 TPX	40	3	30	-	-	-	-	
HH16	IP4	4/0 SEC	65	3	55	1	-	-	-	·
V05	HH19	4/0 SEC	120	3	110	-	-	-	-	
V05	HH20	4/0 SEC	145	3	135	2	-	-	-	
V05	HH21	4/0 SEC	80	3	70	2	-	-	-	
V04	HH22	1/0 SEC	215	3	205	1	2	-	-	
V04	HH23	1/0 SEC	70	3	60	1	2	-	-	
V04	HH24	1/0 SEC	125	3	115	1	2	-	-	
V06	HH25	4/0 SEC	195	3	185	2	_	-	-	
V06	HH26	4/0 SEC	195	3	185	2	-	-	-	
V06	HH27	4/0 SEC	115	3	105	2	-	-	-	
V06	HH29	4/0 SEC	180	3	170	2	-	-	-	·
HH27	IP6	4/0 SEC	40	3	30	-	-	-	-	•
V07	HH31	4/0 SEC	280	3	270	2	-	-	-	
V07	HH32	4/0 SEC	135	3	125	2	-	-	-	
V07	HH33	4/0 SEC	30	3	20	-	-	1	-	
V07	HH34	4/0 SEC	85	3	75	3	-	-	-	

							REAL E	STATE/EA	SEMENT	PERMIT	
									N/A	YARROW P	OINT
3							FUNCT	ION	CONTACT	PHONE NO	DATE
2							PROJE	CT MGR	KIARA SKYE	425-213-9205	10/13/23
1							ENGR -	- POWER	KYLE HAYS	206-930-8544	10/13/23
REV#	DATE	BY	DES	ESCRIPTION				- GAS	N/A	N/A	N/A
COUNTY	DUNTY Emer Sect Gas Wk Ctr POWER WK CTR					DRAW	N BY	HOLLY SOREM	253-208-8843	10/13/23	
KIN	G	N/A		N/A		CSPFEPI	CHECK	(ED BY	Kyle Hays	(206) 930-8544	10/13/23
1/4 SEC		OP MAP			PLAT M	AP	APPRO	VED BY			
S18,19 2	5 05E	N/	/A			N/A	FOREM	1AN #1			
U-MAP NO (F	POWER)	OH CKT MA	ŀΡ	UG CKT	MAP	CIRCUIT NO	FOREM	1AN #2			
A2505E0	72,73	D2505E0	76	R2505E	072,73	MED-33	MAPPII	NG			
					JOIN	T FACILITIES AI	RRANGE	MENTS			
	UTILITIES		N/A			N/A			N/A	N/A	
	CONTACT		N/A			N/A			N/A	N/A	·
	PHONE#		N/A			N/A			N/A	N/A	
				•	•					INCIDENT	MAOP

PSE PUGET SOUND ENERGY


94TH AVE NE YARROW POINT SCHEDULE 74 4467 94TH AVE NE YARROW POINT, 98004

DRAWING: PSE 18

INCIDENT N/A

Gas Order Elect Order
N/A 101149280

SCALE PAGE
AS NOTED 18 / 18

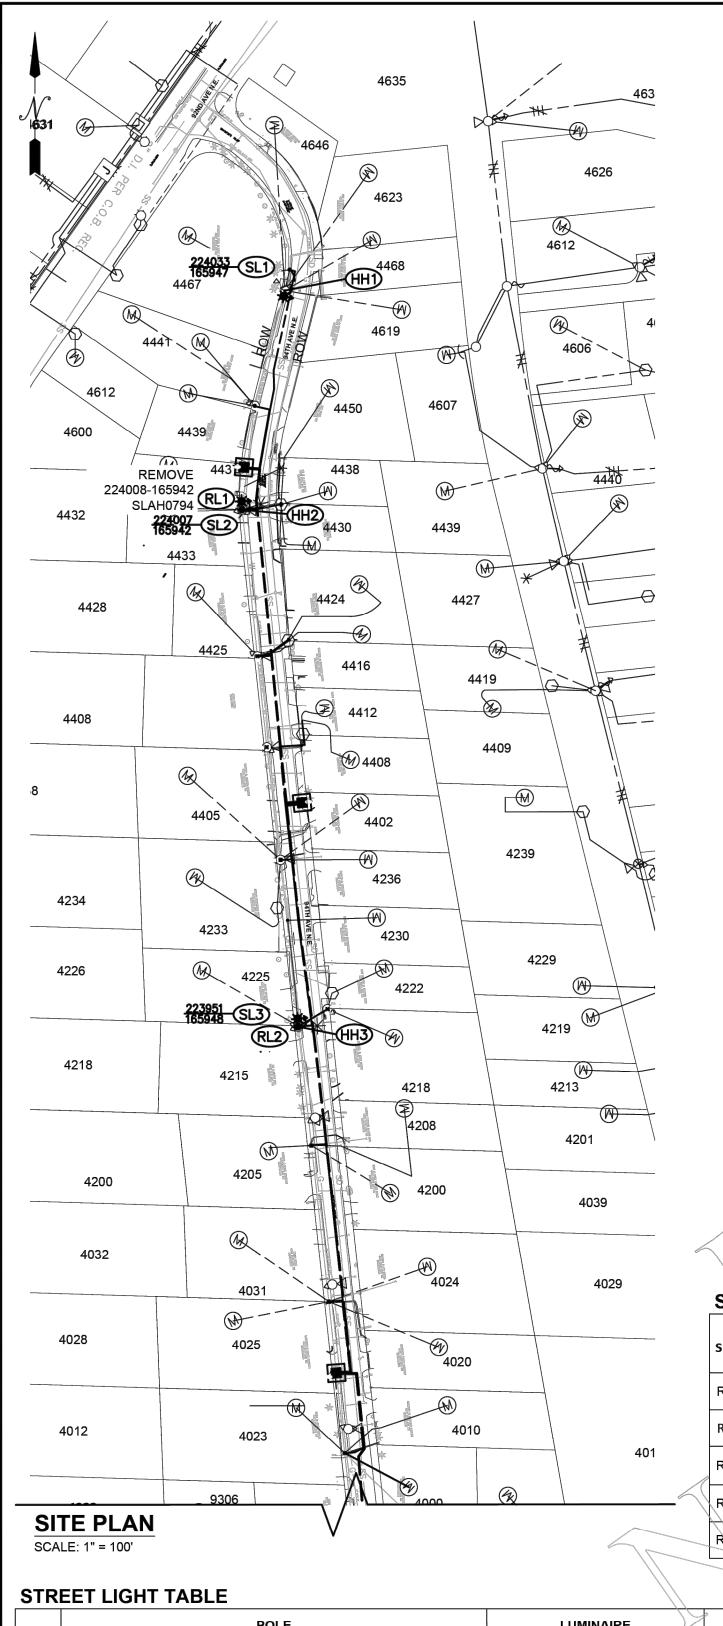

## **−**4000**\ 330** REMOVE (RL3) 223884-165958 SLAH0797 9309 3843 (M) 3845 3837 3835 **REMOVE** 223853-165958 **RL4** SLAS6012 223851 SL5 3825 **3830** 3824 REMOVE 223838-165959 SLAP6713 3817 (₹)3812 3811 3802 3801 SL6 223824 165957 **№**9426 9228 ====-N.E. 377 H PLACE SITE PLAN

STREET LIGHT CIRCUITRY TABLE (105101603)

				71 )/	•		
	SITE		CABL	EINFO	AS-E	BUILT	
	#(	FROM	TYPE	LF	TYPE /	LENGTH	REMARKS
$\wedge$	HH1\	SL1	#6 TPX	40			
	HH2	SL2	#6 TPX	15	\		
	ННЗ	SL3	#6 TPX	15			
	HH4	SŁ4	#6 TPX	190			
	HH5	SL5	#6 TPX	150			
//	HH6	SL6	#6-TPX	80			, \\
_)_			TOTAL FT =	490	TOTAL FT =		

SCALE: 1" = 100'

	SIF	(FFI L	IGHI IABI	LE \(\)		<i></i>				
			POLE			LUMINAIRE				
	SITE #	GRID#	TAG #	ТҮРЕ	PREV LUM	ORIGINAL INSTALL DATE	ARM	SCH /	w/o #'s	NOTES
	RL1	224008 165942	SLAH0794	WOOD	100W HPS CHFL	1977	8	53	108139014	
	RL2	223950 165948	SLAH0793	WOOD	100W HPS CHFL	1977	8'	53	108139014	
/	RL3	223884 165958	SLAH0797	WOOD	100W HPS EHFL	1977	81	53	108139014	
1	RL4	223853 165958	SLAS6012	WOOD	100W HPS CHEL	2013	8'	53	108139014	
	RL5	223838 165959	SLAP6713	WOOD	100W HPS CHFL	1977	8'	53	108139014	

STR	EET LIG	HT TABLE													
			POLE				LUMINAIRE	7	TUBE	POLE BASE TYPE	WO#	BILLING	TOTAL	SMART STREET LIGHT	
SITE #	GRID#	INTOLIGHT TAG#	TYPE	MTG HT.	ARM	WATTS	STYLE	TUBE LENGTH	TUBE DIAMETER	(Direct Buried or Basemount)	(INTOLIGHT)	SCH.	CONN LOAD	NODE	NOTES
SL1	224033 165947		VALMONT RND STEEL TAPERED DKGRN	24'	TRA5D	49W	AAL PROMENADE 3000K TY2 DKGRN	4'	18"	4-BOLT/FIXED BASE	105101603	51	120/240		
SL2	224007 165942		VALMONT RND STEEL TAPERED DKGRN	24'	TRA5D	49W	AAL PROMENADE 3000K TY2 DKGRN	4'	18"	4-BOLT FIXED BASE	105101603	51	120/240		
SL3	223951 165948		VALMONT RND STEEL TAPERED DKGRN	24'	TRA5D	49W	AAL PROMENADE 3000K TY2 DKGRN	4'	18"	4-BOLT FIXED BASE	105101603	51	120/240		
SL4	223887 165958		VALMONT RND STEEL TAPERED DKGRN	24'	TRA5D	49W	AAL PROMENADE 3000K TY2 DKGRN	4'	18"	4-BOLT FIXED BASE	105101603	51	120/240		
SL5	223851 165955		VALMONT RND STEEL TAPERED DKGRN	24'	TRA5D	49W	AAL PROMENADE 3000K TY2 DKGRN	4'	18"	4-BOLT FIXED BASE	105101603	51	120/240		
SL6	223824 165947		VALMONT RND STEEL TAPERED DKGRN	24'	TRA5D	49W	AAL PROMENADE 3000K TY2 DKGRN	4'	18"	4-BOLT FIXED BASE	105101603	51	120/240		

## SITE SPECIFIC NOTES

NEW HANDHOLES PROVIDED BY PSE PI DEPT. - CONNECT AND TAG NEW #6 SEC CIRCUITRY

REMOVE EXISTING 100W HPS AND ARM.

## FLAGGING REQUIRED

-- INST NEW VALMONT 24' MH RND TAPERED GRN POLES

DRILL FOR AAL TRA5D, ON 4 BOLT FIXED CONC BASE -- INST NEW PROMENADE 49W LED DARK GREEN LUMINAIRE

- ON TRA5D ARM - ORIENT AS SHOWN
- INST SMART NODE AND SERIAL NUMBER
- INST STREET LIGHT TAG FLAGGING REQUIRED

DEVELOPER TO PROVIDE AND INSTALL ALL SCH40 COND. SEE CONDUIT DIAGRAM AND TRENCH DETAIL) - POTELCO TO INSTALL #6 TPX IN CONDUIT (SEE TABLE)

## **AUU NOTES:**

INST CONCRETE BASE - GALVANIZED STEEL 4 BOLT (SEE DETAIL)

## CONDUIT LEGEND

PSE #6 TPX

## CONDUIT DIAGRAM


Electric Service Cable in Conduit (NTS)

**\***SL4

**SL**5)**\***►


(HH5)



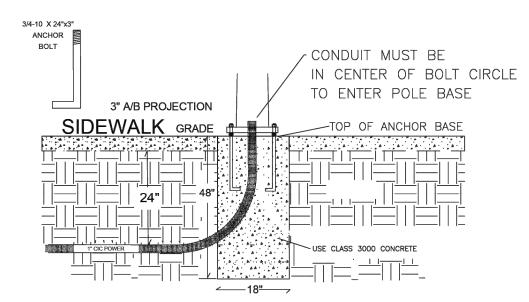

## DETAIL FIXED BASE

Backfill for In Conduit - The backfill layer shall be soil that is free from construction debris, glass, sharp rocks, frozen clods, and rocks larger than 8" in diameter.

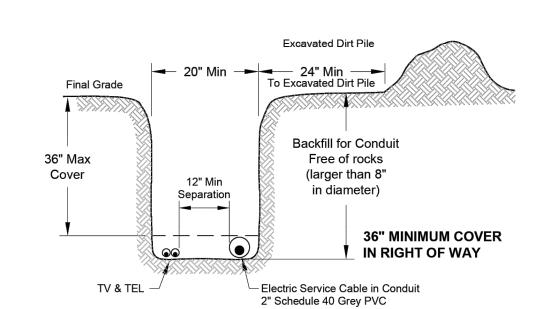

## **CUSTOMER-SUPPLIED JOINT TRENCH DETAIL**

Electric Service Cable in Conduit (NTS)


## STREET LIGHT NOTES

### POTELCO:

- ALL STREET LIGHTING POLES ARE TO BE INSTALLED PER STANDARD 6375.4800 (PAGE #2) IN THE "LINE WORK PRACTICES MANUAL".
- 2. ALL POLES (WOOD, CONCRETE OR FIBERGLASS) ARE TO BE SET PLUMB AND EMBEDDED TO THE GROUND LINE MARKED ON THE POLE.
- BACKFILL AROUND POLE WITH 5/8" MINUS GRAVEL AND COMPACT IN 6" LIFTS. (PEA GRAVEL AND NATIVE SOILS ARE NOT ACCEPTABLE.) APPROXIMATELY 1 CU. YD. OF 5/8" MINUS CRUSHED ROCK WILL BE
- 4. IN ALL SHOEBOX AND COBRAHEAD INSTALLATIONS, THE LUMINAIRE MUST BE LEVELED.

### **DEVELOPER / CUSTOMER:**

- THE DEVELOPER IS REQUIRED TO SUPPLY AND INSTALL PLASTIC (NON PAPER) STREET LIGHT TUBES (MINIMUM 18" DIAMETER) TO AID IN THE INSTALLATION OF THE STREET LIGHTING POLES.
- DEVELOPER MUST SUPPLY DURABLE LID/COVER AT EACH STREET LIGHT TUBE.
- DEVELOPER TO PROVIDE ALL TRENCHING AND CONDUIT WITH PULL-STRINGS FOR STREET LIGHTING CIRCUITRY.
- 4. CONDUIT SHALL BE SCH 40 PVC.

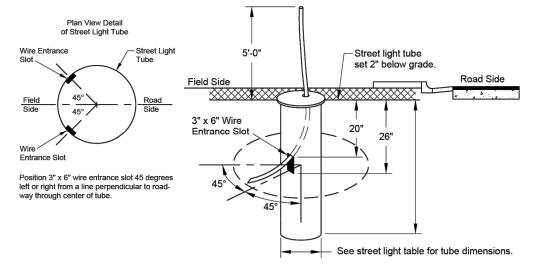



## STREET LIGHT TUBE DETAIL

SCALE: NONE

## **EROSION & SEDIMENT CONTROL REQUIREMENTS**

EROSION & SEDIMENT CONTROL SHALL BE PER PSE STANDARD PRACTICE 0150.3200 TECHNIQUES FOR TEMPORARY EROSION & SEDIMENT CONTROL & ANY ADDITIONAL LOCAL JURISDICITON REQUIREMENTS. (LOCAL JURISDICTIONS MAY HAVE ADDITIONAL REQUIREMENTS INCLUDING NOTES DETAILING WHERE EROSION OR SEDIMENT CONTROL STRUCTURES ARE TO BE INSTALLED, CROSS SECTION DETAILS OF THE TYPICAL EROSION STRUCTURES, & SPECIAL REQUIREMENTS FOR WORK IN SENSITIVE AREAS.)

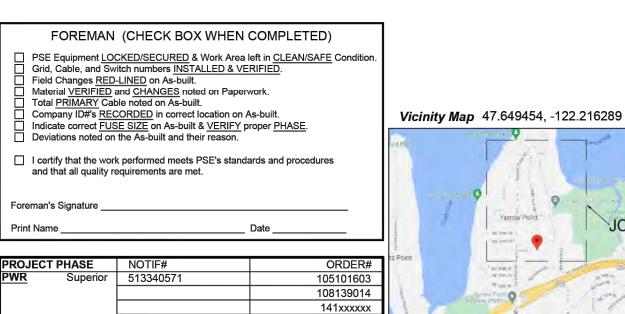

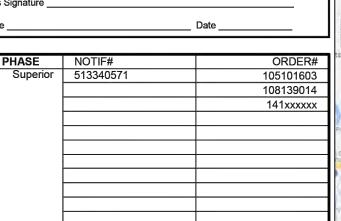

Project Manager Contact Information: Manager: LANE MAHLER

E-Mail: LANE.MAHLER@PSE.COM Developer Locates Req'd PSE Locates Req'd Outages Req'd

Cell Phone: 425-462-3624

Flagging Req'd



┌ Owner / Developer Contact Info CITY OF YARROW POINT ATTN: Stacia Schroeder 206) 276-8922 office

For contacts below dial 1-888-CALL PSE (225-5773)

CALL 811 TWO BUSINESS DAYS BEFORE YOU DIG

Gas Order

N/A

AS NOTED

Elect Order

105101603

THIS SKETCH NOT TO BE RELIED UPON FOR EXACT LOCATION OF EXISTING FACILITIE

	NEW BUS			CORRECTIVE / 10 DAY WAIVED		REAL E	REAL ESTATE/EASEMENT N/A			PERMIT  YARROW POINT		
	SINE 35											
3	N/A	N/A		N/A			FUNCT	TON	CONTACT	PHONE N	0	DATE
2	N/A	N/A	N/A					JNT MGR	L. GOLDSMITH	425-395-5225		6/7/23
1	N/A	N/A		N/A			ENGR -	- POWER	A. WARREN	253-508-78	59	6/7/23
REV#	DATE	BY	DES	CRIPTIO	N	ENGR		R - GAS N/A		N/A N//		N/A
COUNTY		Emer Sect	Gas Wk Ctr		POWER WK CTR		DRAWI	N BY	A. WARREN	253-508-78	59	6/7/23
KING		N/A	N/A			3515		(ED BY				
1/4 SEC		OP MAP			PLAT MAP		APPROVED BY					
NE-19 - T25N - R05E		N/A			N/A		FOREMAN #1					
U-MAP NO (POWER)		OH CKT MAP		UG CKT MAP		CIRCUIT NO	FOREMAN #2					
2505E073		2505E076		2505E073		MED-33	MAPPING					
					JOIN	T FACILITIES A	RRANGE	MENTS				
UTILITIES		N/A			N/A			N/A		N/A		
CONTACT		N/A			N/A			N/A		N/A		
PHONE#		N/A				N/A		N/A		N/A		
PUGET City of Yarrow Point 94th AVE NE										INCIDENT N/A	ľ	MAOP N/A

PSE PUGET SOUND ENERGY

City of Yarrow Point 94th AVE NE REMOVAL & NEW INSTALL 4439 94th AVE NE, YARROW POINT, 98004 SCALE

