
# TOWN OF YARROW POINT

KING COUNTY WASHINGTON

## SALLY'S ALLEY PHASE 2

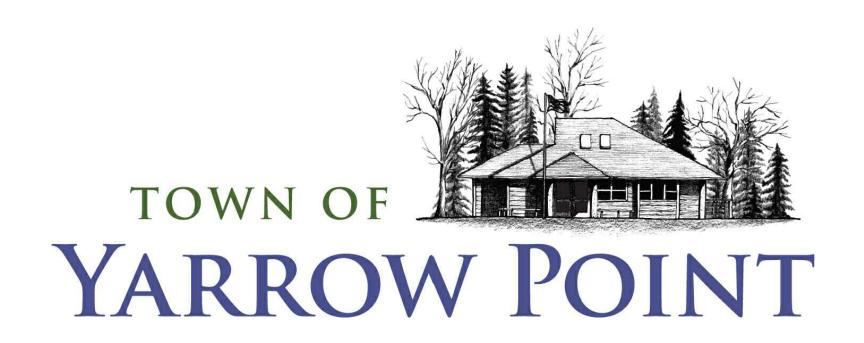

### **TOWN OFFICIALS**

**KATY HARRIS** 

Mayor

STEPHAN LANGERHOLM

STEVE BUSH

**CHUCK PORTER** 

**Town Council** 

MICHAEL HYMAN

**KATHY SMITH** 

**Town Council** 

STACIA SCHROEDER, P.E

**TOWN ENGINEER** 

BONNIE RITTER

CLERK-TREASURER

APPROVAL FOR CONSTRUCTION

DATE: <u>JANUARY 2025</u>
APPROVAL EXPIRES: <u>JANUARY 2026</u>

BY: TOWN OF YARROW POINT



JANUARY 2025 G&O JOB #23445.02





3710 168TH STREET NE, BLDG. B, SUITE 210 ARLINGTON, WASHINGTON 98223 (360) 454-5490

### **ABBREVIATIONS**

ASBESTOS CEMENT PIPE ADJ ADJUST

ALT ALTERNATE ANSI AMERICAN NATIONAL STANDARDS INSTITUTE ASPH **ASPHALT** AMERICAN SOCIETY OF TESTING AND MATERIALS **ASTM** 

BLDG BUILDING во **BLOW OFF** BEGINNING OF PROJECT BOP CONDUIT CB **CATCH BASIN** 

**AVENUE** 

AVE

CF CUBIC FEET CFS CUBIC FEET PER SECOND CMP CORRUGATED METAL PIPE CO CLEANOUT CONC CONCRETE

CONT CONTINUED/CONTINUOUS CPEP CORRUGATED POLYETHYLENE PIPE CTR CENTER CUBIC YARD CY

CENTER LINE **DUCTILE IRON** DIA DIAMETER DIM DIMENSION DWGS DRAWING(S) EAST EACH EA **ELEVATION** ELECTRICAL ELEC **END OF PROJECT** EOP EX **EXISTING** FIG **FIGURE** FT FEET GA GAUGE GALV GALVANIZED

HDPE HIGH DENSITY POLYETHYLENE PIPE

INSIDE DIAMETER ID INVERT ELEVATION INCH IN INVERT INV LENGTH POUND LB LINEAR FEET LF MAX MAXIMUM MFR MANUFACTURER MH MANHOLE MIN MINIMUM MISC MISCELLANEOUS NORTH NO NUMBER

NTS NOT TO SCALE OC ON CENTER OD **OUTSIDE DIAMETER** PERF PERFORATED POWER POLE PP PVC POLYVINYL CHLORIDE **PVMT** PAVEMENT QTY QUANTITY

**RADIUS** R/W RIGHT-OF-WAY REINF REINFORCE RAILROAD RR SOUTH SCHEDULE SCH SQUARE FEET SF SHT SHEET SQ SQUARE STA STATION STANDARD STD

TEL TELEPHONE TEMPORARY EROSION AND SEDIMENT CONTROL TESC

TYP **TYPICAL** UNDERGROUND CONVERSION UGC

TOP OF CURB

VERT VERTICAL WEST WITH W/

TC

W/O WITHOUT WASHINGTON STATE DEPARTMENT OF TRANSPORTATION WSDOT

### **EXISTING LEGEND**

SURFACE FEATURES	DESCRIPTION	SYMBOLS	DESCRIPTION	SYMBOLS	DESCRIPTION
	CENTER LINES	$\bowtie$	WATER VALVE -	$\langle \rangle$	TRAFFIC SIGNAL POLE
	RIGHT-OF-WAY LINES	-0-	HYDRANT		STREET LIGHT
_··-	LOT LINES	Q	FDC		LUMINAIRE(DOUBLE)
W	WATER LINE		POST INDICATOR VALVE	●□	LUMINAIRE(SINGLE)
	DITCH LINE	1	WATER BLOW OFF	<b>⊕</b> 1	. ,
ss	SANITARY SEWER LINE	þ			PEDESTRIAN LIGHT POLE
D	STORM DRAIN LINE	⊞	WATER METER	<b>\$</b>	AREA LIGHT
	GAS LINE		IRR. CONTROL VALVE	0	GAS METER
UP	UNDERGROUND POWER LINES	S D	MANHOLES (SS/SD)	Ø	GAS VALVE
	UNDERGROUND COMMUNICATION LINES		СВ	П	SIGN
COM	(COMCAST/LUMEN)		POWER TRANSFORMER		MAILBOX
——————————————————————————————————————	OVERHEAD UTILITY LINES	PC	POWER/COMM. VAULT	NP	NEWS PAPER BOX
OHW	HIGH WATER LINE	WU	WATER/UTILITY VAULT	(TC)	TRASH CAN
— o — o — o — o —	CHAIN LINK FENCE		POWER MANHOLE		ROCKERY
x x x x x	WIRE FENCE	P	COMM. MANHOLE	×	SPOT ELEVATION
	WOOD FENCE				
	EDGE OF ASPHALT	$\circ$	WATER MANHOLE	*	SIZE & TYPE (CONIFEROUS TREE)
			POWER METER		SIZE & TYPE (DECIDUOUS TREE)
			SURFACE JUNCTION BOX	×	MAGNETIC NAIL W/ WASHER
			SUBSURFACE JUNCTION BOX	•	REBAR AND CAP (SET)
		-0-	POWER/UTILITY POLE	<b>©</b>	REBAR AND CAP (FOUND)
		-Q-	POWER/UTILITY POLE W/DROP	×	TACK AND LEAD
		•-	ANCHOR POLE		HUB AND TACK
		$\leftarrow$	GUY ANCHOR	•	CASED MONUMENT
					SURFACE MONUMENT

### **PROPOSED LEGEND**

**DESCRIPTION** SURFACE FEATURES GRAVEL SURFACING

CENTERLINE OF CONSTRUCTION SAWCUT LINE (APPROXIMATE LOCATION)

STORM DRAIN (SIZE AS NOTED)

PROPOSED SURFACE FEATURES/LANDSCAPING

PROPOSED SANITARY/STORM SEWER SYMBOLS

### **ORDER OF WORK**

- 1. ATTEND PRECONSTRUCTION MEETING
- 2. PROVIDE MATERIAL SUBMITTALS
- 3. CALL FOR UTILITY LOCATES
- 4. INSTALL TRAFFIC CONTROL AND EROSION CONTROL DEVICES

STORM DRAIN MANHOLE/TYPE 2 CATCH

BASIN (ACTUAL DIMENSION SHOWN FOR

STORM DRAIN CATCH BASIN, CONCRETE

INLET, OR YARD/AREA DRAIN (ACTUAL

DIMENSION SHOWN FOR PROPOSED)

PROPOSED)

ROCKERY

TIMBER EDGING


- 5. PERFORM POTHOLING OPERATIONS
- 6. PROPERTY RESTORATION
- 7. SUBMIT RECORD DRAWINGS


	SHEET INDEX						
SHEET #	DESCRIPTION						
-	COVER						
1	VICINITY & LOCATION MAPS, SYMBOL LEGEND, ABBREVIATIONS AND INDEX						
2	SURVEY CONTROL, KEY MAP AND ALIGNMENT TABLES						
3	GENERAL CONSTRUCTION NOTES						
4	TEMPORARY EROSION CONTROL DETAILS						
5	TESC, DEMO, AND STORM PLAN & PROFILE						
6	TRAIL AND DRIVEWAY RESTORATION PLAN & PROFILE						
7	CONSTRUCTION DETAILS						
8	CONSTRUCTION DETAILS						

### **BURIED UTILITIES IN AREA** CALL BEFORE YOU DIG 1-800-424-5555 EXISTING UTILITIES SHOWN ARE FROM THE BEST AVAILABLE INFORMATION AND NO

GUARANTEE IS MADE AS TO THE EXACT SIZE, TYPE, LOCATION OR DEPTH

APPROVAL FOR CONSTRUCTION BY: TOWN OF YARROW POINT DATE: JANUARY 2025 APPROVAL EXPIRES: JANUARY 2026

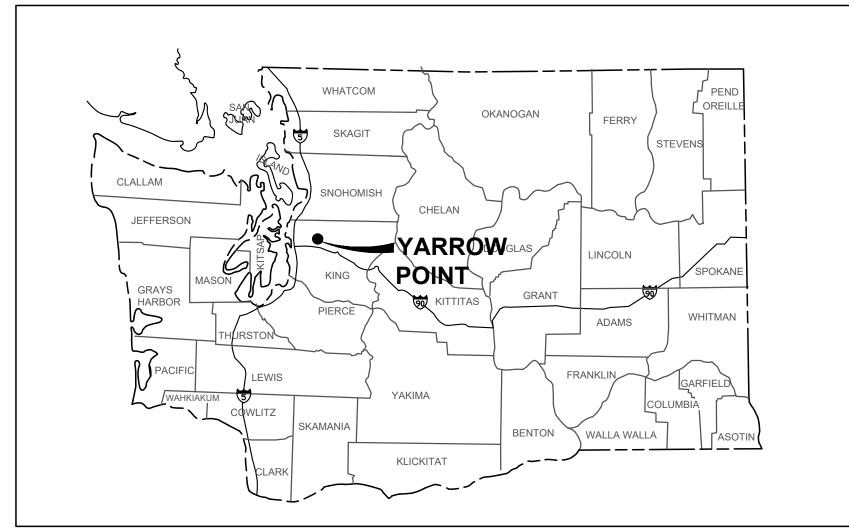

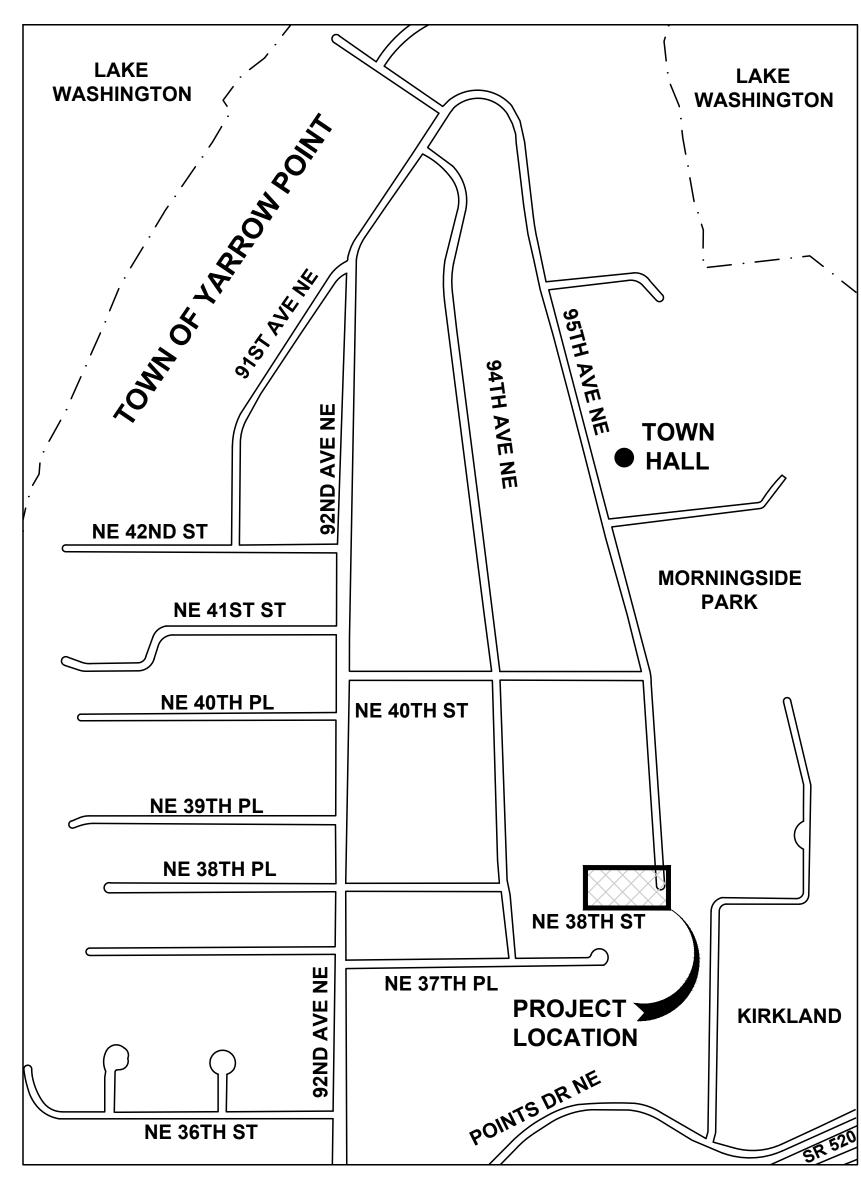

RIGHT-OF-WAY DISCLAIMER

PROPERTY LINES SHOWN HEREON

INFORMATION, NOT ON A SURVEYED

THE RIGHT-OF-WAY AND/OR

ARE BASED ON AVAILABLE


LOCATION AND ARE ONLY

APPROXIMATE.

Gray & Osborne, Inc.

3710 168TH STREET NORTHEAST BUILDING B, SUITE 210 ARLINGTON, WA 98223 (360) 454-5490



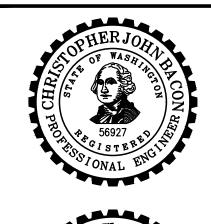



**TOWN OF YARROW POINT** 

**SALLY'S ALLEY** PHASE 2

No. DATE REVISION ISSUED FOR:

**BID PLAN SET** ISSUE DATE: JAN 2025 APPROVED BY: KWB

CJB

MAN

G & O JOB NO.: 23445.02

CHECKED BY: DRAWN BY:


LEGEND.DWG


TWO INCHES AT FULL SCALE IF NOT, SCALE ACCORDINGLY

CIVIL

**VICINITY & LOCATION** MAPS, SYMBOL LEGEND, **ABBREVIATIONS AND** INDEX

DRAWING: 1

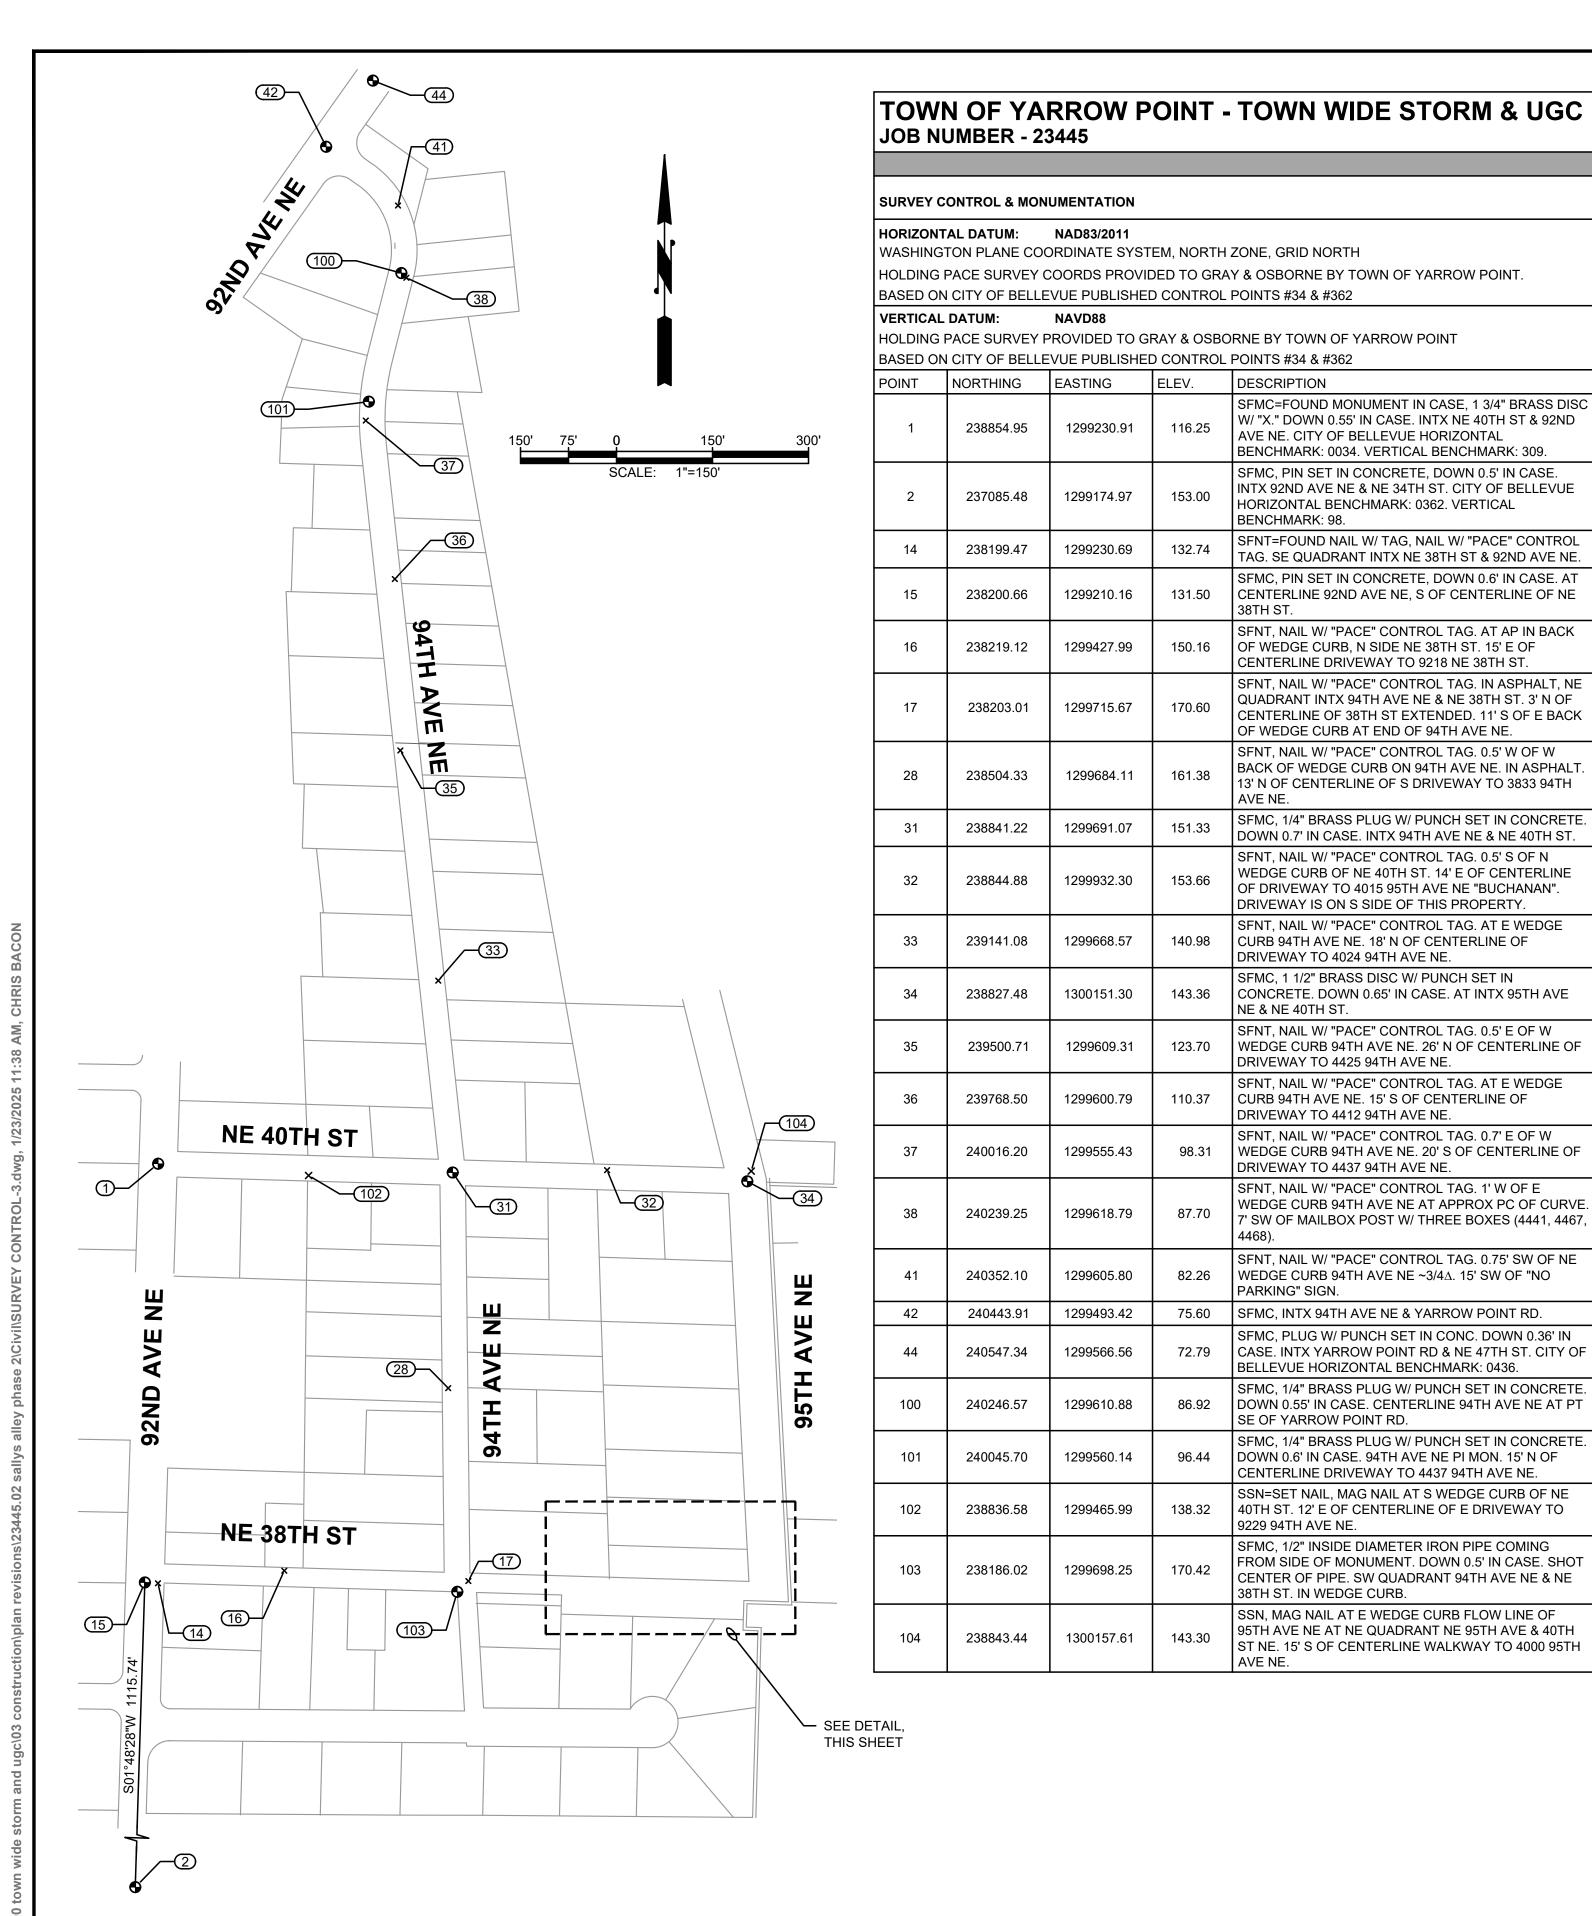

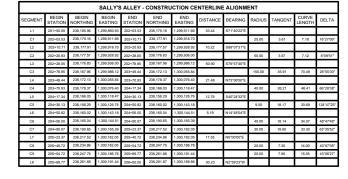

SOME TOPOGRAPHIC DATA SHOWN HEREON WAS PERFORMED BY PACE (SEE NOTES, THIS SHEET). ADDITIONAL SURVEY WAS PERFORMED BY GRAY AND OSBORNE ON MAY 16, 2023 UTILIZING PACE CONTROL

### HORIZONTAL DATUM

HORIZONTAL DATUM: NAD 83/11, WASHINGTON COORDINATE SYSTEM NORTH ZONE. BASED ON TIES TO CITY OF BELLEVUE SURVEY CONTROL POINTS 34 & 362 (POINTS 1 & 2 IN THIS PLAN SET)

### **SURVEY NOTES**

ALL DISTANCES SHOWN ARE GROUND DISTANCES UNLESS OTHERWISE NOTED.

THE LOCATION AND DESCRIPTION OF ALL SURVEY MARKERS SHOWN HEREON ARE BASED ON FIELD OBSERVATIONS TAKEN BY PACE ENGINEERS IN JANUARY, 2021, UNLESS

WORK PERFORMED IN CONJUNCTION WITH THIS SURVEY UTILIZED THE FOLLOWING EQUIPMENT AND PROCEDURES: (A) 1" TRIMBLE S7 SERIES ELECTRONIC TOTAL STATION, MAINTAINED TO THE MANUFACTURER'S SPECIFICATIONS PER W.A.C. 332-130-100. (B) FIELD TRAVERSE, EXCEEDING REQUIREMENTS SET FORTH IN W.A.C. 332-130-090. (C) LEASE SQUARE ADJUSTMENT USING StarNet VERSION 9.0 EXCEEDING REQUIREMENTS PER W.A.C. 332-130-080.

### **VERTICAL DATUM**

VERTICAL DATUM: NAVD 88 BASED ON TIES TO CITY OF BELLEVUE SURVEY CONTROL POINTS 34 & 362 (POINTS 1 & 2 IN THIS PLAN SET)

RIGHT OF WAY MARGINS AND CENTERLINES SHOWN HEREON AREA BASED UPON THE FOUND CENTERLINE MONUMENTS.

PARCEL/LOT LINES SHOWN HEREON ARE PER KING COUNTY GIS AND SHOULD BE ASSUMED APPROXIMATE

THIS SURVEY WAS PERFORMED WITHOUT THE BENEFIT OF A TITLE REPORT AND DOES NOT PURPORT TO SHOW ALL EASEMENTS.

THIS TOPOGRAPHIC SURVEY DRAWING ACCURATELY PRESENTS SURFACE FEATURES LOCATED DURING THE COURSE OF THIS SURVEY. UNDERGROUND UTILITIES SHOWN HEREON ARE BASED SOLELY UPON INFORMATION PROVIDED BY OTHERS AND PACE ENGINEERS, INC. DOES NOT ACCEPT RESPONSIBILITY OR ASSUME LIABILITY FOR THEIR ACCURACY OR COMPLETENESS. CONTRACTOR/ENGINEERS SHALL VERIFY EXACT SIZE AND LOCATION PRIOR TO CONSTRUCTION. CALL FOR LOCATE: UTILITY LOCATION SERVICE: 811

NE 38TH ST

### SALLY'S ALLEY CONSTRUCTION CENTERLINE DETAIL

SCALE: 1" = 40'

### RIGHT-OF-WAY DISCLAIMER

THE RIGHT-OF-WAY AND/OR PROPERTY LINES SHOWN HEREON ARE BASED ON AVAILABLE INFORMATION, NOT ON A SURVEYED LOCATION AND ARE ONLY APPROXIMATE.

### APPROVAL FOR CONSTRUCTION

BY: TOWN OF YARROW POINT

DATE: JANUARY 2025


APPROVAL EXPIRES: JANUARY 2026


Gray & Osborne, Inc 3710 168TH STREET NORTHEAST BUILDING B, SUITE 210



ARLINGTON, WA 98223

(360) 454-5490

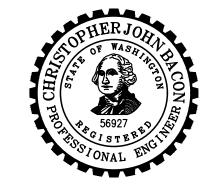

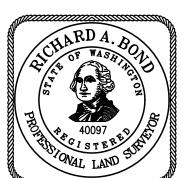

### TOWN OF YARROW POINT

SALLY'S ALLEY PHASE 2

No. DATE REVISION

ISSUED FOR: **BID PLAN SET** ISSUE DATE: JAN 2025 APPROVED BY:

CJB

DRAWN BY: G & O JOB NO.:

CHECKED BY:

23445.02 FILE: SURVEY CONTROL-3.DWG

TWO INCHES AT FULL SCALE IF NOT, SCALE ACCORDINGLY

CIVIL

SURVEY CONTROL **KEY MAP AND ALIGNMENT TABLES** 

DRAWING: 2

### GENERAL NOTES TOWN OF YARROW POINT

- 1. THIS DEVELOPMENT PROJECT SHALL CONFORM TO THE TOWN OF YARROW POINT'S REQUIREMENTS AND BE IN ACCORDANCE WITH THE APPROVED PLANS. ANY CHANGES FROM THE APPROVED PLAN WILL REQUIRE APPROVAL FROM THE OWNER, ENGINEER, BUILDING OFFICIAL, TOWN ENGINEER, AND TOWN PLANNER AS APPLICABLE.
- 2. ALL WORKMANSHIP AND MATERIALS SHALL CONFORM TO THE "WASHINGTON STATE DEPARTMENT OF TRANSPORTATION (WSDOT) STANDARD SPECIFICATIONS FOR ROAD, BRIDGE, AND MUNICIPAL CONSTRUCTION" (LATEST EDITION), EXCEPT WHERE SUPPLEMENTED OR MODIFIED BY THE TOWN. COPIES OF THE ABOVE DOCUMENTS SHALL BE AVAILABLE AT THE JOB SITE DURING CONSTRUCTION.
- 3. A PRE-CONSTRUCTION MEETING IS REQUIRED PRIOR TO THE START OF ALL CONSTRUCTION. CONTACT THE TOWN ENGINEER OR THE TOWN BUILDING OFFICIAL TO SCHEDULE A MEETING.
- 4. LOCATIONS SHOWN FOR EXISTING UTILITIES ARE APPROXIMATE. THE CONTRACTOR IS CAUTIONED THAT OVERHEAD UTILITY LINES MAY NOT BE SHOWN ON THE DRAWINGS. IT SHALL BE THE CONTRACTOR'S RESPONSIBILITY TO DETERMINE THE TRUE ELEVATIONS AND LOCATIONS OF ALL UNDERGROUND UTILITIES AND THE EXTENT OF ANY HAZARDS CREATED BY OVERHEAD UTILITY LINES. IDENTIFICATION, LOCATION MARKING, AND RESPONSIBILITY FOR UNDERGROUND FACILITIES OR UTILITIES IS GOVERNED BY PROVISION OF CHAPTER 19.122 REVISED CODE OF WASHINGTON (RCW). PRIOR TO STARTING CONSTRUCTION, THE CONTRACTOR SHALL CALL ONECALL (1-800-424-5555) FOR UTILITY LOCATIONS (WATER, SANITARY SEWER, STORM SEWER, GAS, POWER, TELEPHONE, CABLE TELEVISION, AND INTERNET.
- 5. AS-BUILT DRAWINGS ARE REQUIRED PRIOR TO PROJECT ACCEPTANCE.
- 7. THE CONTRACTOR SHALL HAVE A COPY OF THESE PLANS AND THE CONTRACT SPECIFICATIONS ON THE JOB SITE WHENEVER CONSTRUCTION IS IN PROGRESS.
- 8. PER TOWN OF YARROW POINT MUNICIPAL CODE SECTION 10.12, CONTRACTOR'S VEHICLES, INCLUDING TRUCK AND TRAILER COMBINATIONS, SHALL NOT HAVE AN OVERALL LENGTH IN EXCESS OF 40 FEET.

**>>>>>** 

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9. ALL COSTS ASSOCIATED WITH RECORD DRAWINGS AND SPCC PLAN SHALL BE INCLUDED IN THE MOBILIZATION, CLEANUP, AND DEMOBILIZATION BID ITEM.

# STORM DRAINAGE NOTES TOWN OF YARROW POINT (MODIFIED; NOT ALL NOTES ARE SHOWN)

- 2. BEFORE ANY CONSTRUCTION MAY OCCUR, THE CONTRACTOR SHALL HAVE PLANS WHICH HAVE BEEN SIGNED AND APPROVED BY THE TOWN OF YARROW POINT, OBTAINED ALL TOWN, COUNTY, STATE, FEDERAL, AND OTHER REQUIRED PERMIETS, AND HAVE POSTED ALL REQUIRED BONDS.
- 4. ANY DEVIATION FROM THE APPROVED PLANS WILL REQUIRE WRITTEN APPROVAL. ALL CHANGES SHALL BE SUBMITTED TO THE TOWN.
- 6. ALL DISTURBED AREAS SHALL BE SEEDED AND MULCHED OR SIMILARLY STABILIZED TO THE SATISFACTION OF THE TOWN OF YARROW POINT FOR THE PREVENTION OF ON-SITE EROSION AFTER THE COMPLETION OF CONSTRUCTION.
- 9. ALL CATCH BASINS SHALL BE TYPE I UNLESS OTHERWISE NOTED. CATCH BASINS WITH A DEPTH OF OVER FIVE FEET (5') TO THE PIPE INVERT SHALL BE A TYPE II CATCH BASIN. TYPE II CATCH BASINS EXCEEDING FIVE FEET (5') IN DEPTH SHALL HAVE A STANDARD LADDER INSTALLED.
- 13. CONSTRUCTION OF DEWATERING (GROUNDWATER) SYSTEMS SHALL BE IN ACCORDANCE WITH THE APWA STANDARD SPECIFICATIONS.
- 15. ALL TRENCH BACKFILL SHALL BE COMPACTED TO 95 PERCENT DENSITY IN ROADWAYS, ROADWAY SHOULDERS, ROADWAY PRISM AND DRIVEWAYS, AND 85 PERCENT DENSITY IN UNPAVED AREAS. ALL PIPE ZONE COMPACTION SHALL BE 95 PERCENT.
- 16. THE CONTRACTOR SHALL BE RESPONSIBLE FOR PROVIDING ADEQUATE SAFEGUARDS, SAFETY DEVICES, PROTECTIVE EQUIPMENT, CONFINED SPACE PROTECTION, FLAGGERS, AND ANY OTHER NEEDED ACTIONS TO PROTECT THE LIFE, HEALTH, AND SAFETY OF THE PUBLIC, AND TO PROTECT PROPERTY IN CONNECTION WITH THE PERFORMANCE OF WORK COVERED BY THE CONTRACT. ANY WORK WITHIN THE TRAVELED RIGHT-OF-WAY THAT MAY INTERRUPT NORMAL TRAFFIC FLOW SHALL REQUIRE A TRAFFIC CONTROL PLAN APPROVED BY THE TOWN OF YARROW POINT. ALL SECTIONS OF THE WSDOT STANDARD SPECIFICATIONS, TRAFFIC CONTROL SECTION, AND THE MANUAL OF UNIFORM TRAFFIC CONTROL DEVICES (MUTCD) SHALL APPLY.
- 19. APPROXIMATE LOCATIONS OF EXISTING UTILITIES HAVE BEEN OBTAINED FROM AVAILABLE RECORDS AND ARE SHOWN FOR CONVENIENCE. THE CONTRACTOR SHALL BE RESPONSIBLE FOR VERIFICATION OF EXISTING UTILITY LOCATIONS WHETHER OR NOT THESE UTILITIES ARE SHOWN ON THE PLANS. THE CONTRACTOR SHALL EXERCISE ALL CARE TO AVOID DAMAGE TO ANY UTILITY. IF CONFLICTS WITH EXISTING UTILITIES ARISE DURING CONSTRUCTION, THE CONTRACTOR SHALL NOTIFY THE TOWN ENGINEER OR THE TOWN BUILDING OFFICIAL IMMEDIATELY AND ANY CHANGES REQUIRED SHALL BE APPROVED BY THE APPROPRIATE TOWN STAFF PRIOR TO COMMENCEMENT OF RELATED CONSTRUCTION ON THE PROJECT.
- 22. ALL INLET, MANHOLE, AND CATCH BASIN FRAMES AND GRATES SHALL NOT BE ADJUSTED TO GRADE UNTIL IMMEDIATELY PRIOR TO FINAL PAVING. ALL CATCH BASIN GRATES SHALL BE SET 0.10' BELOW PAVEMENT LEVEL.
- 25. GROUT ALL SEAMS AND OPENINGS IN ALL INLETS, CATCH BASINS, AND MANHOLES.

# TEMPORARY EROSION/SEDIMENTATION NOTES TOWN OF YARROW POINT (MODIFIED; NOT ALL NOTES ARE SHOWN)

1. THE APPROVED CONSTRUCTION SEQUENCE SHALL BE AS FOLLOWS:

a. CONDUCT PRE-CONSTRUCTION MEETING.

b. FLAG OR FENCE CLEARING LIMITS.

- d. INSTALL CATCH BASIN PROTECTION IF REQUIRED.
- f. INSTALL PERIMETER PROTECTION (SILT FENCE, BRUSH BARRIER, ETC.). IF REQUIRED.

### H. OPADE AND STABILIZE CONCENSION ROADS.

### DRAING, ETC.) CIMULTANEOUGLY WITH CLEARING AND CRADING FOR PROJECT

- MAINTAIN EROSION CONTROL MEASURES IN ACCORDANCE WITH TOWN OF YARROW POINT STANDARDS AND MANUFACTURER'S RECOMMENDATIONS.
- k. RELOCATE EROSION CONTROL MEASURES OR INSTALL NEW MEASURES SO THAT AS SITE CONDITIONS CHANGE, THE EROSION AND SEDIMENT CONTROL IS ALWAYS IN ACCORDANCE WITH THE TOWN TESC MINIMUM REQUIREMENTS.
- I. COVER ALL AREAS WITHIN THE SPECIFIED TIME FRAME WITH STRAW, WOOD FIBER MULCH, COMPOST, PLASTIC SHEETING, CRUSHED ROCK OR EQUIVALENT.

### CTABILIZE ALL ADEAS THAT DEACH FINAL CDADE WITHIN 7 DAVS

- o. UPON COMPLETION OF THE PROJECT, ALL DISTURBED AREAS MUST BE STABILIZED AND BEST MANAGEMENT PRACTICES REMOVED IF APPROPRIATE.
- 3. THE IMPLEMENTATION OF THIS ESC PLAN AND THE CONSTRUCTION, MAINTENANCE, REPLACEMENT, AND UPGRADING OF THESE ESC FACILITIES IS THE RESPONSIBILITY OF THE PERMITTEE/CONTRACTOR UNTIL ALL CONSTRUCTION IS APPROVED.
- 5. THE ESC FACILITIES SHOWN ON THIS PLAN MUST BE CONSTRUCTED PRIOR TO OR IN CONJUNCTION WITH ALL CLEARING AND GRADING ACTIVITIES IN SUCH A MANNER AS TO ENSURE THAT SEDIMENT-LADEN WATER DOES NOT ENTER THE DRAINAGE SYSTEM OR VIOLATE APPLICABLE WATER STANDARDS. WHEREVER POSSIBLE, MAINTAIN NATURAL VEGETATION FOR SILT CONTROL.
- 6. THE ESC FACILITIES SHOWN ON THIS PLAN ARE THE MINIMUM REQUIREMENTS FOR ANTICIPATED SITE CONDITIONS. DURING THE CONSTRUCTION PERIOD, THESE ESC FACILITIES SHALL BE UPGRADED (E.G. ADDITIONAL SUMPS, RELOCATION OF DITCHES AND SILT FENCES, ETC.) AS NEEDED FOR UNEXPECTED STORM EVENTS. ADDITIONALLY, MORE ESC FACILITIES MAY BE REQUIRED TO ENSURE COMPLETE SILTATION CONTROL. THEREFORE, DURING THE COURSE OF CONSTRUCTION IT SHALL BE THE OBLIGATION AND RESPONSIBILITY OF THE CONTRACTOR TO ADDRESS ANY NEW CONDITIONS THAT MAY BE CREATED BY HIS ACTIVITIES AND TO PROVIDE ADDITIONAL FACILITIES OVER AND ABOVE THE MINIMUM REQUIREMENTS AS MAY BE NEEDED.
- 7. THE ESC FACILITIES SHALL BE INSPECTED BY THE PERMITTEE/CONTRACTOR DAILY DURING NON-RAINFALL PERIODS, EVERY HOUR (DAYLIGHT) DURING RAINFALL EVENTS, AT THE END OF EVERY RAINFALL, AND MAINTAINED AS NECESSARY TO ENSURE THEIR CONTINUED FUNCTIONING. IN ADDITION, TEMPORARY SILTATION PONDS AND ALL TEMPORARY SILTATION CONTROLS SHALL BE MAINTAINED IN A SATISFACTORY CONDITION UNTIL SUCH TIME THAT CLEARING AND/OR CONSTRUCTION IS COMPLETED, PERMANENT DRAINAGE FACILITIES ARE OPERATIONAL, AND THE POTENTIAL FOR EROSION HAS PASSED. WRITTEN RECORDS SHALL BE KEPT DOCUMENTING THE REVIEWS OF THE ESC FACILITIES.
- ). ALL DENUDED SOILS MUST BE STABILIZE WITH AN APPROVED TESC METHOD (E.G. SEEDING, MULCHING, PLASTIC COVERING, CRUSHED ROCK) WITHIN THE FOLLOWING TIMELINES:
  - a. MAY 1 TO SEPTEMBER 30 SOILS MUST BE STABILIZED WITHIN 7 DAYS OF GRADING.
- b. OCTOBER 1 TO APRIL 30 SOILS MUST BE STABILIZED WITHIN 2 DAYS OF GRADING
- c. STABILIZE SOILS AT THE END OF THE WORKDAY PRIOR TO A WEEKEND, HOLIDAY, OR PREDICTED RAIN EVENT.
- 10. AT NO TIME SHALL MORE THAN 1' OF SEDIMENT BE ALLOWED TO ACCUMULATE WITHIN A CATCH BASIN. ALL CATCH BASINS AND CONVEYANCE LINES SHALL BE CLEANED PRIOR TO PAVING. THE CLEANING OPERATION SHALL NOT FLUSH SEDIMENT-LADEN WATER INTO THE DOWNSTREAM SYSTEM.


- 17. THE ESC FACILITIES SHALL BE CONSTRUCTED IN ACCORDANCE WITH THE DETAILS ON THE APPROVED PLANS. LOCATIONS MAY BE MOVED TO SUIT FIELD CONDITIONS, SUBJECT TO APPROVAL BY THE TOWN ENGINEER OR THE TOWN BUILDING OFFICIAL.
- 21. OFF-SITE STREETS MUST BE KEPT CLEAN AT ALL TIMES. IF DIRT IS DEPOSITED ON THE PUBLIC STREET SYSTEM THE STREET SHALL BE IMMEDIATELY CLEANED WITH POWER SWEEPER OR OTHER EQUIPMENT.
- 22. ANY CATCH BASINS COLLECTING RUNOFF FROM THE SITE, WHETHER THEY ARE ON OR OFF THE SITE, SHALL HAVE THEIR GRATES COVERED WITH FILTER FABRIC DURING CONSTRUCTION. CATCH BASINS DIRECTLY DOWNSTREAM OF THE CONSTRUCTION ENTRANCE OR ANY OTHER CATCH BASIN AS DETERMINED BY THE TOWN ENGINEER OR TOWN BUILDING OFFICIAL SHALL BE PROTECTED WITH A "FILTER FABRIC SOCK" OR EQUIVALENT.
- 26. ALL PROPERTIES ADJACENT TO THE PROJECT SITE SHALL BE PROTECTED FROM SEDIMENT DEPOSITION AND RUNOFF.
- 27. DO NOT FLUSH CONCRETE BY-PRODUCTS OR TRUCKS NEAR OR INTO THE STORM DRAINAGE SYSTEM. IF EXPOSED AGGREGATE IS FLUSHED INTO THE STORM SYSTEM, IT COULD MEAN RE-CLEANING THE ENTIRE DOWNSTREAM STORM SYSTEM, OR POSSIBLY RE-LAYING THE STORM LINE.
- 28. PRIOR TO OCTOBER 1 OF EACH YEAR (THE BEGINNING OF THE WET SEASON), ALL DISTURBED AREAS SHALL BE REVIEWED TO IDENTIFY WHICH ONES CAN BE SEEDED IN PREPARATION FOR THE WINTER RAINS. THE IDENTIFIED DISTURBED AREA SHALL BE SEEDED WITHIN ONE WEEK AFTER OCTOBER 1. A SITE PLAN DEPICTING THE AREAS TO BE SEEDED AND THE AREAS TO REMAIN UNCOVERED SHALL BE SUBMITTED TO THE TOWN ENGINEER. THE TOWN ENGINEER CAN REQUIRE SEEDING OF ADDITIONAL AREAS IN ORDER TO PROTECT SURFACE WATERS, ADJACENT PROPERTIES, OR DRAINAGE FACILITIES.
- 30. A WATER TRUCK SHALL BE ON SITE AT ALL TIMES TO PROVIDE DUST CONTROL. THIS WORK SHALL BE INCIDENTAL TO CONSTRUCTION, SEE SECTION 2-07.



3710 168TH STREET NORTHEAST BUILDING B, SUITE 210 ARLINGTON, WA 98223 (360) 454-5490





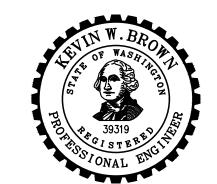

TOWN OF YARROW POINT

SALLY'S ALLEY PHASE 2

No. DATE REVISION

ISSUED FOR:

**BID PLAN SET** 

ISSUE DATE: JAN 2025
APPROVED BY: KWB
CHECKED BY: CJB
DRAWN BY: MAN

G & O JOB NO.: 23445.02

FILE: GEN NOTES.DWG

TWO INCHES AT FULL SCALE.
IF NOT, SCALE ACCORDINGLY

GENERAL

GENERAL CONSTRUCTION

NOTES

RAWING: 3 OF: 9

RIGHT-OF-WAY DISCLAIMER

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APPROXIMATE.

APPROVAL FOR CONSTRUCTION

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CALL BEFORE YOU DIG

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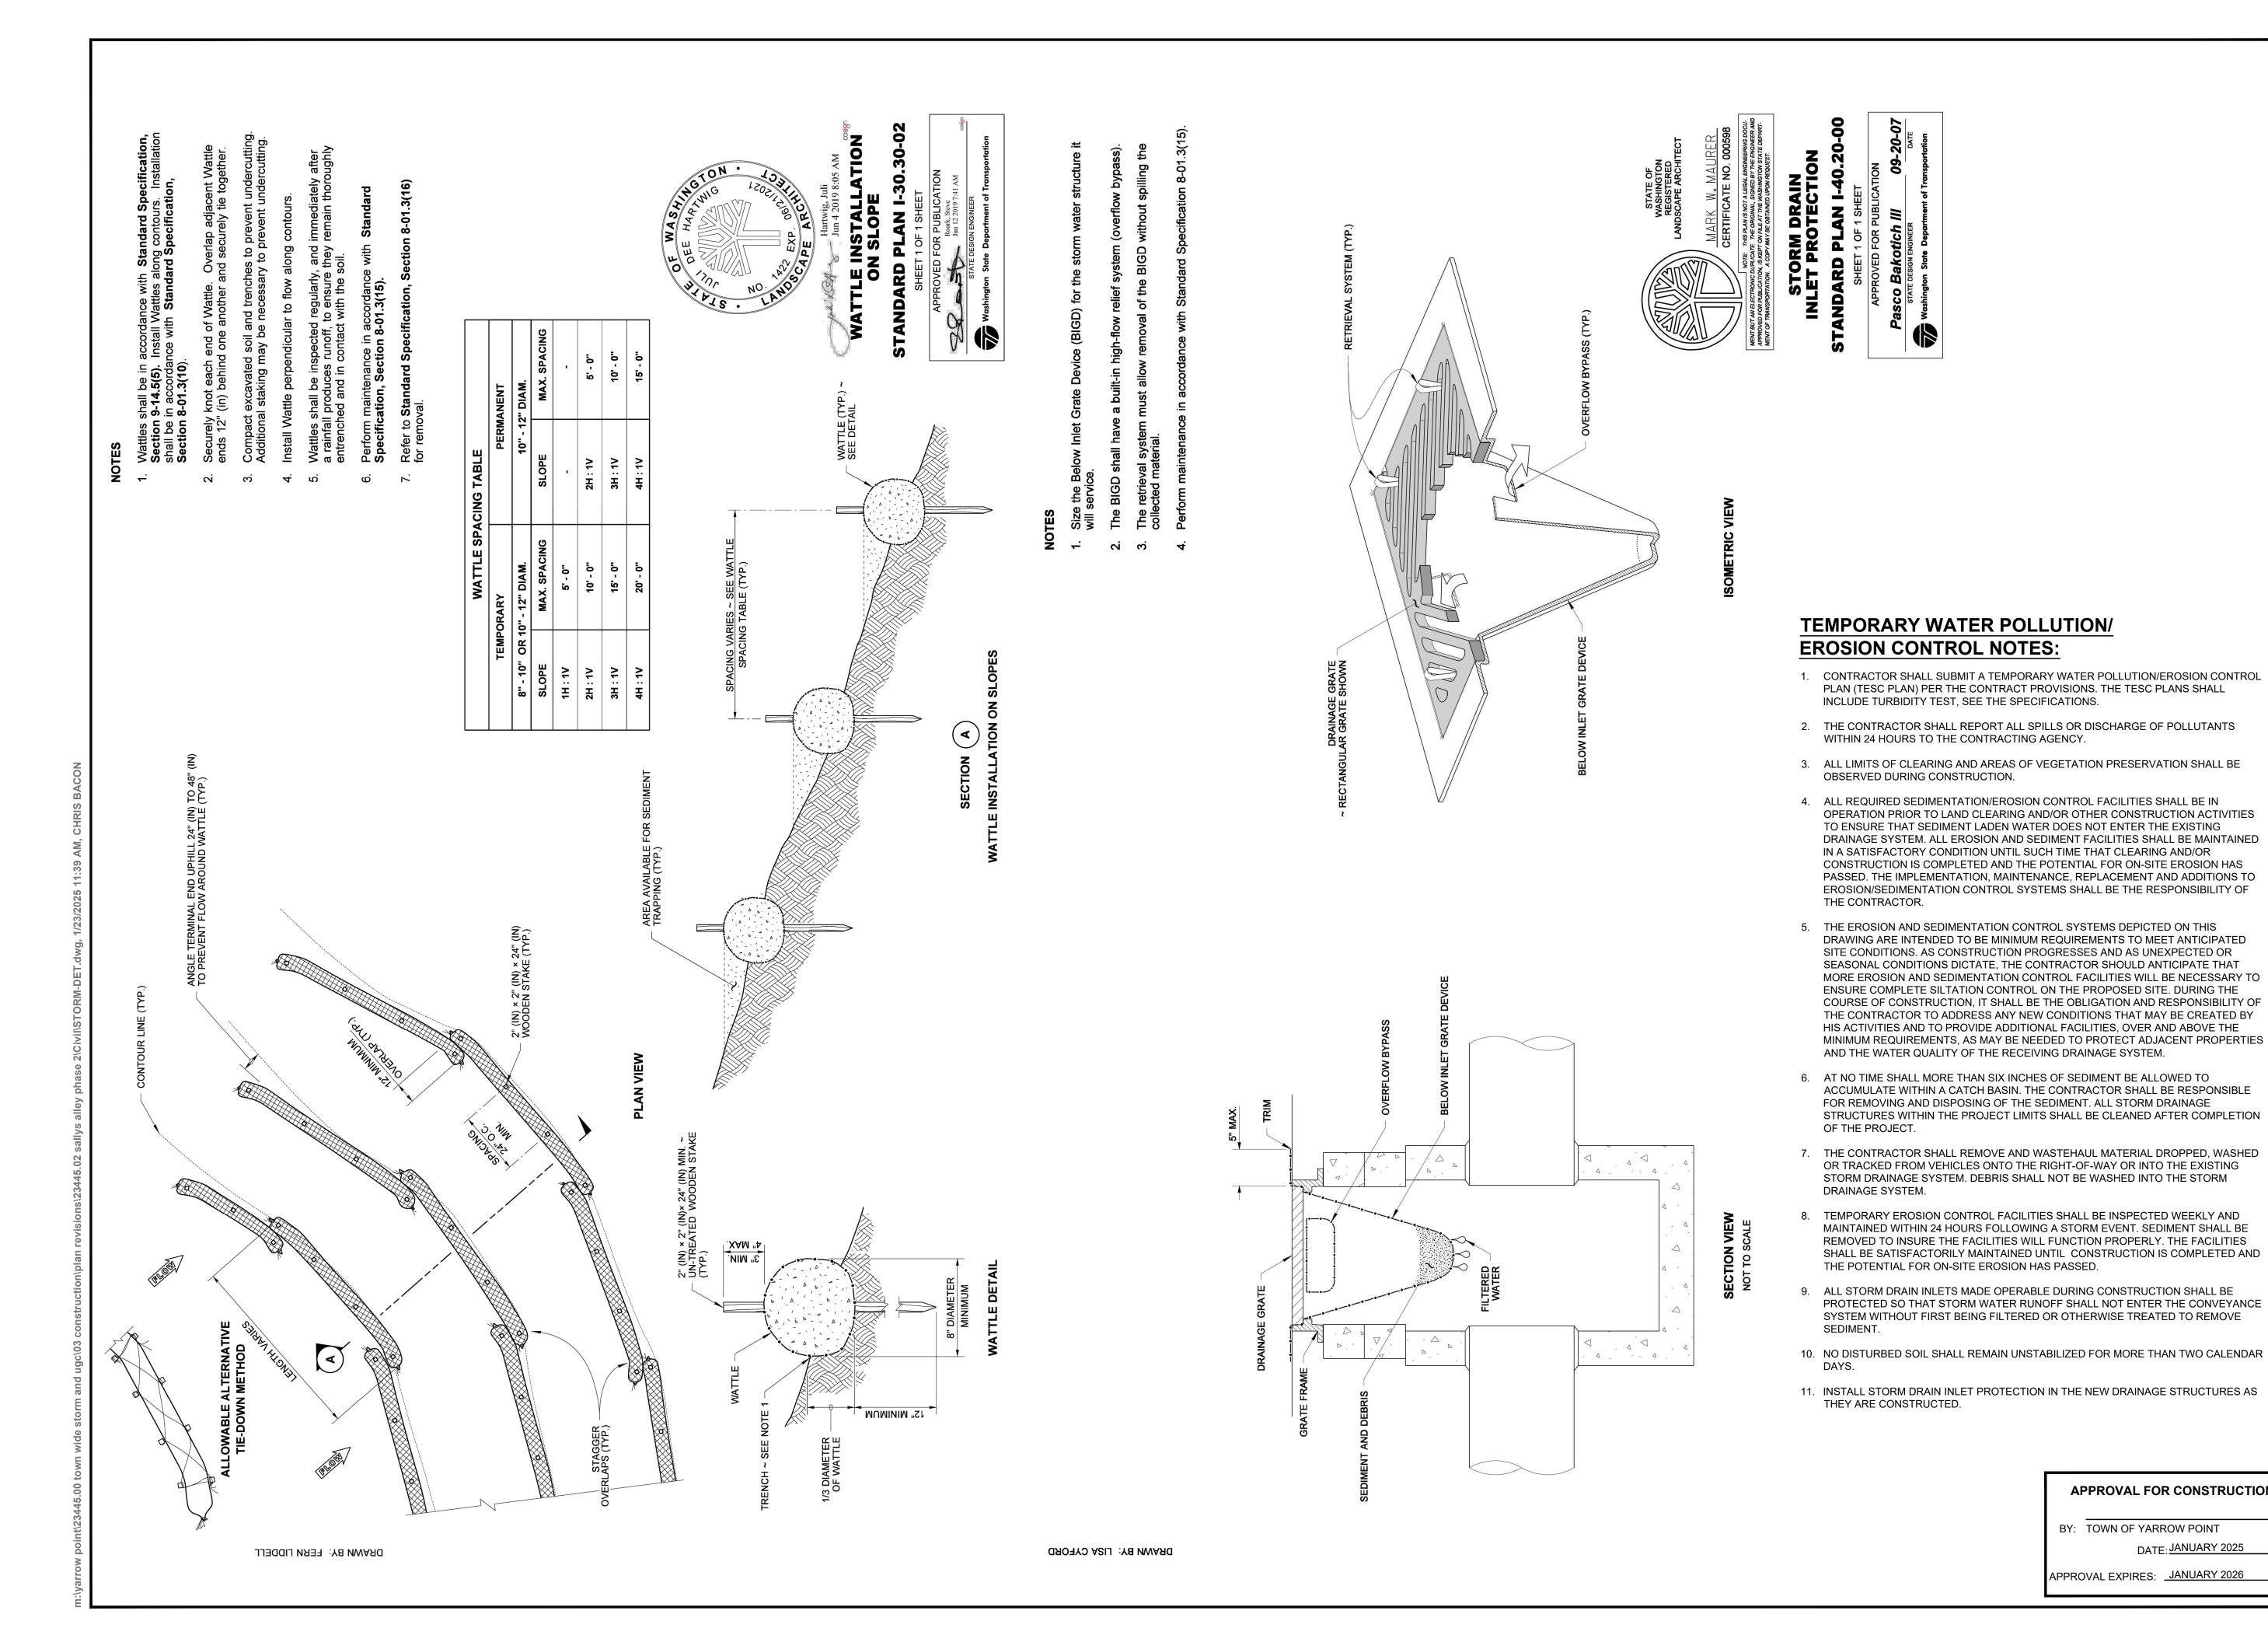
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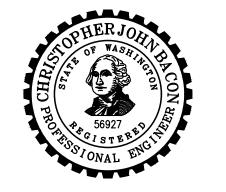





Gray & Osborne, Inc.

3710 168TH STREET NORTHEAST.





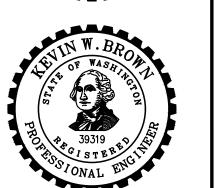

### **TOWN OF YARROW POINT**

SALLY'S ALLEY PHASE 2

No. DATE REVISION

**BID PLAN SET** ISSUE DATE: JAN 2025 APPROVED BY: CHECKED BY: CJB

G & O JOB NO.: 23445.02 STORM-DET.DWG

TWO INCHES AT FULL SCALE IF NOT, SCALE ACCORDINGLY

**TEMPORARY EROSION CONTROL DETAILS** 

APPROVAL FOR CONSTRUCTION

DATE: JANUARY 2025

BY: TOWN OF YARROW POINT


APPROVAL EXPIRES: <u>JANUARY 2026</u>

ISSUED FOR:

DRAWN BY:


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DRAWING: 4 OF: 9

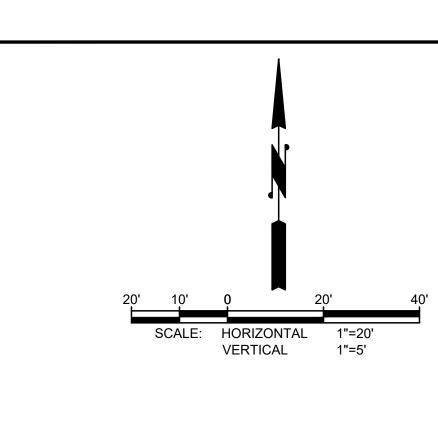

STORM DRAIN INLET PROTECTION PER TEMPORARY WATER POLUTION/EROSION CONTROL NOTES, SEE SHEET 4

APPROX. TREE PROTECTION AREA (±15' RADIUS AROUND TREE). CONTRACTOR SHALL NOTIFY THE CONTRACTING AGENCY PRIOR TO CUTTING ANY ROOTS 2" DIAMETER OR GREATER.

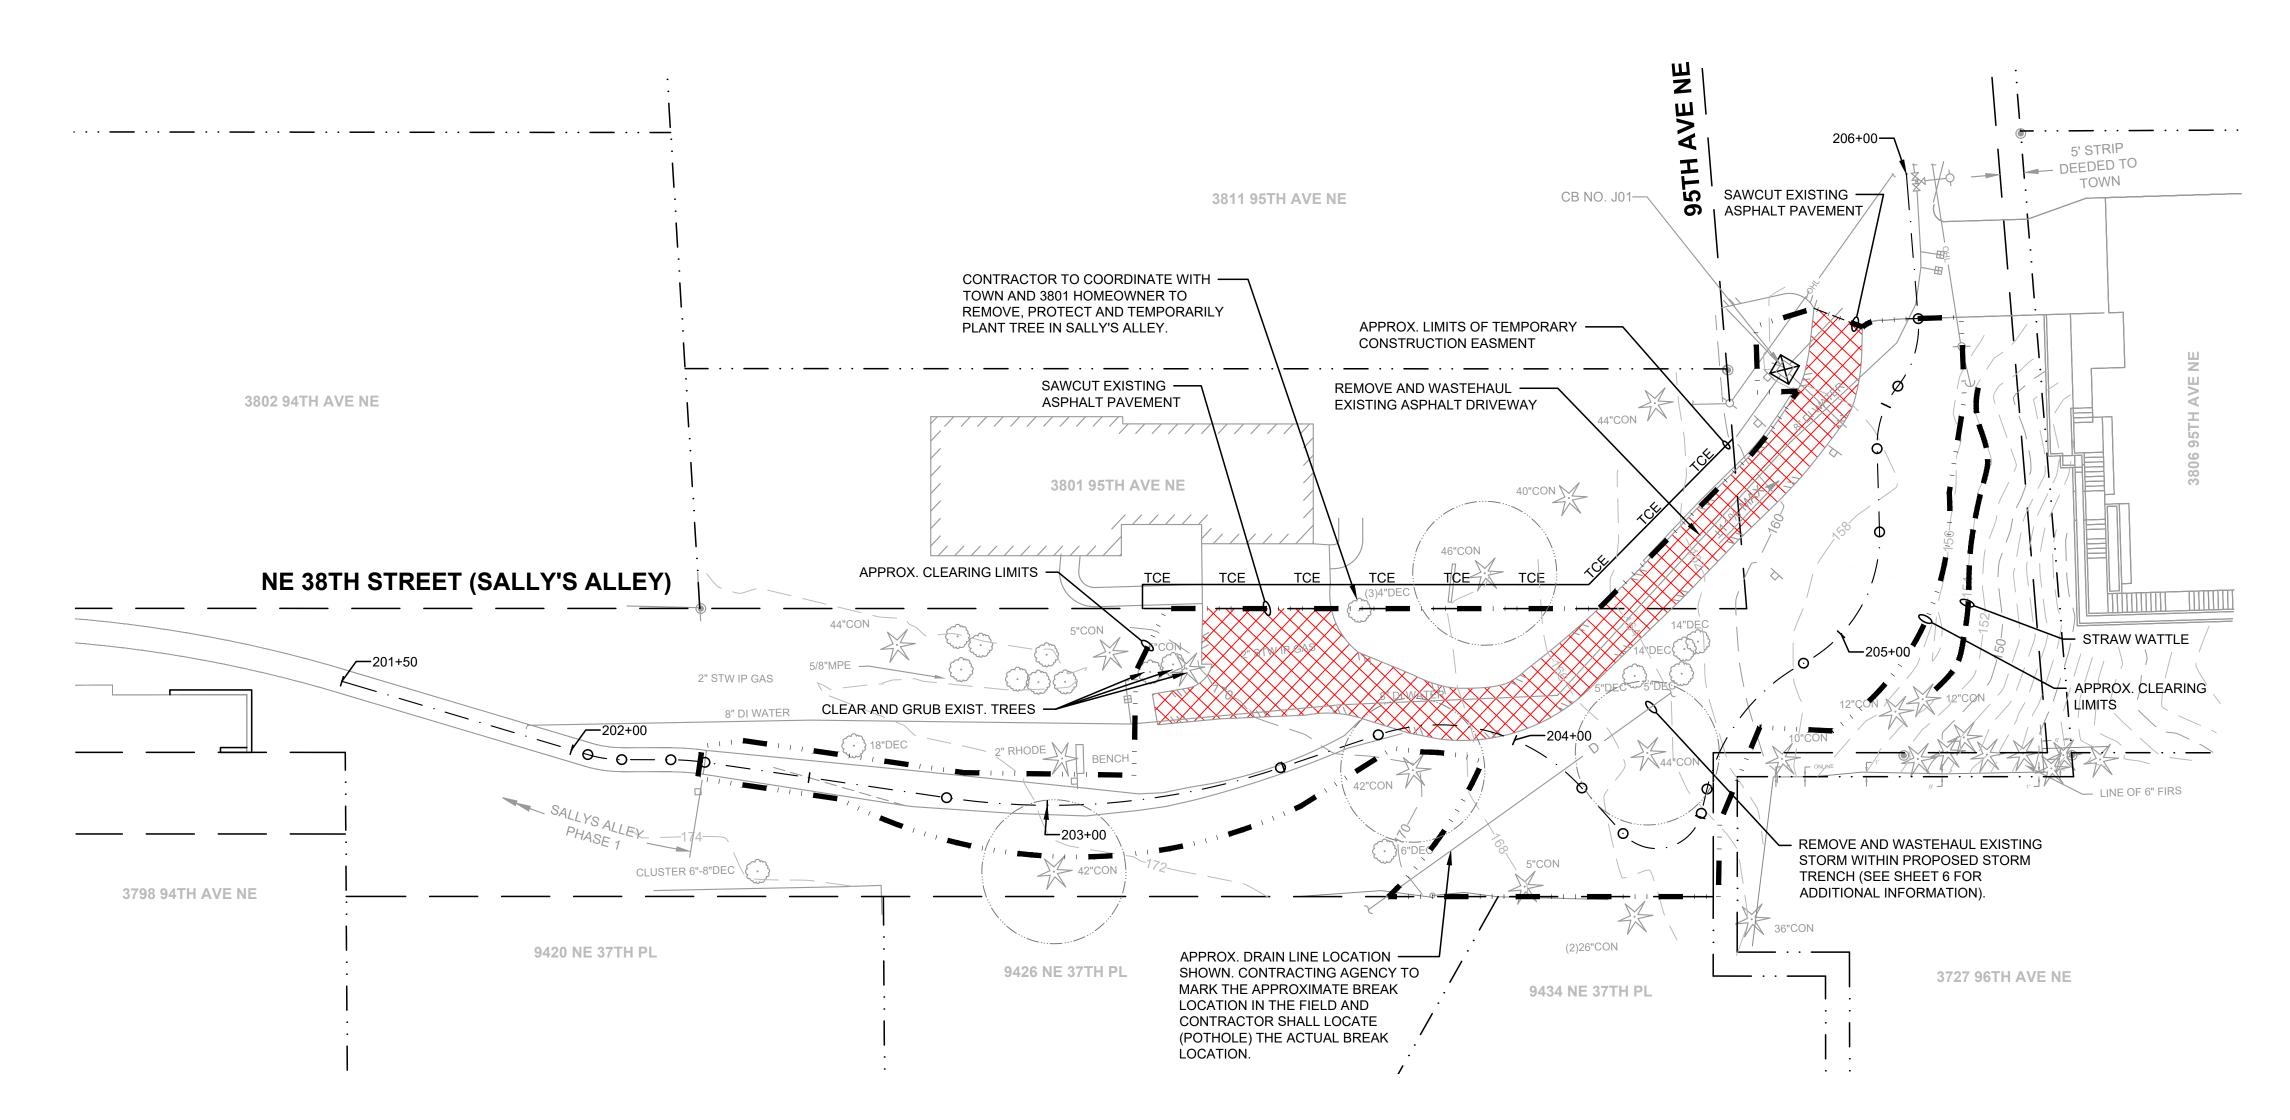

**BURIED UTILITIES IN AREA CALL BEFORE YOU DIG** 1-800-424-5555 EXISTING UTILITIES SHOWN ARE FROM THE BEST AVAILABLE INFORMATION AND NO GUARANTEE IS MADE AS TO THE EXACT SIZE, TYPE, LOCATION OR DEPTH

### RIGHT-OF-WAY DISCLAIMER

THE RIGHT-OF-WAY AND/OR PROPERTY LINES SHOWN HEREON ARE BASED ON AVAILABLE INFORMATION, NOT ON A SURVEYED LOCATION AND ARE ONLY APPROXIMATE.

### APPROVAL FOR CONSTRUCTION

BY: TOWN OF YARROW POINT

DATE: JANUARY 2025


APPROVAL EXPIRES: <u>JANUARY 2026</u>


Gray & Osborne, Inc.

3710 168TH STREET NORTHEAST

BUILDING B, SUITE 210 ARLINGTON, WA 98223 (360) 454-5490



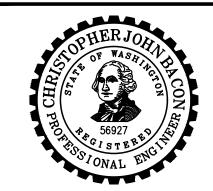

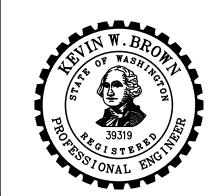

**TOWN OF** YARROW POINT

**SALLY'S ALLEY** PHASE 2

No. DATE REVISION ISSUED FOR:

**BID PLAN SET** ISSUE DATE: JAN 2025 APPROVED BY: KWB CHECKED BY: CJB MAN DRAWN BY:


G & O JOB NO.: 23445.02 STORM P&P.DWG

TWO INCHES AT FULL SCALE. IF NOT, SCALE ACCORDINGLY


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TESC AND DEMO PLAN


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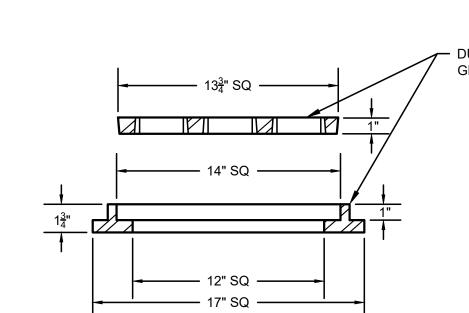
DRAWN BY: LISA CYFORD

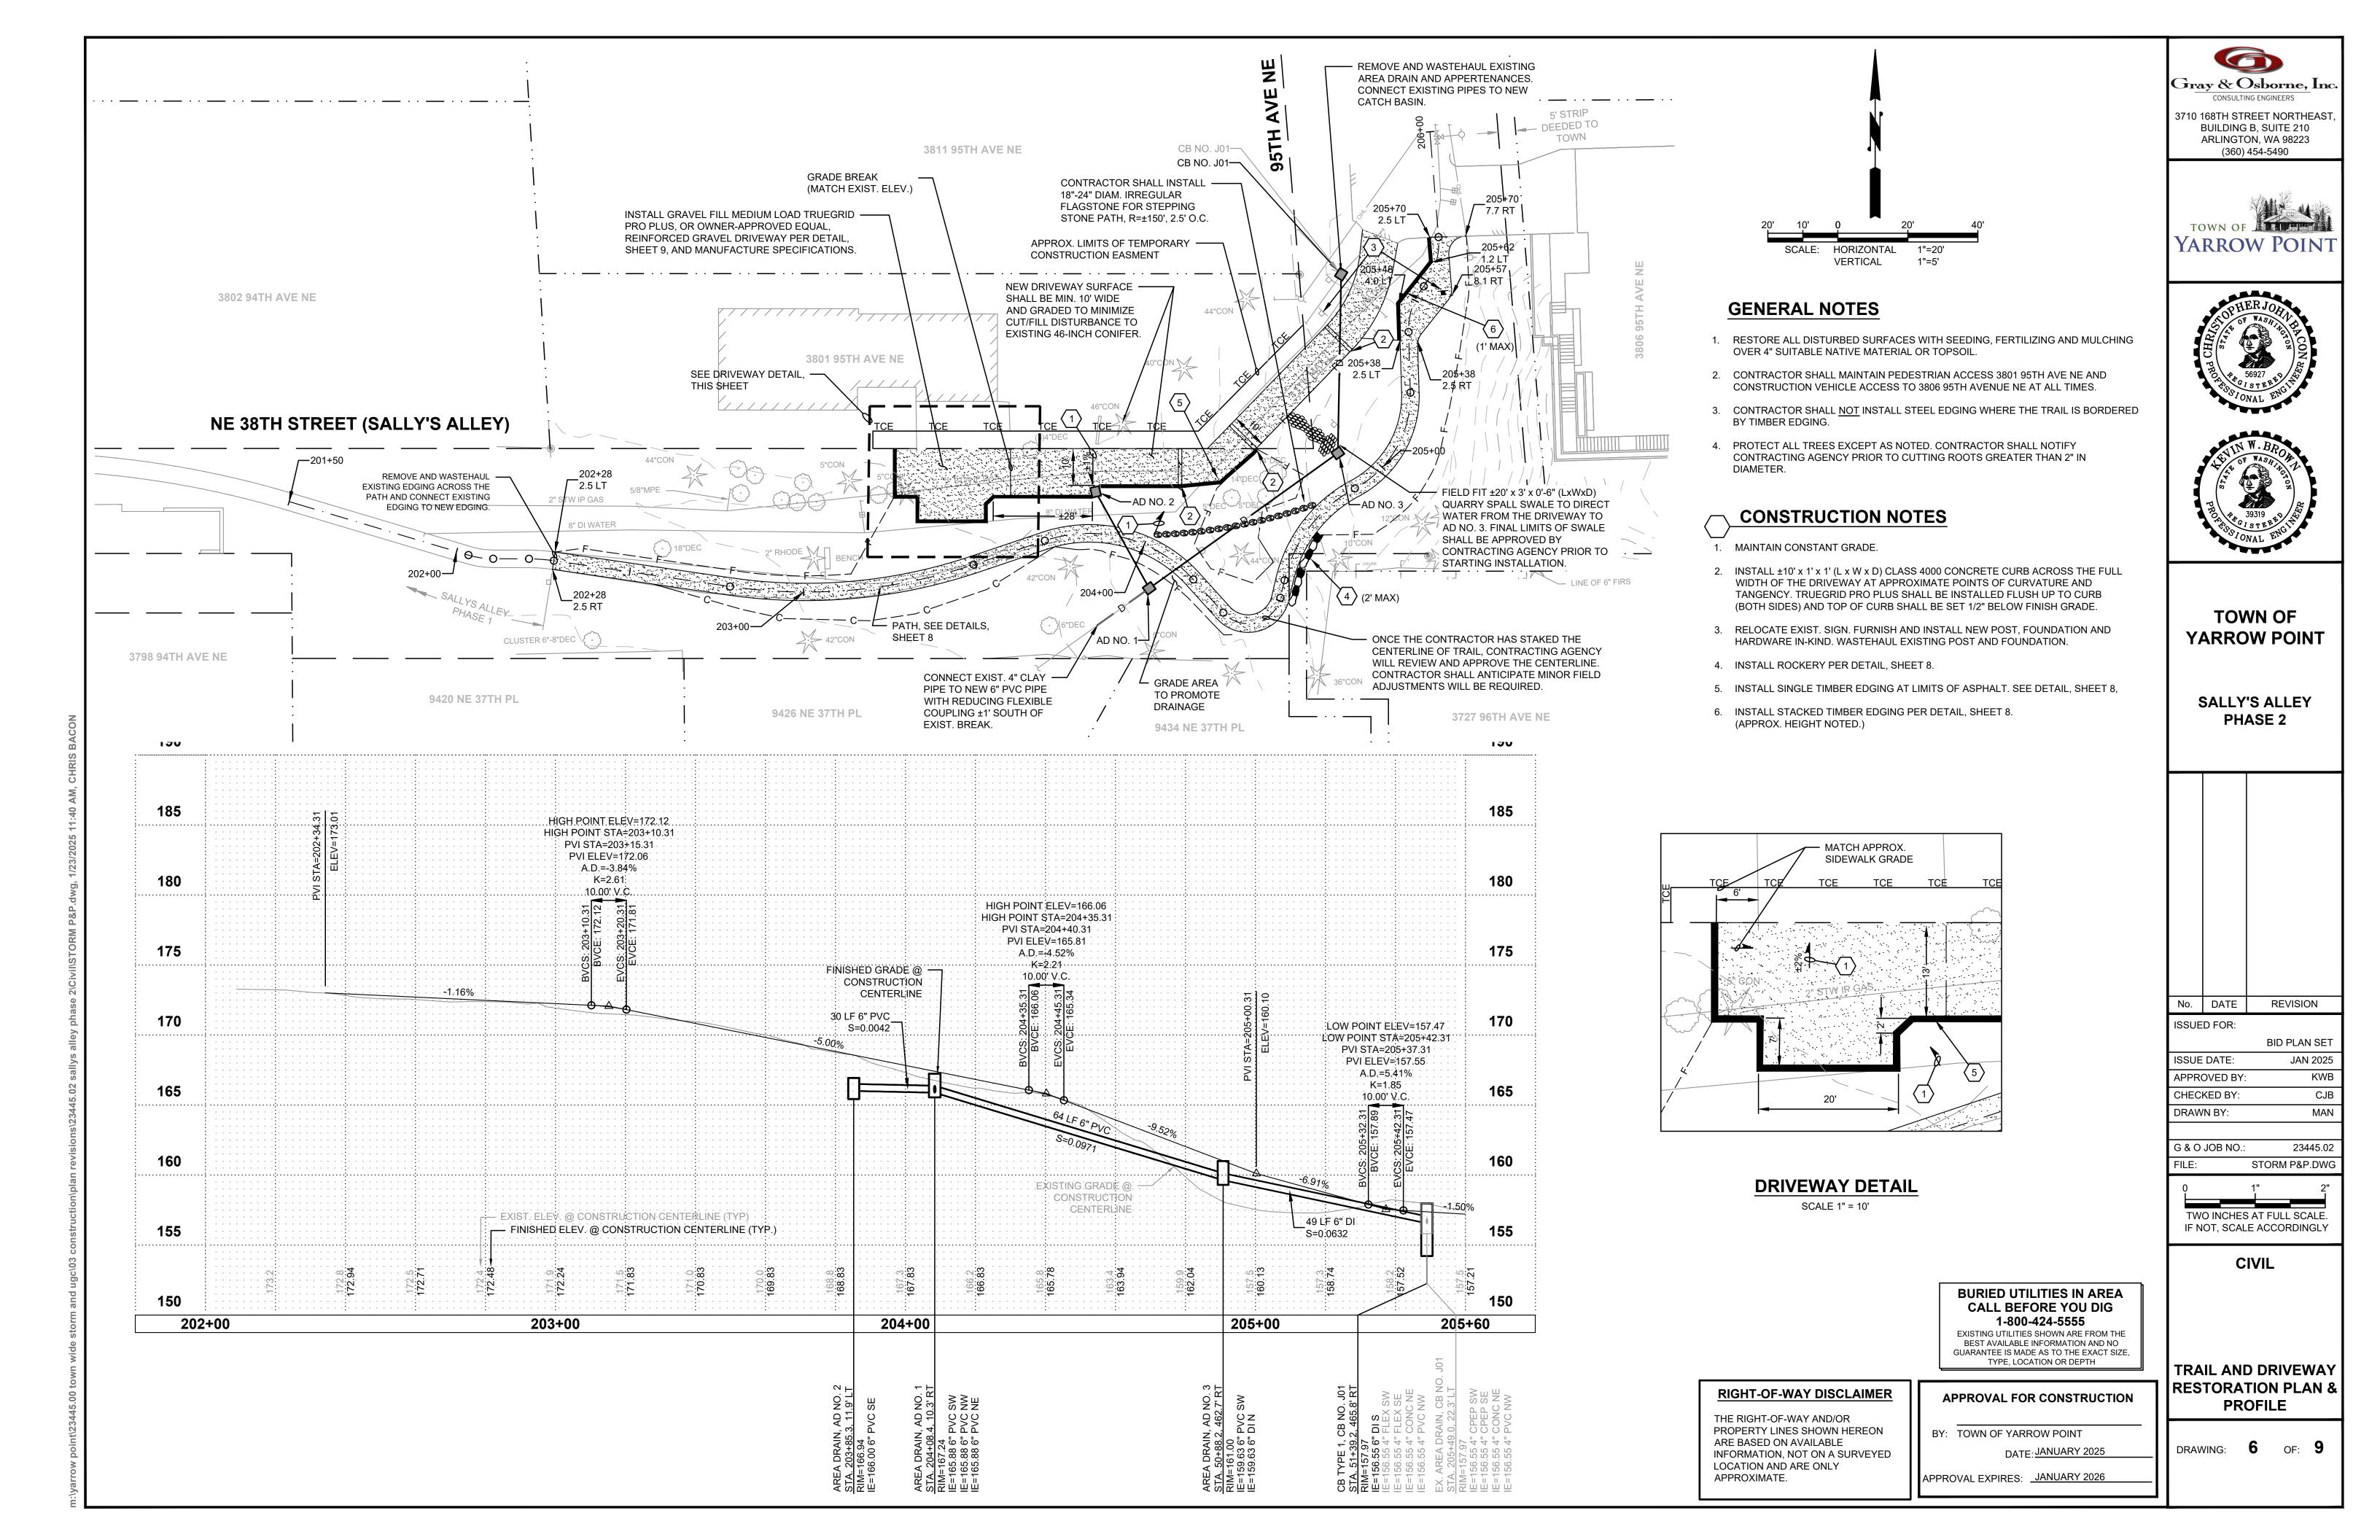


FIFE ALLOWANCES	NCES
PIPE MATERIAL	MAXIMUM INSIDE DIAMETER (INCHES)
REINFORCED OR PLAIN CONCRETE	12"
ALL METAL PIPE	15"
CPSSP ★ (STD. SPEC. SECT. 9-05.20)	12"
SOLID WALL PVC (STD. SPEC. SECT. 9-05.12(1))	15"
PROFILE WALL PVC (STD. SPEC. SECT. 9-05.12(2))	15"

PIPE MATERIAL	MAXIMUM INSIDE DIAMETER (INCHES)
EINFORCED OR JAIN CONCRETE	12"
LL METAL PIPE	15"
PSSP ★ TD. SPEC. SECT. 9-05.20)	12"
OLID WALL PVC TD. SPEC. SECT. 9-05.12(1))	15"
SOFII F WALL BVC	į

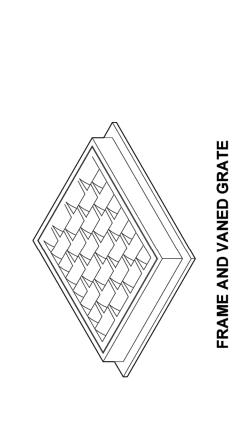PIPE MATERIAL	INSIDE DIAMETER (INCHES)	
IFORCED OR N CONCRETE	12"	
METAL PIPE	15"	
SP ★ 0. SPEC. SECT. 9-05.20)	12"	
ID WALL PVC SPEC. SECT. 9-05.12(1))	15"	
FILE WALL PVC	<u>.</u> 2.	

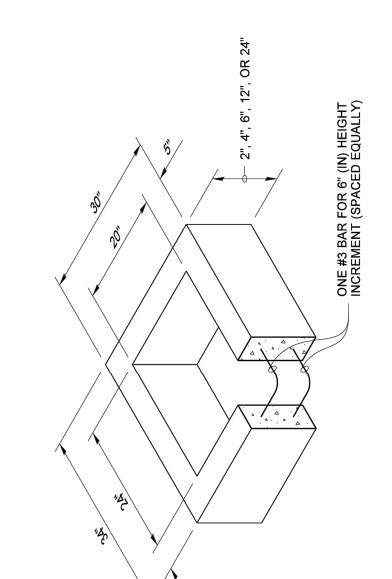

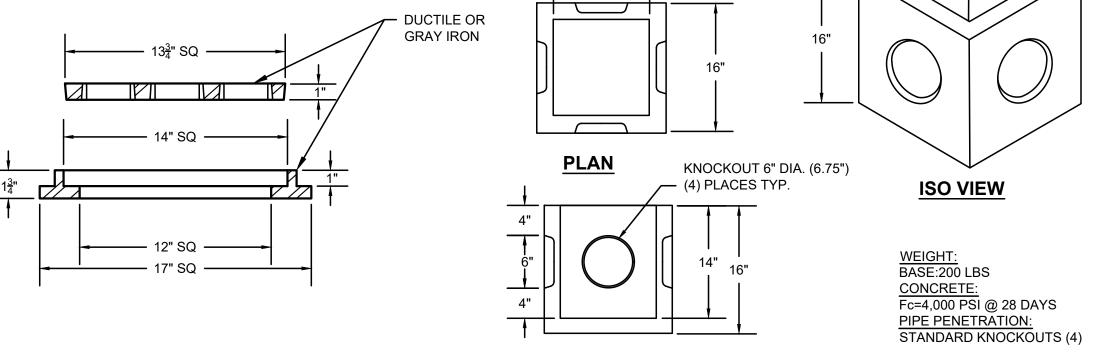

SIDE

### **AREA DRAIN FRAME AND GRATE**

NOT TO SCALE

**AREA DRAIN** NOT TO SCALE



Gray & Osborne, Inc.

3710 168TH STREET NORTHEAST, BUILDING B, SUITE 210 ARLINGTON, WA 98223 (360) 454-5490

YARROW POINT

YARROW POINT

**SALLY'S ALLEY** PHASE 2

1	E	1
	D	<b>→</b>
RI	NISHED GRADE, ESTORE AS OTED ON PLANS	
SUITABLE EXCAVATED MATERIAL OR IMPORTED MATERIAL MEETING THE REQUIREMENTS OF BANK RUN GRAVEL FOR TRENCH BACKFILL		DEPTH VARIES
SPECIAL PRECAUTIONS TO PROTECT PIPE TO THIS LEVEL	&	<u> </u>
TOP OF PIPE BEDDING		
EX. STORM PIPE TO  BE REMOVED AND  WASTEHAULED		
STORM/SEWER PIPE		
GRAVEL BACKFILL FOR PIPE ZONE BEDDING		1/2 PIPE O.D.
BEDDING		<u>"</u>
<b>\</b>	B B	UNDISTURBED EARTH

### **TYPICAL** TRENCH SECTION

NOT TO SCALE

_	4", 6", & 8" DIAMETER PIPE												
		6' OR											
	Α	LESS	8'	10'	12'	14'	16'	18'	20'	22'	24'	26'	28'
	В						2.	50'					
	С	1.50'	1.50'	1.75'	2.25'	2.75'	3.25'	3.75'	4.25'	4.75'	5.25'	5.75'	6.25'
	D	5.50'	5.50'	6.00'	7.00'	8.00'	9.00'	10.00'	11.00'	12.00'	13.00'	14.00'	15.00'
	Ē						SEE F	LANS					
	F		4 in										

APPROVAL	FOR	CONS	TRUC	ΓΙΟΝ

BY: TOWN OF YARROW POINT

APPROVAL EXPIRES: JANUARY 2026

No.	DATE	REVISION
	D FOR:	NEVIOION .
10001	D I OIX.	BID PLAN SET
ISSUE	DATE:	JAN 2025
APPR	OVED BY:	KWB
CHEC	KED BY:	CJB
DRAW	N BY:	MAN

TWO INCHES AT FULL SCALE.
IF NOT, SCALE ACCORDINGLY CIVIL

23445.02

CON-DET.DWG

G & O JOB NO.:

CONSTRUCTION **DETAILS** 

DRAWING: 7 OF: 9 DATE: JANUARY 2025

### NOTES:

1. TRANSITION SLOPE TO MAINTAIN POSITIVE DRAINAGE OFF THE PATH.

### TYPICAL PATH SECTION NOT TO SCALE

BORDER CONCEPTS "BORDER KING" STEEL EDGING, DURASTEEL EDGING, OR APPROVED EQUAL, ON BOTH SIDES (1/2" REVEAL TYP). CONSTRUCTION CENTERLINE 1/4" MINUS GRAVEL 2" COMPACTED DEPTH SEE NOTE 1 CSTC, 4" MIN. DEPTH **GRAVEL BORROW** (DEPTH VARIES) PATH WIDTH VARIES SEE PLANS

### NOTES:

- RESTORE

PER PLAN

- 1 FT MIN WIDTH BETWEEN ROCKS AND LIMITS OF EXCAVATION. 4" COMPACTED DEPTH CRUSHED SURFACING TOP COURSE

-6" COMPACTED (95%) CRUSHED

SURFACING BASE COURSE LEVELING

OVER GEOTEXTILE FABRIC

— TOP ELEVATION

— 2-MAN ROCK

- APPROX.

FACE OF WALL @


STEEL

**EDGING** 

SLOPE TO DRAIN


- TRANSITION SLOPE TO MAINTAIN POSITIVE DRAINAGE.
- 2. ALL DEPTHS ARE COMPACTED DEPTHS.

TYPICAL PATH DETAIL NOT TO SCALE

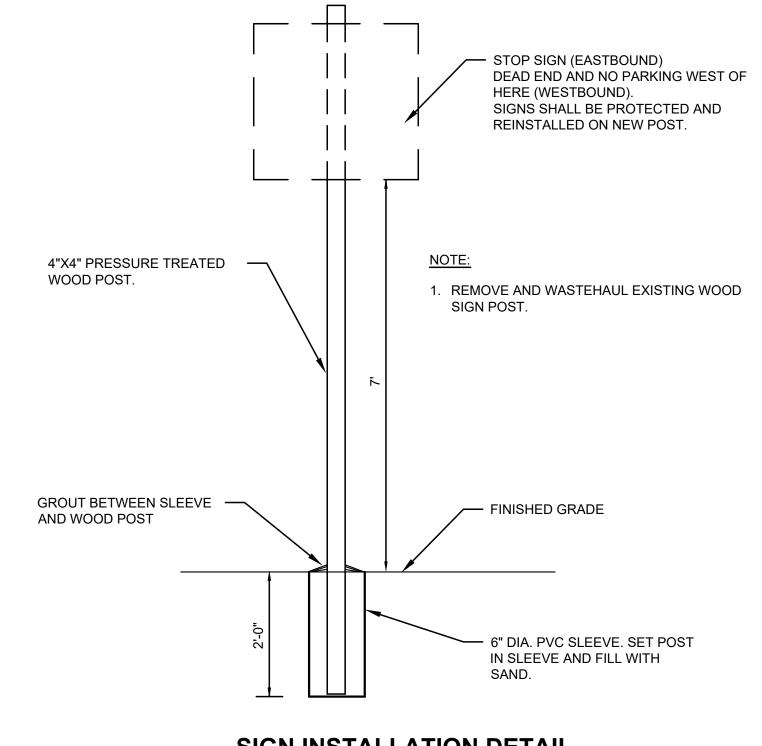

### SIGN INSTALLATION DETAIL

NOT TO SCALE

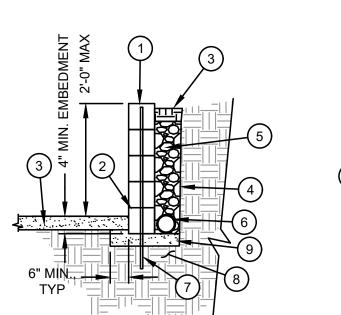

(1) COUNTERSINK REBAR AND FILL HOLE WITH ACRYLIC CAULK, 1/2" DEEP (2) LANDSCAPE TIMBER (5 1/2" x 51/2")

(3) SEE PLAN S.

4) FILTER GEOTEXTILE FABRIC SHALL BE MODERATE SURVIVABILITY CLASS A PER SECTION 9-33.1 OF THE WSDOT STANDARD SPECIFICATIONS.FABRIC

(5) GRAVEL BACKFILL FOR DRAINS

(6) PERFORATED 4" DRAIN PIPE, DAYLIGHT AT END OF TIMBER EDGING


(7) #5 REBAR, 2'-0" MIN EMBEDMENT.

(8) COMPACTED SUBGRADE

9) 4" CSTC LEVELING PAD

1. HEIGHT SHALL BE 4" (SINGLE TIMBER) EXCEPT AS NOTED ON THE PLAN. HEIGHT OF TIMBER EDGE WILL VARY BASED ON FIELD CONDITIONS, MAINTAIN 2" MIN. ABOVE FINISH GRADE AT BACK OF TIMBER EDGING.

2. WALLS 3 OR LESS TIMBERS HIGH SHALL BE STAKED AT LEAST EVERY 4' AND HIGHER WALLS SHALL BE STAKED AT LEAST EVERY 2'.

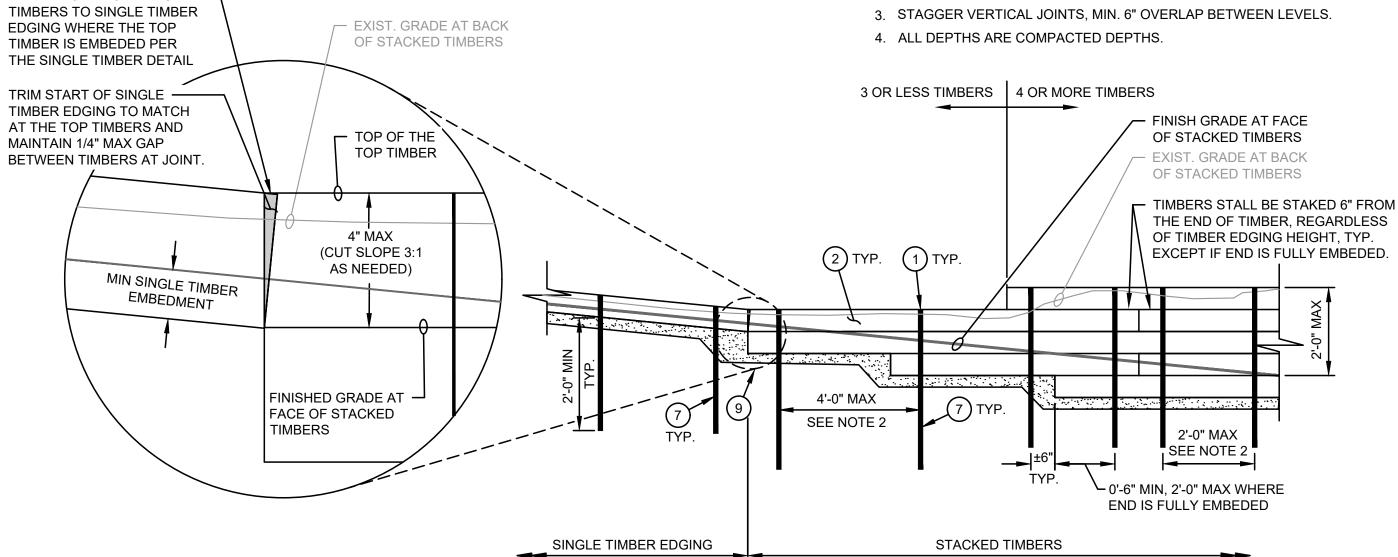

NOT TO SCALE

APPROVAL FOR CONSTRUCTION

DATE: JANUARY 2025

APPROVAL EXPIRES: <u>JANUARY 2026</u>

DRAWING: 8

No. DATE

ISSUED FOR:

ISSUE DATE:

APPROVED BY:

CHECKED BY:

G & O JOB NO.:

DRAWN BY:

REVISION

**BID PLAN SET** 

JAN 2025

23445.02

CON-DET.DWG

TWO INCHES AT FULL SCALE IF NOT, SCALE ACCORDINGLY

CIVIL

CONSTRUCTION

**DETAILS** 

KWB

CJB

MAN

Gray & Osborne, Inc.

3710 168TH STREET NORTHEAST

BUILDING B, SUITE 210

ARLINGTON, WA 98223

(360) 454-5490

YARROW POINT

**TOWN OF** 

YARROW POINT

SALLY'S ALLEY

PHASE 2



**EXISTING ROCKS IN SALLY'S ALLEY** 

PICTURE TAKEN FROM DRIVEWAY AT APPROX. STA. 205+00 LOOKING SOUTHEAST

SUITABLE CONTAINER IN ORDER TO MAINTAIN CLEAN BACKFILL. 2. OPENINGS SHALL BE 'CHINKED' WITH QUARRY SPALLS. GEOTEXTILE FABRIC SHALL BE MODERATE SURVIVABILITY CLASS A PER SECTION 9-33.1 OF THE WSDOT STANDARD SPECIFICATIONS. 4. CONTRACTOR SHALL UTILIZE EXISTING ROCKS ON SITE. SEE IMAGE BELOW. **ROCK WALL DETAIL** NOT TO SCALE

1. QUARRY SPALLS AND CRUSHED SURFACING BASE COURSE

SHALL BE PLACED DIRECTLY FROM TRUCK OR OTHER

ROCK FILTER LAYER, 12" MINIMUM

SIZE SEE NOTE 1.

**GENERAL NOTES:** 

WIDTH QUARRY SPALLS 3/4" TO 4" IN

GEOTEXTILE -

FABRIC


STACKED TIMBER

SINGLE TIMBER TRANSITION FROM STACKED -

TRIM START OF SINGLE — TIMBER EDGING TO MATCH AT THE TOP TIMBERS AND MAINTAIN 1/4" MAX GAP BETWEEN TIMBERS AT JOINT

**TIMBER EDGING** 

BY: TOWN OF YARROW POINT

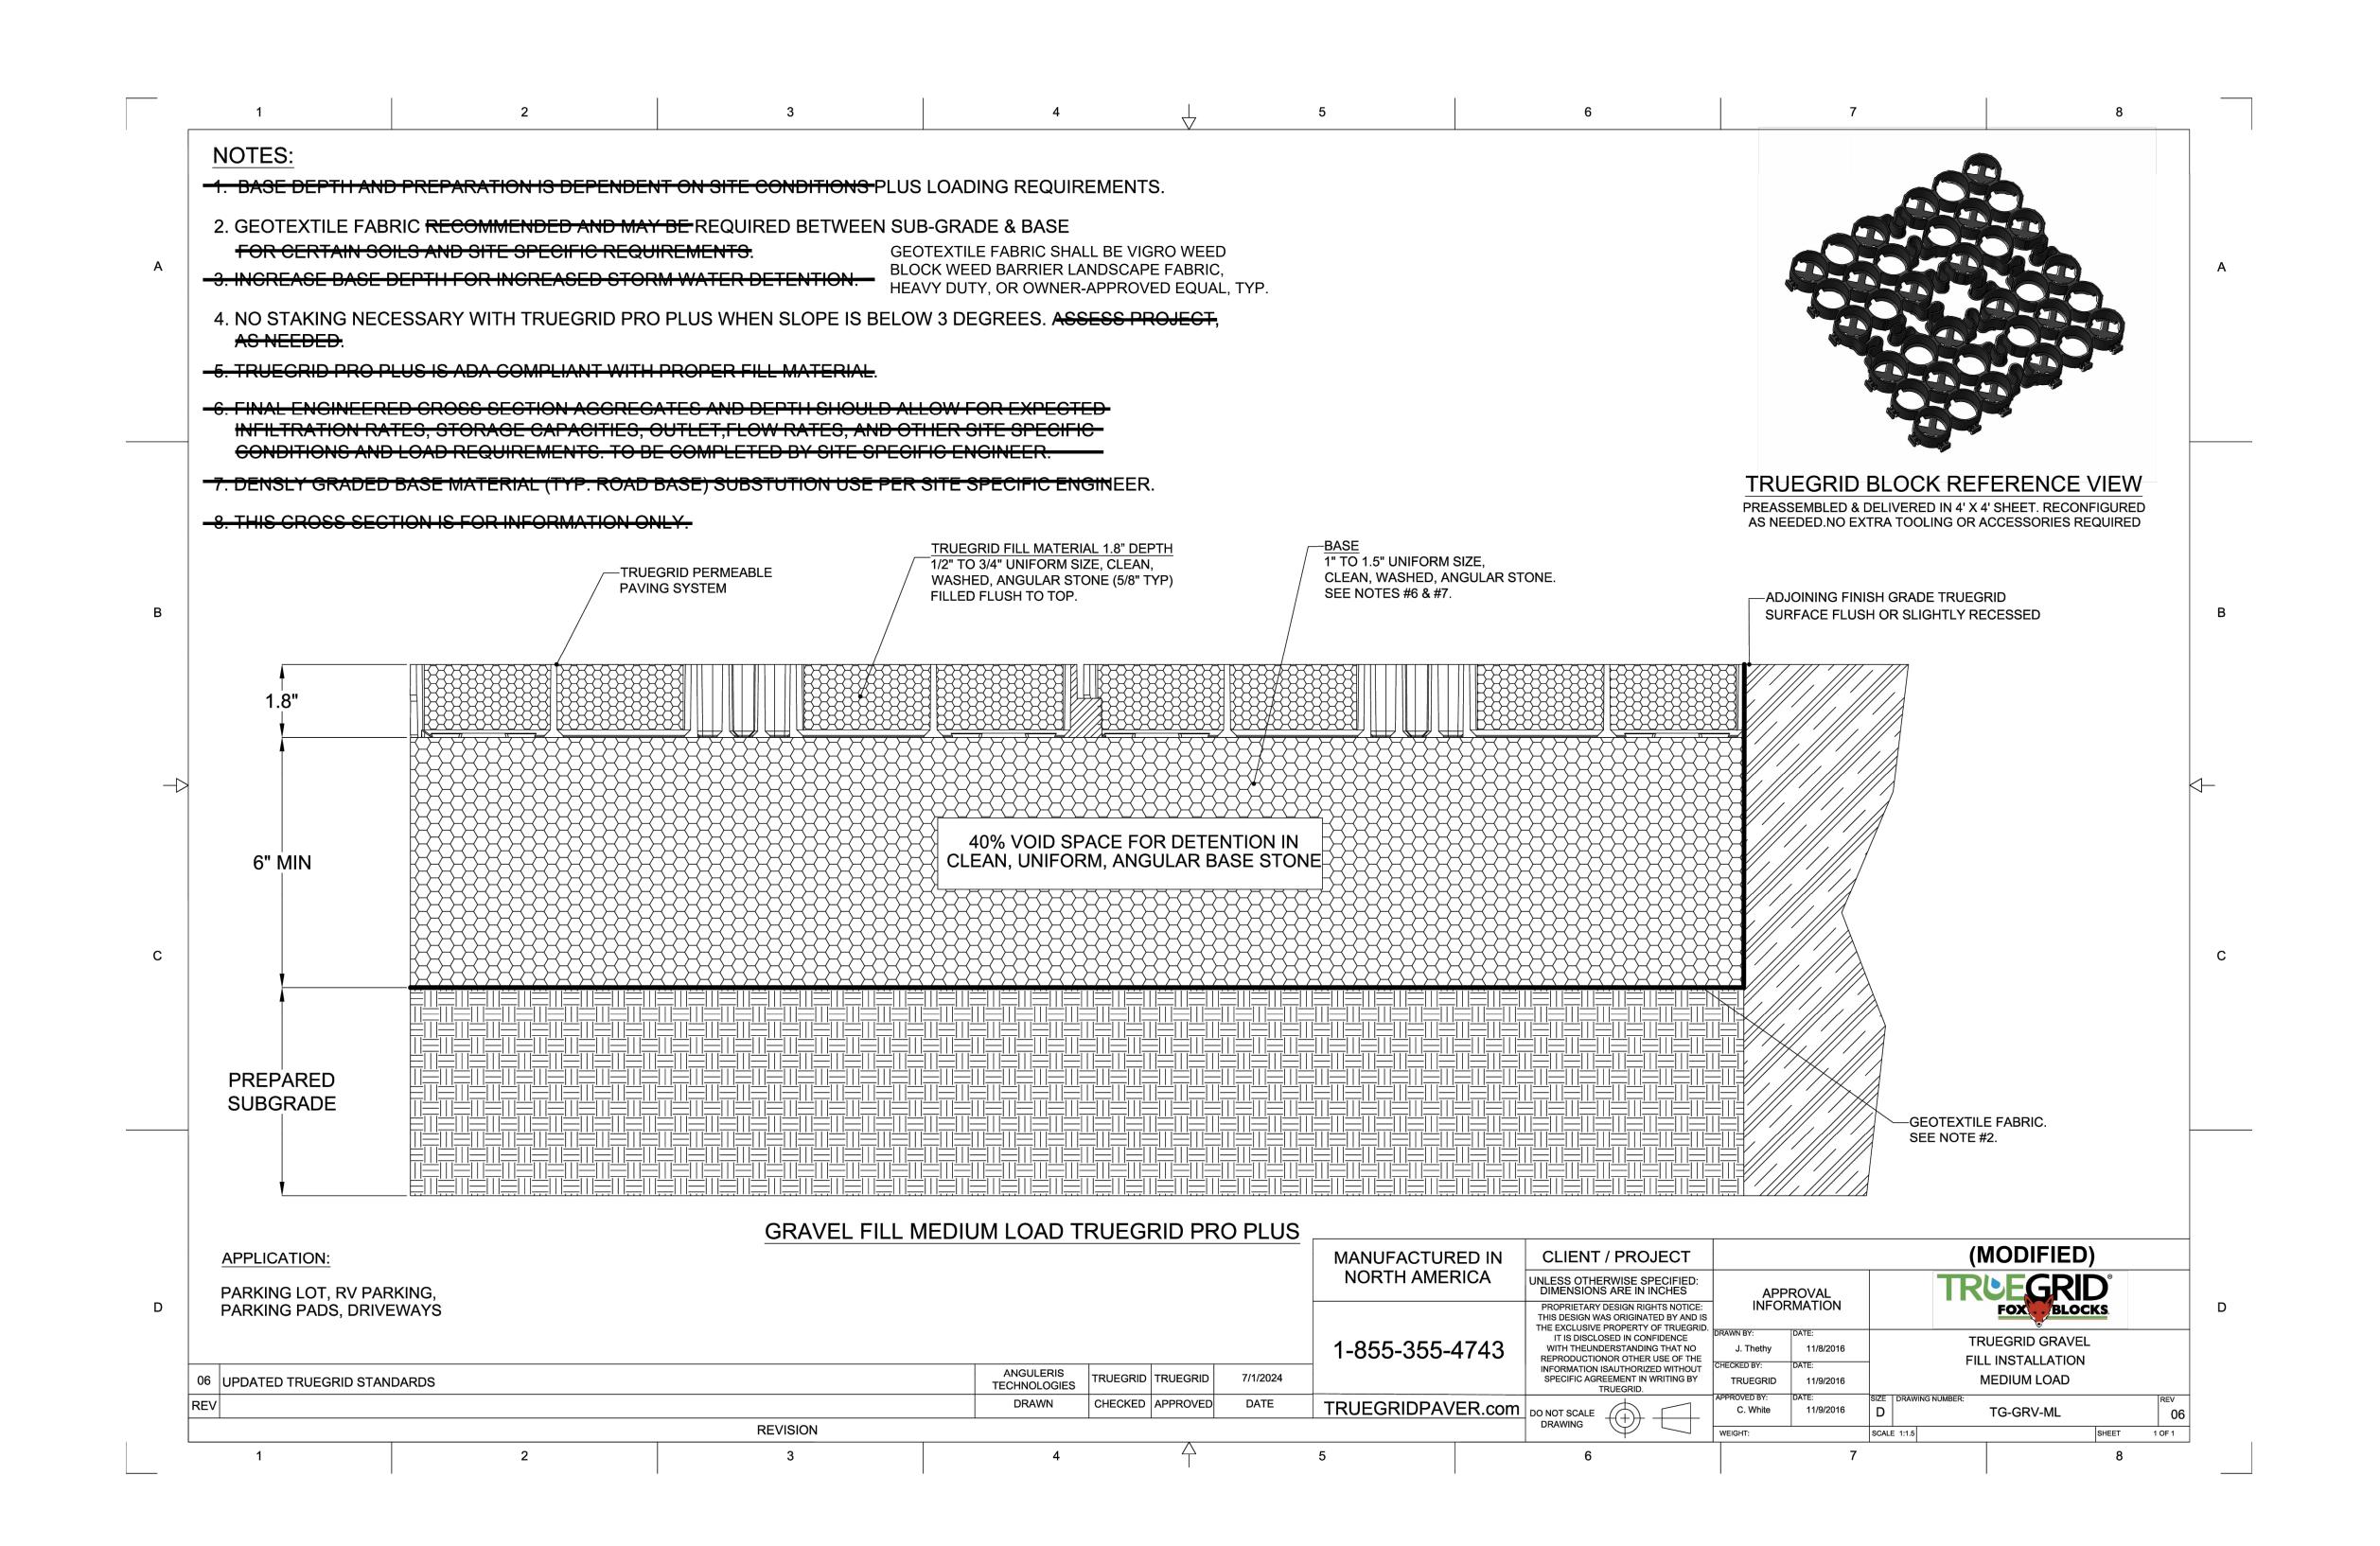

REINFORCED GRAVEL DRIVEWAY DETAIL

NOT TO SCALE

APPROVAL FOR CONSTRUCTION

BY: TOWN OF YARROW POINT

APPROVAL EXPIRES: <u>JANUARY 2026</u>

DATE: JANUARY 2025

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DRAWING: 9 OF: 9

CONSTRUCTION

**DETAILS** 

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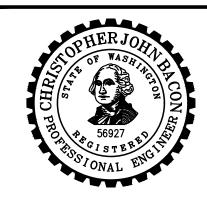
Gray & Osborne, Inc.


CONSULTING ENGINEERS

3710 168TH STREET NORTHEAST,
BUILDING B, SUITE 210
ARLINGTON, WA 98223

(360) 454-5490





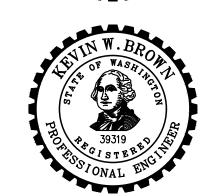

TOWN OF YARROW POINT

SALLY'S ALLEY PHASE 2

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CHECKED BY: CJB
DRAWN BY: MAN

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